#### PIER CAP RETROFIT - CONSTRUCTION SEQUENCE

- 1. IMPLEMENT TRAFFIC CONTROL MEASURES AS NOTED FOR RESPECTIVE PIFR.
- 2. INSTALL SCAFFOLDING INCLUDING CONTAINMENT MEASURES TO PROTECT SURROUNDING AREAS, TRAVELING PUBLIC AND/OR PEDESTRIANS IN THE VICINITY OF THE WORK
- 3. INSTALL SHEAR STUDS TO UNDERSIDE OF STEEL BOX GIRDERS.
  - I. MEDIA BLAST THE UNDERSIDE OF THE EXISTING STEEL PIER CAP TO NEAR-WHITE (SSPC-SP 10/NACE NO. 2) IN THE VICINITY OF THE GROUT PADS PRIOR TO INSTALLATION OF STUDS. PROVIDE CONTAINMENT TO PREVENT BLASTING MEDIA AND DEBRIS FROM IMPACTING THE SURROUNDING AREAS, TRAVELING PUBLIC, OR PEDESTRIANS. REMOVE BLASTING MEDIA AND DEBRIS FROM THE UNDERSIDE OF THE EXISTING PIER CAP PRIOR TO INSTALLATION OF THE STUDS.
  - II. INSTALL SHEAR STUDS USING ELECTRIC ARC STUD WELDING ONLY.

    SUBMIT A SHEAR STUD DETAIL FOR REVIEW AND ACCEPTANCE. HOT

    WELDING OR BOLTED STUDS ARE NOT ACCEPTABLE.
- 4. REMOVE UNSOUND CONCRETE AT SELECTED PIERS, AS NOTED.
  ROUGHEN EXISTING COLUMN AROUND ITS PERIPHERY WITHIN THE LIMITS OF RETROFIT.
- 5. INSTALL FORMWORK, REINFORCEMENT CAGE, DUCTS FOR TENDONS AND TRANSVERSE PT RODS.
- 6. CAST SELF-CONSOLIDATING CONCRETE AS FOLLOWS:
- A. IN COORDINATION WITH AUTHORITY OPERATIONS, IMPLEMENT SLOW ORDER TO LIMIT TRAIN TRAFFIC ON THE STRUCTURE TO 15 MPH.
- B. PLACE SELF-CONSOLDATING CONCRETE IMMEDIATELY PRIOR TO MINIMUM 4 HOUR FULL LINE SHUTDOWN, SCHEDULED SUCH THAT PLACEMENT ACTIVITIES ARE COMPLETED IN TIME TO ALLOW FOR 4 HOURS OF CONCRETE CURING BEFORE LIVE LOAD IS ALLOWED ON THE STRUCTURE.
- C. AFTER 4 HOURS OF CURING LIVE LOAD MAY BE ALLOWED ON THE STRUCTURE UNDER THE SLOW ORDER.
- D. LIFT SLOW ORDER AND ALLOW NORMAL OPERATION OF TRAIN TRAFFIC AFTER SUFFICIENT TIME TO ALLOW THE SELF-CONSOLDATING CONCRETE TO ACHIEVE A COMPRESSIVE STRENGTH OF 2000 PSI.
- 7. AFTER CONCRETE HAS ACHIEVED 80% OF THE SPECIFIED COMPRESSIVE STRENGTH TENSION THE TRANSVERSE PT RODS IN THE SEQUENCE INDICATED.
- 8. INSTALL LONGITUDINAL PT TENDONS.
- 9. AFTER CONCRETE HAS ACHIEVED THE SPECIFIED COMPRESSIVE VALUE INDICATED IN NOTE D.7, TENSION LONGITUDINAL PT TENDONS.
- 10. GROUT TENDONS.
- 11. INSTALL TENDON CAP AND GROUT CAP.
- 12. INSTALL REINFORCEMENT FOR THE CLOSURE POURS.
- 13. CAST SELF—CONSOLIDATING CONCRETE FOR THE CLOSURE POURS AS FOLLOWS:
  - A. IN COORDINATION WITH AUTHORITY OPERATIONS, IMPLEMENT SLOW ORDER TO LIMIT TRAIN TRAFFIC ON THE STRUCTURE TO 15 MPH.
  - B. PLACE SELF—CONSOLDATING CONCRETE IMMEDIATELY PRIOR TO MINIMUM 4 HOUR FULL LINE SHUTDOWN, SCHEDULED SUCH THAT PLACEMENT ACTIVITIES ARE COMPLETED IN TIME TO ALLOW FOR 4 HOURS OF CONCRETE CURING BEFORE LIVE LOAD IS ALLOWED ON THE STRUCTURE.

- C. AFTER 4 HOURS OF CURING LIVE LOAD MAY BE ALLOWED ON THE STRUCTURE UNDER THE SLOW ORDER.
- D. LIFT SLOW ORDER AND ALLOW NORMAL OPERATION OF TRAIN TRAFFIC AFTER SUFFICIENT TIME TO ALLOW THE SELF-CONSOLDATING CONCRETE TO ACHIEVE A COMPRESSIVE STRENGTH OF 2000 PSI.
- 14. REMOVE ALL FORMWORK AND FALSEWORK.
- 15. RECONSTRUCT CURB PIER A5376 ONLY (ROADWAY ITEM).
- 16. REPLACE PORTIONS OF GUARD RAIL AS INDICATED IN ROADWAY PLANS.
- 17. REMOVE TRAFFIC CONTROL MEASURES.
- 18. INSTALL GROUT PADS AS FOLLOWS:
  - A. EMPLOY A SINGLE STAGE GROUTING WHERE NB GROUT PAD AND SB GROUT PAD ARE CAST IN A SINGLE OPERATION (CONSISTENT WITH A DUAL TRACK OUTAGE SITUATION).
    - i. IMPLEMENT TRAFFIC CONTROL MEASURES AS REQUIRED.
    - ii. INSTALL GROUT PAD FORMWORK.
    - iii. DO NO FURTHER WORK UNTIL VEHICULAR LIVE LOAD ON BRIDGE SUPERSTRUCTURE IS RESTRICTED FROM BOTH TRACKS (COORDINATE WITH A.R. FOR A TIME WINDOW TO COMPLETE ACTIVITIES A.iv THRU A.v.)
    - iv. INSTALL NB & SB GROUT PADS.
    - v. AFTER GROUT HAS ACHIEVED STRENGTH OF 4,000 PSI, LIVE LOAD ON STRUCTURE ABOVE GROUTED PADS WILL BE PERMITTED.
    - vi. REMOVE GROUT FORMWORK.
    - vii. INJECT EPOXY AT GROUT/BOX GIRDER INTERFACE AS SPECIFIED.
    - viii. REMOVE ALL TRAFFIC CONTROL MEASURES.
- 19. INSTALL EXISTING GROUT PAD REPAIR AS FOLLOWS:
  - A. IN COORDINATION WITH AUTHORITY OPERATIONS, IMPLEMENT SLOW ORDER TO LIMIT TRAIN TRAFFIC ON THE STRUCTURE TO 15 MPH. (COORDINATE WITH A.R. FOR A TIME WINDOW TO COMPLETE ACTIVITIES A. THRU C.)
  - B. REMOVE EXISTING GROUT PAD MATERIAL UNTIL SOUND MATERIAL IS ENCOUNTERED WITHIN THE LIMITS SHOWN IN THE GROUT PAD REPAIR DETAIL.
  - C. INSTALL REINFORCEMENT AND FORMWORK.
  - E. DO NO FURTHER WORK UNTIL VEHICULAR LIVE LOAD ON BRIDGE SUPERSTRUCTURE IS RESTRICTED FROM BOTH TRACKS (COORDINATE WITH A.R. FOR A TIME WINDOW TO COMPLETE ACTIVITY F.)
  - F. PLACE GROUT FOR THE REPAIR.
  - G. AFTER THE GROUT HAS ACHIEVED A COMPRESSIVE STRENGTH OF 4,000 PSI, LIVE LOAD ON STRUCTURE WILL BE PERMITTED.
  - H. REMOVE GROUT PAD REPAIR FORMWORK.
- I. INJECT EPOXY AT GROUT/BOX GIRDER INTERFACE AS SPECIFIED.
- J. REMOVE ALL TRAFFIC CONTROL MEASURES.

# PIER CAP RETROFIT - SUPPLEMENTAL NOTES

- 1. ALL PIERS: PRIOR TO PREPARATION OF SHOP AND/OR FALSEWORK DRAWINGS:
  - viii. PERFORM FIELD SURVEY SUFFICIENT TO ESTABLISH THE LOCATION OF WP A. AFTER THE LOCATION OF WP A HAS BEEN ESTABLISHED, VERIFY DIMENSIONS A THRU G AND ADJUST AS NECESSARY BASED ON CONTROL DIMENSION 1 AND CONTROL DIMENSION 2. SEE SHEETS A13—S—103 AND A13—S—104.
  - ii. SUBMIT RESULTS OF SURVEY IN TABULAR FORM.
  - iii. WITH SUBMISSION, EITHER CONFIRM DIMENSIONS E, G AND V OR INDICATE REVISED DIMENSIONS CONSISTENT WITH SURVEY.
  - iv. BASE LONGITUDINAL TENDON AND REBAR DIMENSIONS ON RESULTS OF SURVEY.
  - v. WITH SUBMISSION, LIST THE ACTUAL VERTICAL CLEARANCES THAT WILL BE CONSTRUCTED FOR PIERS A5447, A5435 AND A5403. NOTE IF ANY OF THESE CLEARANCES WILL BE LESS THAN 16'-9", AND IF SO, REQUEST DIRECTION FROM THE A.R. BEFORE PROCEEDING WITH SHOP/OR ERECTION DRAWINGS FOR THE RESPECTIVE PIERS.
  - vi. WITH SUBMISSION, LIST THE ACTUAL HORIZONTAL CLEARANCES THAT WILL BE CONSTRUCTED FROM THE EDGE OF ALL APPLICABLE CORNERS OF THE RETROFIT TO THE EDGE OF THE CURB LINES FOR PIERS A5403, A5392 AND A5376.

    NOTE IF ANY OF THESE CLEARANCES WILL BE LESS THAN 6" AND IF SO, REQUEST DIRECTION FROM THE A.R. BEFORE PROCEEDING WITH SHOP/OR ERECTION DRAWINGS FOR THIS PIER.
  - vii. DO NOT PREPARE SHOP AND/OR FALSEWORK DRAWINGS UNTIL OWNER REVIEWS AND ACCEPTS ANY REVISIONS TO DIMENSIONS INDICATED ON THE DRAWINGS.
- 2. ALL PIERS: PRIOR TO PREPARATION OF FALSEWORK DRAWINGS:
  - a. CONTACT UTILITIES AND LOCATE ALL UTILITIES IN IMMEDIATE VICINITY OF PIER CAP RETROFITS.
  - b. WHERE UTILITIES MAY BE IN CONFLICT WITH FALSEWORK OR CONSTRUCTION OPERATIONS, SUBMIT PLAN INFORMATION WITH UTILITIES APPROPRIATELY MARKED.
  - c. BASE FALSEWORK DESIGN ON LOCATION OF EXISTING UTILITIES.
- 3. MAINTAIN 16'-0" VERTICAL CLEARANCE FROM THE BOTTOM OF ALL FORMWORK, FALSEWORK, WORK PLATFORMS, CONSTRUCTION EQUIPMENT AND ALL OTHER TEMPORARY CONSTRUCTION APPURTENANCES DURING CONSTRUCTION. PROTECT ALL FORMWORK, FALSEWORK, WORK PLATFORMS, CONSTRUCTION EQUIPMENT AND ALL OTHER TEMPORARY CONSTRUCTION APPURTENANCES ADJACENT TO MD SHA ROADWAYS AND SHOULDERS WITH < 16'-0" OF VERTICAL CLEARANCE WITH A CRASHWORTHY BARRIER.
- 4. PIER A5447: CONSTRUCT FALSEWORK AND EXECUTE WORK IN A MANNER TO AVOID DISTURBANCE OF EXISTING DECORATIVE WALL AND ADJACENT PLANTINGS.
- 5. PIER A5435: CONSTRUCT FALSEWORK AND EXECUTE WORK IN A MANNER TO AVOID DISTURBANCE OF EXISTING CURB, GUARD RAIL, AND SIDEWALK AND TO MINIMIZE DISTURBANCE TO ADJACENT PLANTINGS. PROTECT CONSTRUCTION WORK ZONE FROM PEDESTRIANS. PROVIDE AN ALTERNATIVE WALKWAY FOR PEDESTRIANS DURING RETROFIT OPERATIONS. REPAIR, TO SATISFACTION OF OWNER, ANY CURB, GUARD RAIL AND/OR SIDEWALK ELEMENTS DAMAGED IN THE COURSE OF OPERATIONS. REPLACE PORTIONS OF GUARD RAIL AS INDICATED IN

ROADWAY PLANS.

- 6. PIERS A5403, A5392 A5376, A5366: CONSTRUCT FALSEWORK AND EXECUTE WORK IN A MANNER TO AVOID DISTURBANCE OF EXISTING CURB, GUARD RAIL, SIGNAGE, POLES (SUPPORTING PEDESTRIAN LIGHTS AND CAMERAS), AND IMPACT ATTENUATORS. REPAIR, TO SATISFACTION OF OWNER, ANY CURB, GUARD RAIL, SIGNAGE, POLES AND/OR IMPACT ATTENUATOR ELEMENTS DAMAGED IN THE COURSE OF OPERATIONS. REPLACE PORTIONS OF GUARD RAIL AS INDICATED IN ROADWAY PLANS.
- 7. PIERS A5376, A5366, A5356, A5345, A5335, A5324, A5313, A5302, A5290: CONSTRUCT FALSEWORK AND EXECUTE WORK IN A MANNER TO AVOID DISTURBANCE OF THE EXISTING MAINTENANCE ROADWAY LOCATED BETWEEN GROSVENOR AVENUE AND PIER A5290 IN THE MEDIAN OF ROCKVILLE PIKE (MD 355). REPAIR, TO SATISFACTION OF OWNER, ANY MAINTENANCE ROADWAY ELEMENTS DAMAGED IN THE COURSE OF OPERATIONS.
- 8. PIER A5392: RELOCATE CONDUIT, JUNCTION BOX AND WIRING THAT ENERGIZES THE TRAFFIC SIGNAL HEADS SUPPORTED BY THE SUPERSTRUCTURE PRIOR TO INSTALLATION OF FORMWORK.
- 9. PIER A5376: RECONSTRUCT PORTION OF EAST CURB, ROCKVILLE PIKE SB, CONCURRENT WITH PIER CAP RETROFIT.
- 10. PIERS A5356, A5324: CONSTRUCT FALSEWORK AND EXECUTE WORK IN A MANNER TO AVOID DISTURBANCE OF EXISTING ROCKVILLE PIKE SB LATERAL DRAINAGE SYSTEM (PIPES, ENCASEMENT AND SLOPE DRAINAGE). REPAIR, TO SATISFACTION OF OWNER, ANY ELEMENTS OF THE DRAINAGE SYSTEM DAMAGED IN THE COURSE OF OPERATIONS.
- 11. ALL PIERS: CONSTRUCT FALSEWORK AND EXECUTE WORK IN A MANNER TO AVOID DISTURBANCE OF EXISTING DRAINAGE OUTLET SYSTEM. REPAIR, TO SATISFACTION OF OWNER, ANY ELEMENTS OF THE OUTLET SYSTEM DAMAGED IN THE COURSE OF OPERATIONS. REMOVAL OF ANY PORTION OF THE OUTLET SYSTEM IS PROHIBITED.
- 12. PIERS A5279, A5238, A5212, A5186: CONSTRUCT FALSEWORK AND EXECUTE WORK IN A MANNER TO AVOID DISTURBANCE OF EXISTING GUARD RAIL. IMMEDIATELY REPAIR, TO SATISFACTION OF OWNER, ANY GUARD RAIL ELEMENTS DAMAGED IN THE COURSE OF OPERATIONS.
- 13. PIERS A5238, A5212: CONSTRUCT FALSEWORK AND EXECUTE WORK IN A MANNER TO AVOID DISTURBANCE OF OR IMPOSITION OF LOAD ON EXISTING DRAINAGE SYSTEM (INCLUDING PIPING, CHANNELS AND PROTECTIVE FENCING). IMMEDIATELY REPAIR, TO SATISFACTION OF OWNER, ANY DRAINAGE ELEMENTS DAMAGED IN THE COURSE OF OPERATIONS.
- 14. PIERS A5238, A5212, A5186: CONSTRUCT FALSEWORK WITH ADEQUATE CLEARANCE TO ANY GUARD RAIL AND SUPPORT BARRIERS ADJACENT TO INTERSTATE HIGHWAY TO THE EXTENT THAT FALSEWORK IMPOSES NO LOADING ON THESE ELEMENTS.
- 15. PIERS A5366, A5324, A5240: REMOVE UNSOUND CONCRETE PRIOR TO SURFACE ROUGHENING. (SEE DETAIL SHEET A13-S-104.) ROUGHEN REMAINING SURFACES WITHIN LIMIT OF RETROFIT THAT HAVE NOT HAD UNSOUND CONCRETE REMOVED.

PROFESSIONAL CERTIFICATION. I HEREBY CERTIFY THAT THESE DOCUMENTS WERE PREPARED OR APPROVED BY ME, AND THAT I AM A DULY LICENSED PROFESSIONAL ENGINEER UNDER THE LAWS OF THE STATE OF MARYLAND, LICENSE NO. 24077, EXPIRATION DATE 02-24-2015

FQ15093



APPROVED

## WASHINGTON METROPOLITAN AREA TRANSIT AUTHORITY

DEPARTMENT OF TRANSIT INFRASTRUCTURE
AND ENGINEERING SERVICES
OFFICE OF INFRASTRUCTURE RENEWAL PROGRAM

A Gannett Fleming/Parsons
JOINT VENTURE

BRAD MASON

PROJECT MANAGER

RED LINE REHABILITATION GROSVENOR AERIAL STRUCTURE

PIER CAP RETROFIT CONSTRUCTION SEQUENCE

 SCALE
 DRAWING NO.

 NO SCALE
 A13-S-002

M1272-119

|                                    | APPRO | XIMATE | QUANTI   | ITIES - P | IER CAP       | RETRO | FIT AND | DECK J | OINT RE | PLACEN | IENT  |       |       |       |       |
|------------------------------------|-------|--------|----------|-----------|---------------|-------|---------|--------|---------|--------|-------|-------|-------|-------|-------|
|                                    |       |        | LOCATION |           |               |       |         |        |         |        |       |       |       |       |       |
| ITEM                               | UNIT  | A5460  | A5447    | A5435     | A5419         | A5403 | A5392   | A5376  | A5366   | A5356  | A5345 | A5335 | A5324 | A5313 | A5302 |
| SELF CONSOLIDATING CONCRETE        | CY    |        | 30       | 33        |               | 35    | 35      | 38     | 30      | 30     | 30    | 30    | 30    | 30    | 30    |
| CONCRETE REINFORCEMENT             | LB    |        | 5800     | 6200      | ()            | 6600  | 6600    | 7000   | 5600    | 5600   | 5800  | 5800  | 5800  | 5800  | 5800  |
| CONCRETE POST TENSIONING (1)       | EA    |        | 1        | 1         | i <b>==</b> . | 1     | 1       | 1      | 1       | 1      | 1     | 1     | 1     | 1     | 1     |
| NON-METALLIC NON-SHRINK GROUTING   | CY    |        | 4        | 4         |               | 5     | 5       | 5      | 3       | 3      | 3     | 3     | 4     | 4     | 4     |
| FABRICATED STRUCTURAL STEEL (2)    | LB    |        | 4800     | 5000      |               | 5200  | 5400    | 5000   | 4800    | 4800   | 4800  | 5000  | 5000  | 5000  | 5000  |
| COMPRESSION SEAL WITH JOINT SEALER | LF    | 42     | 68       | 60        | 60            | 60    | 70      | 64     | 64      | 64     | 64    | 64    | 64    | 64    | 64    |
| BEARING REPLACEMENT                | EA    | 4      | 8        |           |               | (     |         | >      |         |        | ()    |       | 8     |       |       |
| EPOXY RESIN CONCRETE SEALER        | SY    | 62     | 35       | 35        |               | 35    | 35      | 35     | 35      | 35     | 35    | 35    | 35    | 35    | 35    |
| DRAINAGE RETROFIT                  | EA    |        | 1        | 1         | 1             | 1     | 1       | 1      | 1       | 1      | 1     | 1     | 1     | 1     | 1     |

| APP                                | ROXIM | ATE QUA   | ANTITIES | 6 - PIER | CAP RE | TROFIT A | AND DEC | CK JOINT | REPLA | CEMENT | -     |       |       |        |
|------------------------------------|-------|-----------|----------|----------|--------|----------|---------|----------|-------|--------|-------|-------|-------|--------|
|                                    |       |           |          | LOCATION |        |          |         |          |       |        |       | TOTAL |       |        |
| ITEM                               | UNIT  | A5290 (3) | A5279    | A5268    | A5258  | A5248    | A5238   | A5225    | A5212 | A5199  | A5186 | A5225 | A5162 | TOTAL  |
| SELF CONSOLIDATING CONCRETE        | CY    |           | 30       | 30       | 30     | 30       | 34      |          | 30    | 30     | 30    |       |       | 625    |
| CONCRETE REINFORCEMENT             | LB    |           | 5800     | 5800     | 5800   | 5800     | 6400    |          | 5800  | 5800   | 5800  |       |       | 119400 |
| CONCRETE POST TENSIONING (1)       | EA    |           | 1        | 1        | 1      | 1        | 1       |          | 1     | 1      | 1     |       |       | 20     |
| NON-METALLIC NON-SHRINK GROUTING   | CY    |           | 4        | 4        | 4      | 4        | 5       |          | 4     | 4      | 4     |       |       | 80     |
| FABRICATED STRUCTURAL STEEL (2)    | LB    |           | 5000     | 5000     | 5000   | 5000     | 5400    |          | 5000  | 5000   | 5000  | 1     |       | 100200 |
| COMPRESSION SEAL WITH JOINT SEALER | LF    |           | 62       | 60       | 60     | 62       | 62      | 64       | 62    | 62     | 60    | 62    | 32    | 1520   |
| BEARING REPLACEMENT                | EA    |           |          | ::       |        | 1        |         |          | 8     | 31     | 1     | 1     |       | 28     |
| EPOXY RESIN CONCRETE SEALER        | SY    |           | 35       | 35       | 35     | 35       | 35      |          | 35    | 35     | 35    |       |       | 762    |
| DRAINAGE RETROFIT                  | EA    | 1         | 1        | 1        | 1      | 1        | 1       | 1        | 1     | 1      | 1     | 1     |       | 24     |

<sup>(1)</sup> INCLUDES 4 LONGITUDINAL POST-TENSIONING TENDONS, ALL RELATED HARDWARE, 12 TRANSVERSE POST-TENSIONING BARS, SLEEVES AND RELATED HARDWARE. SEE PROJECT SPECIFICATIONS FOR POST-TENSIONING TENDON MOCKUP.

PROFESSIONAL CERTIFICATION. I HEREBY CERTIFY THAT THESE DOCUMENTS WERE PREPARED OR APPROVED BY ME, AND THAT I AM A DULY LICENSED PROFESSIONAL ENGINEER UNDER THE LAWS OF THE STATE OF MARYLAND, LICENSE NO. 24077, EXPIRATION DATE 02-24-2015

FQ15093

DESIGNED JBR 1-30-14 DATE

DRAWN CJP 1-30-14 DATE

CHECKED ESN 11-14-14 DATE

APPROVED ESN 11-14-14 DATE



APPROVED -

# WASHINGTON METROPOLITAN AREA TRANSIT AUTHORITY

DEPARTMENT OF TRANSIT INFRASTRUCTURE
AND ENGINEERING SERVICES
OFFICE OF INFRASTRUCTURE RENEWAL PROGRAM



PROJECT MANAGER

| RED LINE REHABILITATION    |          |
|----------------------------|----------|
| GROSVENOR AERIAL STRUCTURE | <u>_</u> |
|                            |          |

QUANTITIES

DRAWING NO.


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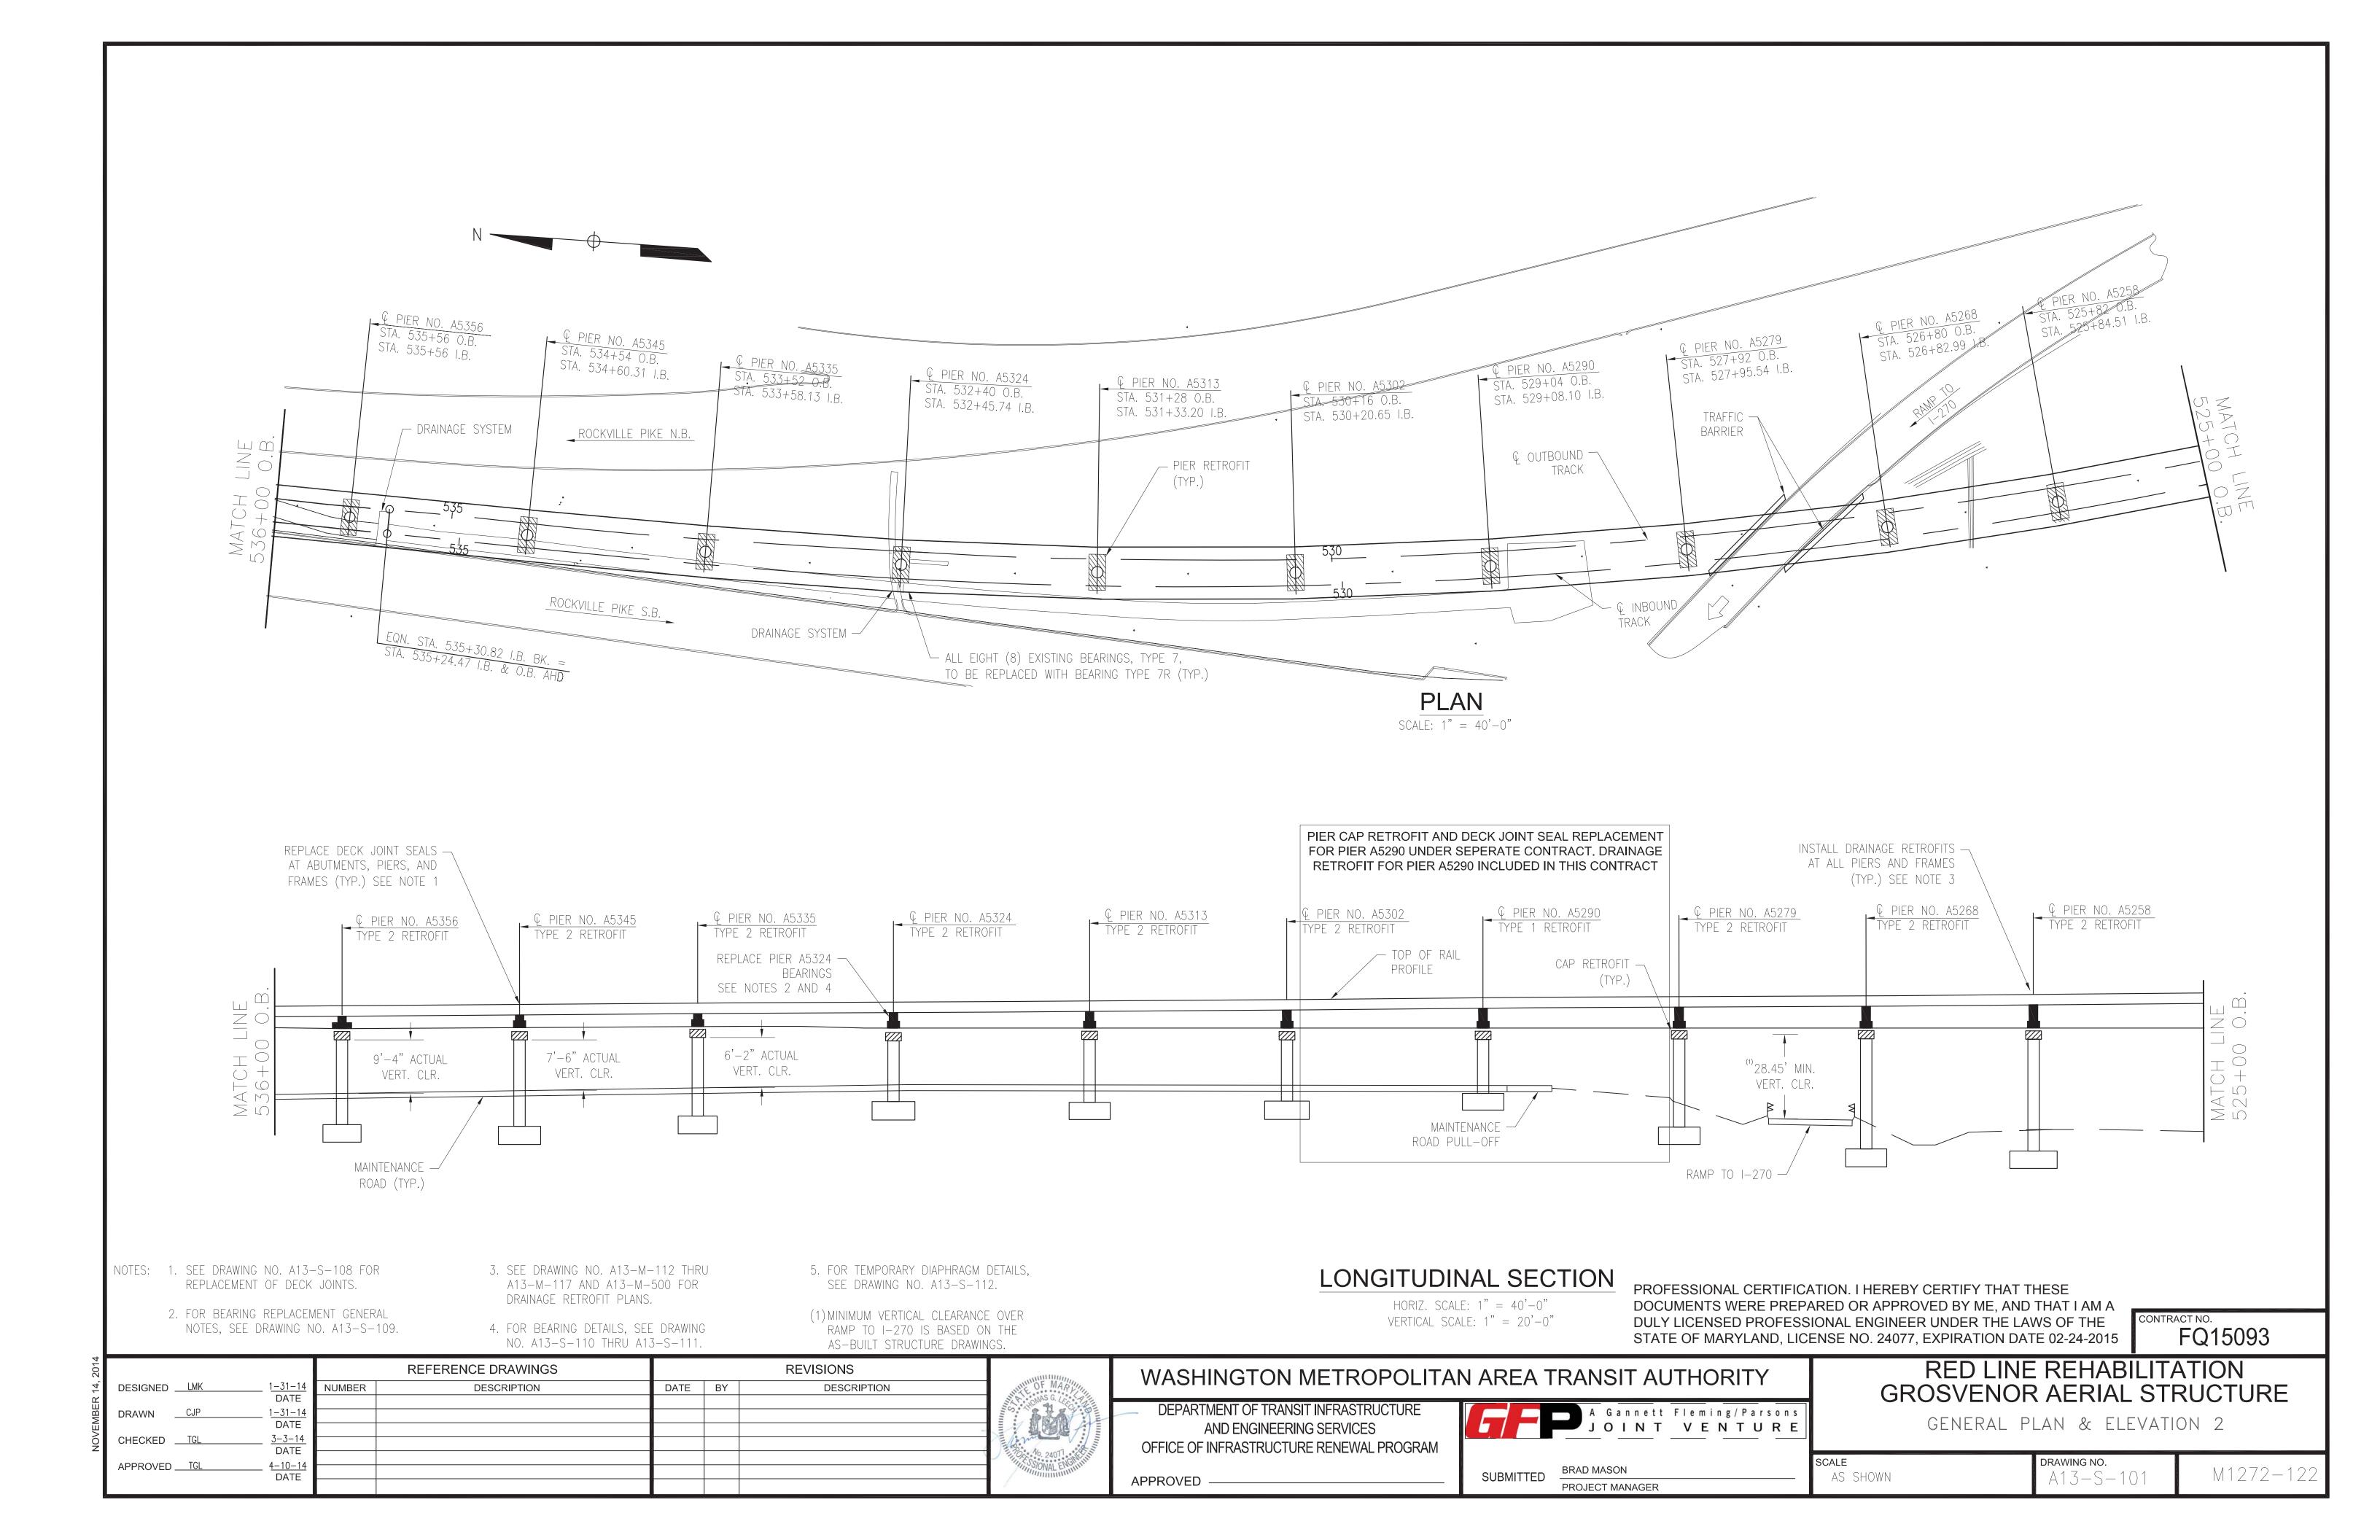
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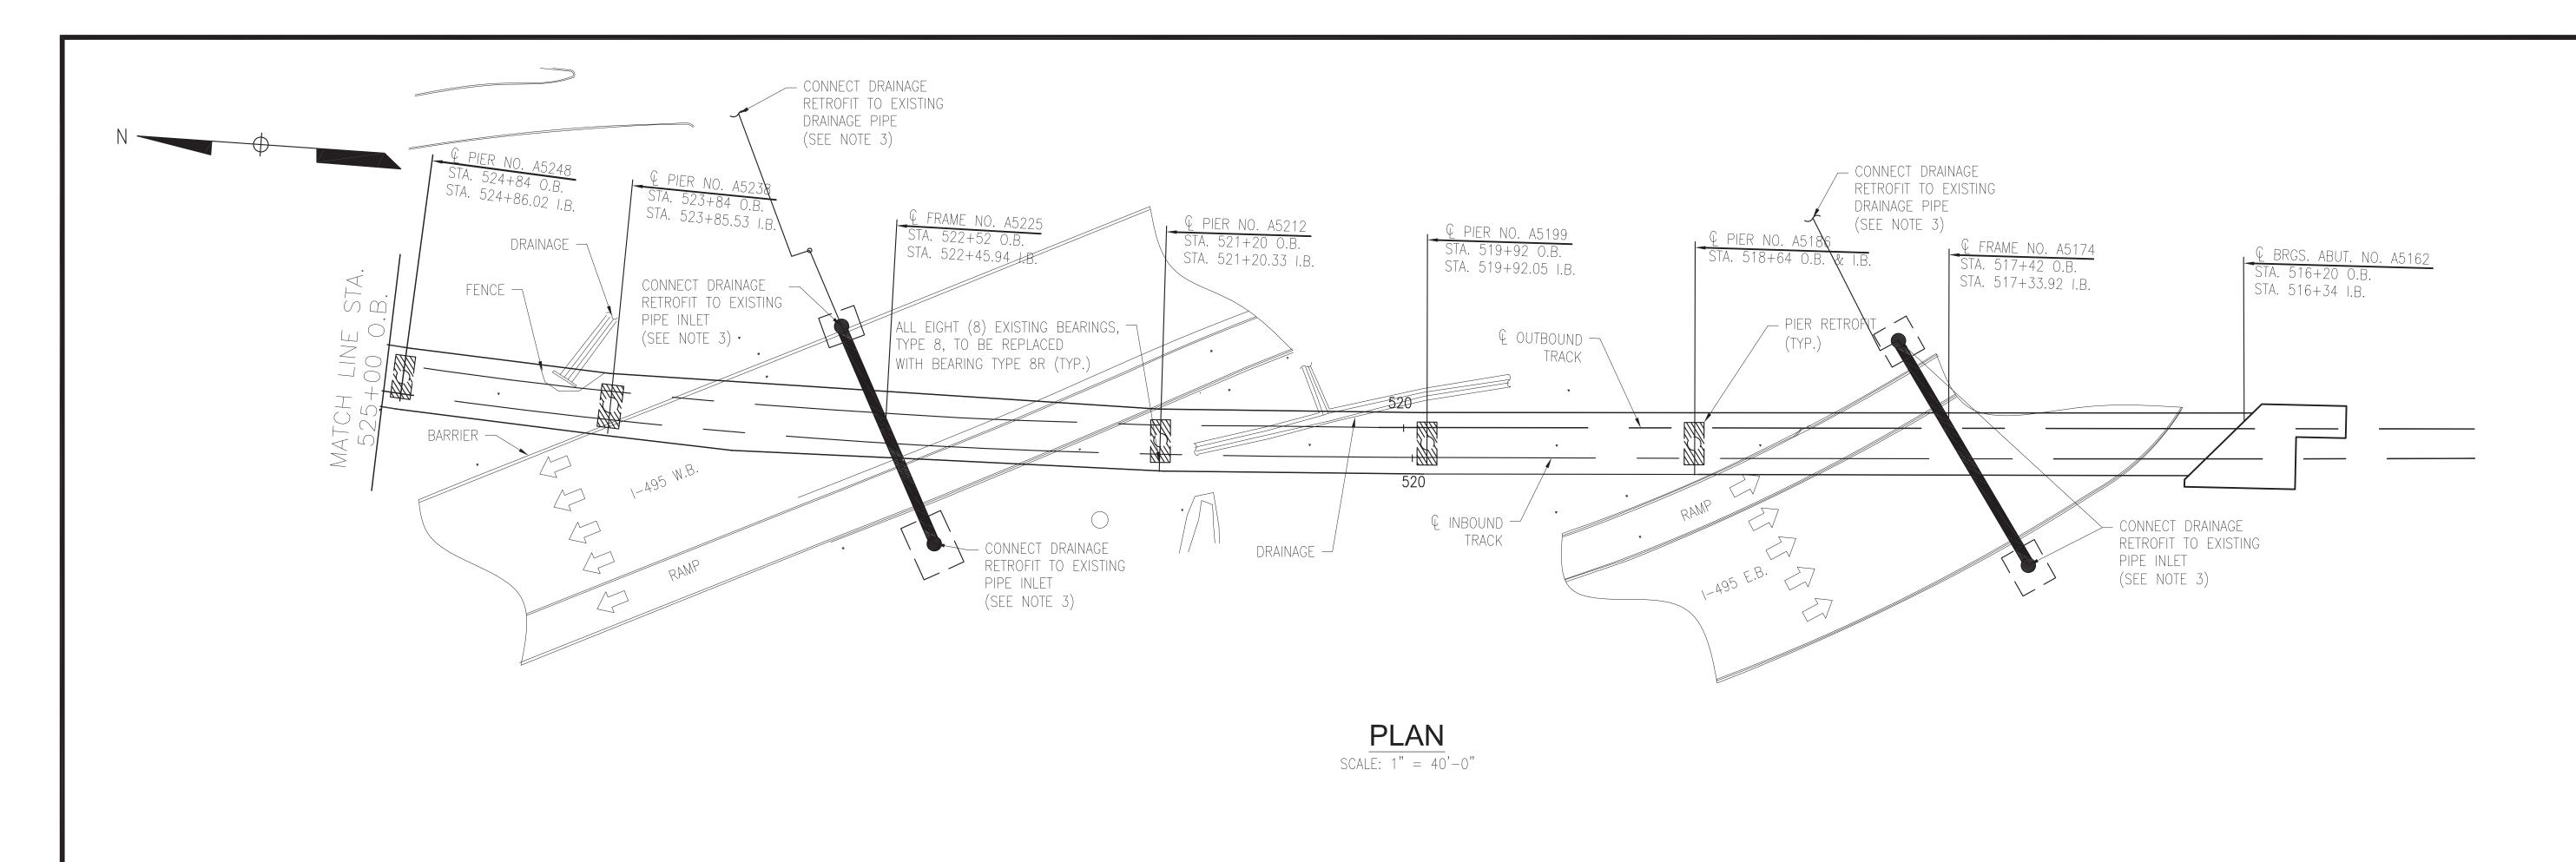
M1272-120


<sup>(2)</sup> INCLUDES CLAMPING PLATE ASSEMBLY AND SHEAR STUDS.

<sup>(3)</sup> CONSTRUCTION OF PIER CAP RETROFIT (INCLUDING ALL COMPONENTS) AND JOINT REPLACEMENT COMPLETED UNDER J.O.C CONTRACT. DRAINAGE RETROFIT NOT COMPLETED UNDER J.O.C CONTRACT.





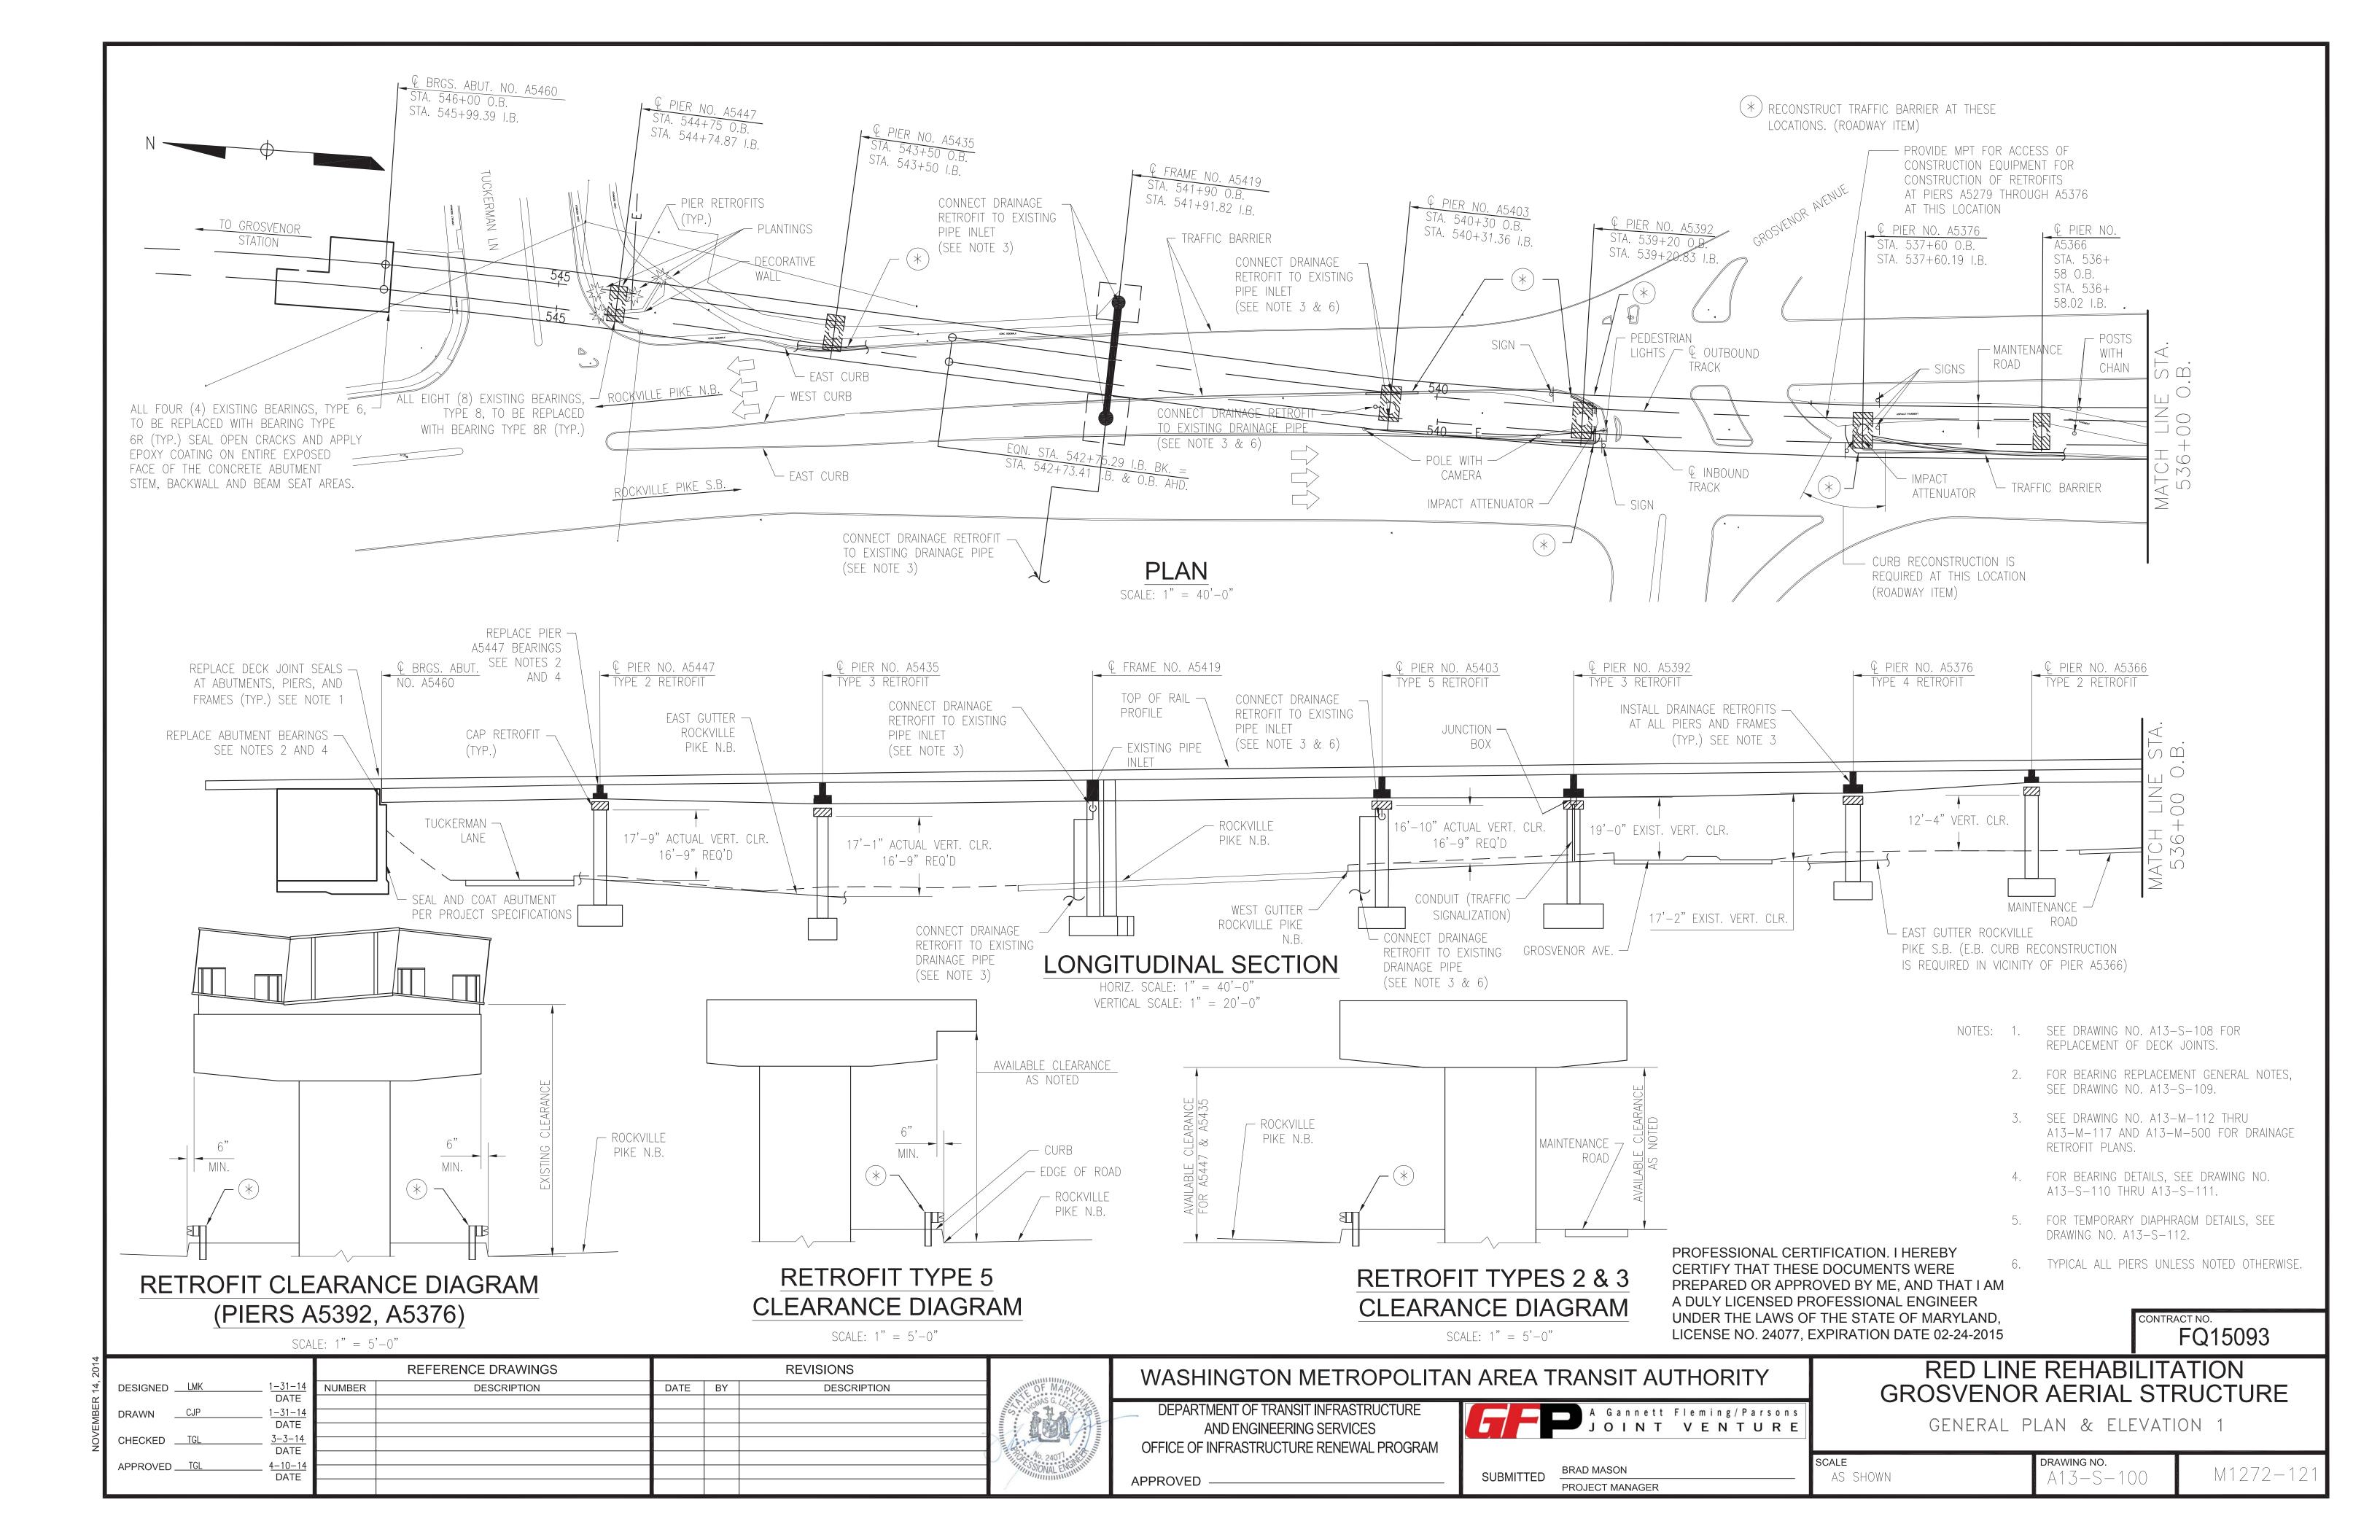

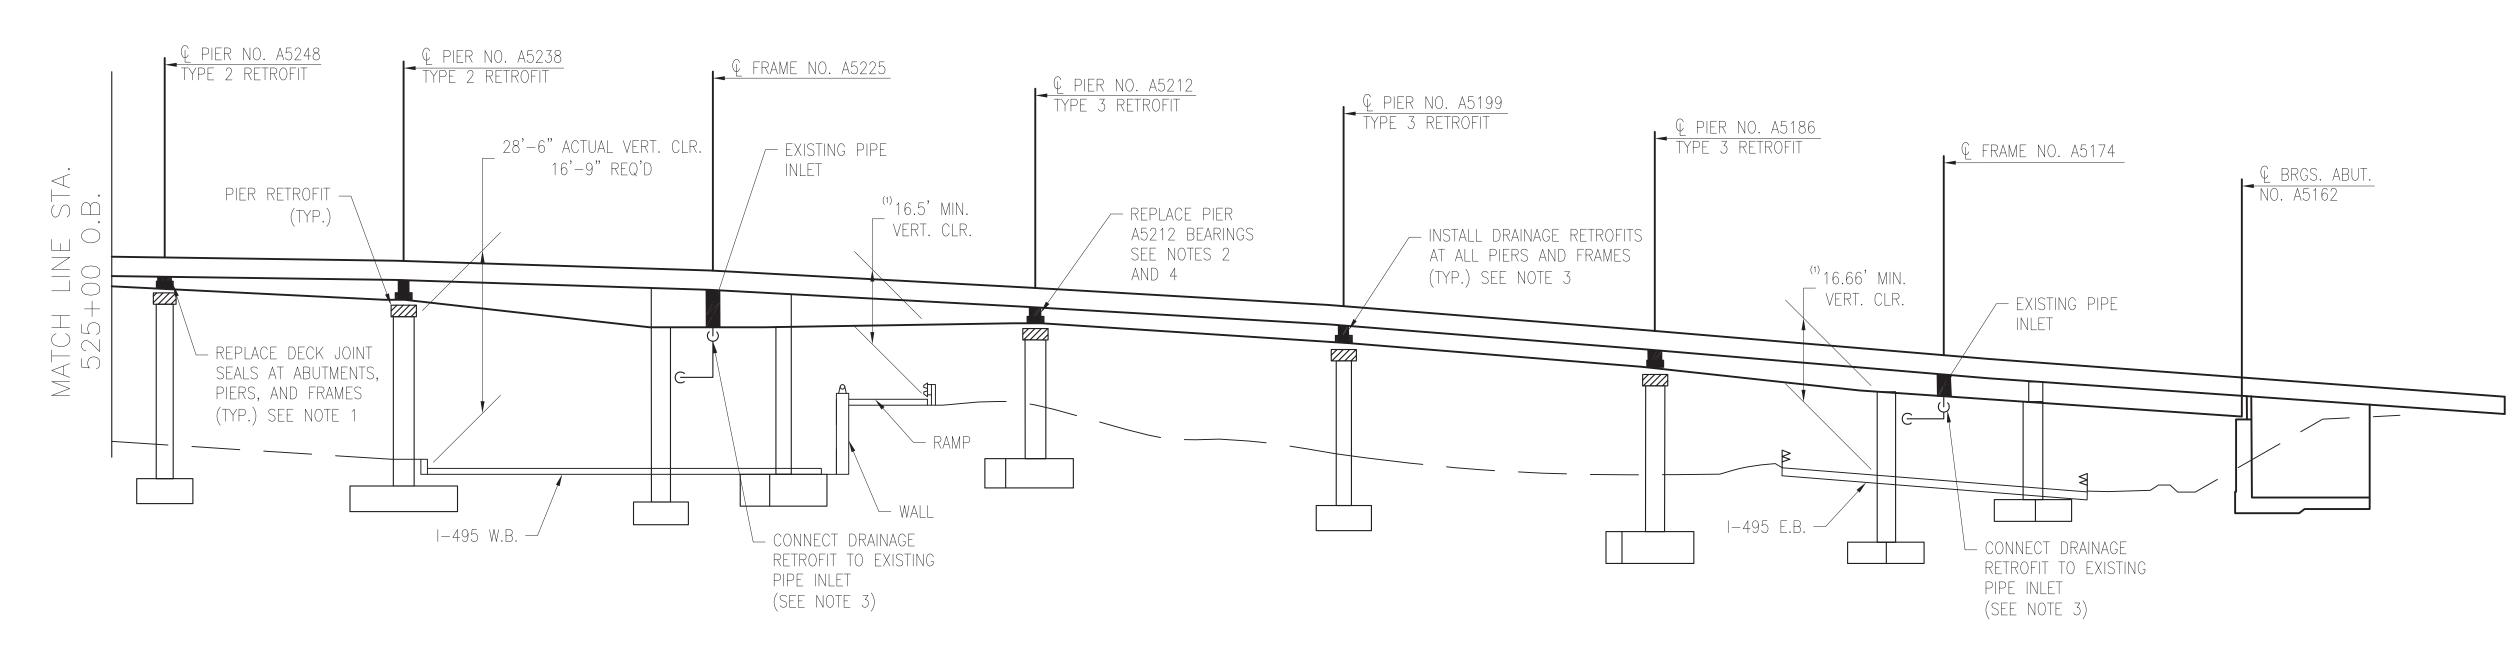

- NOTES: 1. SEE DRAWING NO. A13-S-108 FOR REPLACEMENT OF DECK JOINTS.
  - 2. FOR BEARING REPLACEMENT GENERAL NOTES, SEE DRAWING NO. A13-S-109.
  - 3. SEE DRAWING NO. A13-M-112 THRU A13-M-117 AND A13-M-500 FOR DRAINAGE RETROFIT PLANS.
- 4. FOR BEARING DETAILS, SEE DRAWING NO. A13-S-110 THRU A13-S-111.
- 5. FOR TEMPORARY DIAPHRAGM DETAILS, SEE DRAWING NO. A13-S-112.
- (1) MINIMUM VERTICAL CLEARANCE OVER I-495 E.B., W.B., AND RAMPS ARE BASED ON THE AS-BUILT STRUCTURE DRAWINGS.

# LONGITUDINAL SECTION

HORIZ. SCALE: 1" = 40'-0"VERTICAL SCALE: 1" = 20'-0"

APPROVED

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FQ15093

| 2014     |                     |                          |        | REFERENCE DRAWINGS |      |    | REVISIONS  | Sin.      |
|----------|---------------------|--------------------------|--------|--------------------|------|----|--|-----------|
| R 14,    | DESIGNED <u>LMK</u> | _ <u>1-31-14</u><br>DATE | NUMBER | DESCRIPTION        | DATE | BY | DESCRIPTION  | WHITE OF  |
| NOVEMBER | DRAWN <u>CJP</u>    | 1-31-14<br>DATE          |        |                    |      |    |  | Sold      |
| NOVE     | CHECKED TGL         | <u>3-3-14</u><br>DATE    |        |                    |      |    | -  | The same  |
|          | APPROVED TGL        | 4-10-14<br>DATE          |        |                    |      |    | A Company of the Comp | SION SION |
|          |                     |                          |        |                    |      |    |  | 1         |




RED LINE REHABILITATION
GROSVENOR AERIAL STRUCTURE
GENERAL PLAN & ELEVATION 3


GENERAL PLAN & ELEVATION 3

BRAD MASON
PROJECT MANAGER

SCALE
AS SHOWN
AS SHOWN

DRAWING NO.
A13-S-102
M1272-123

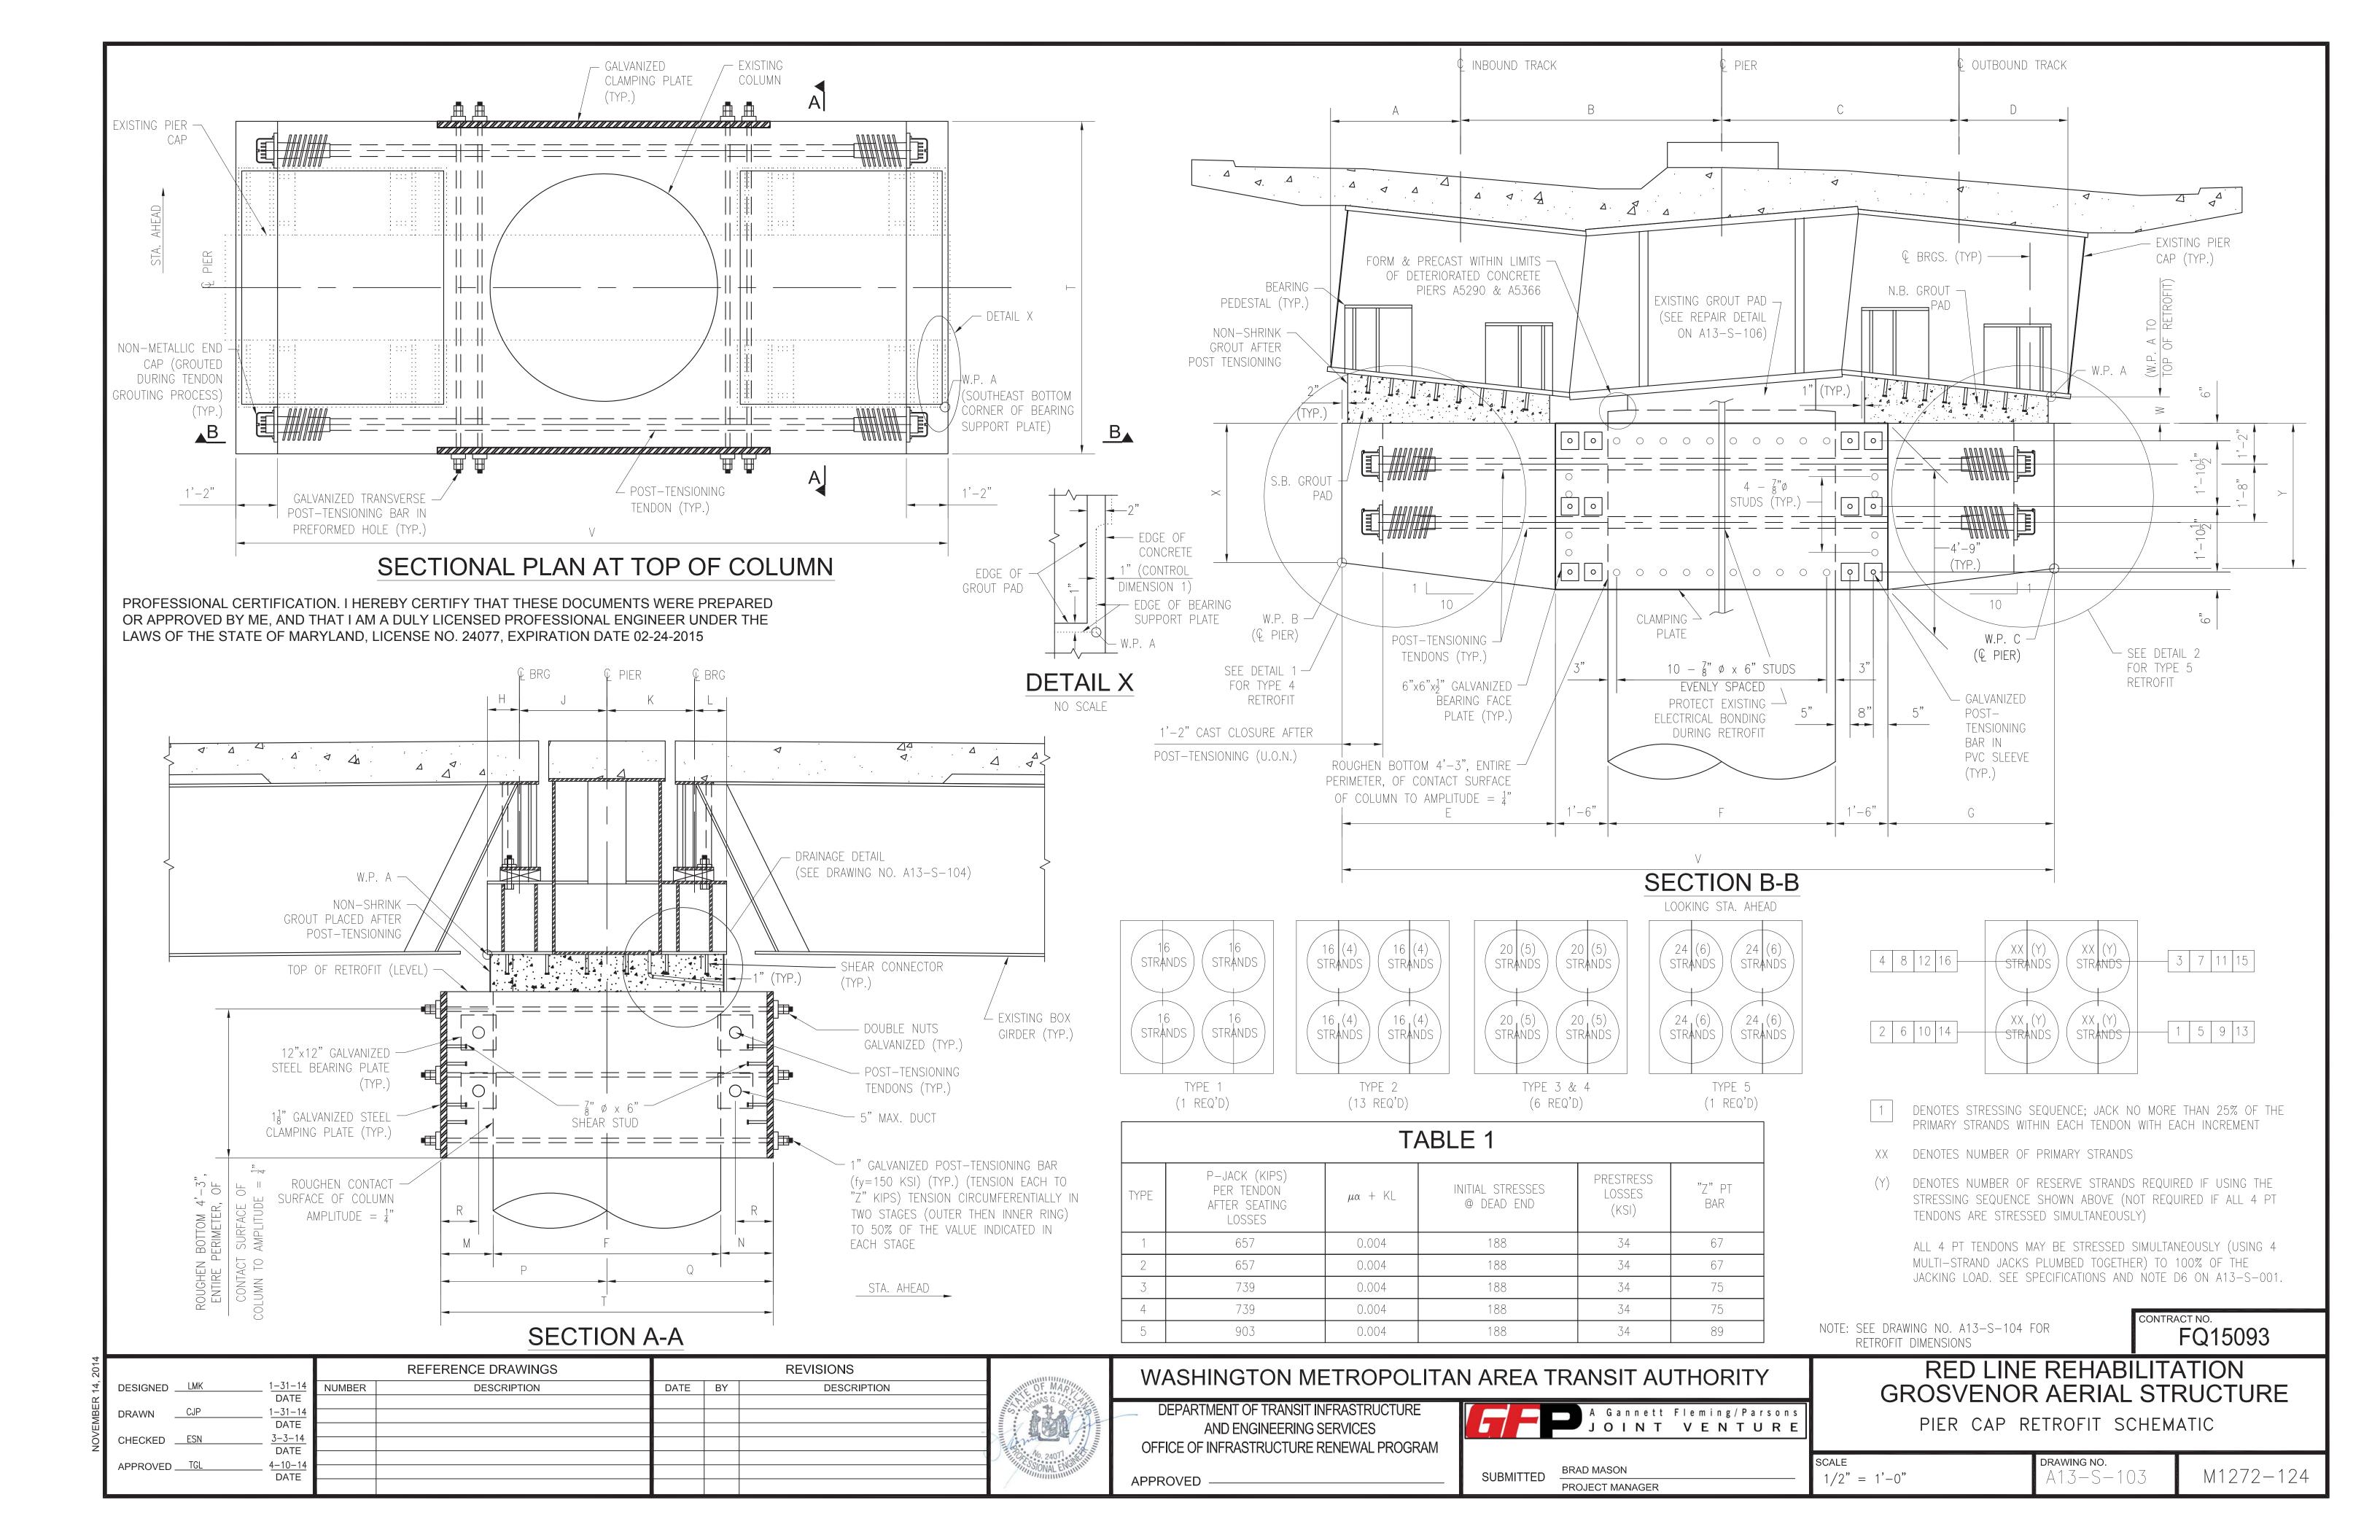

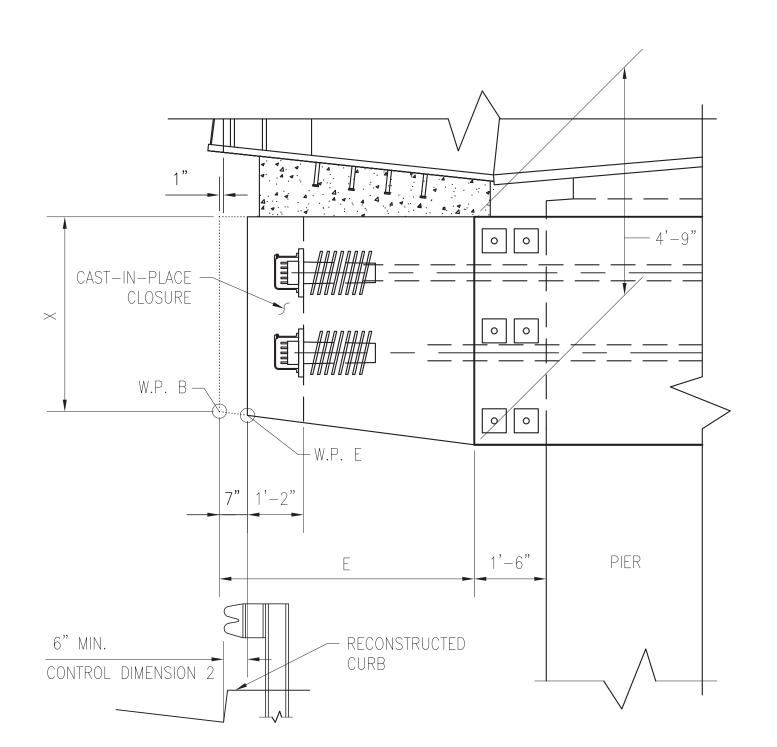


# DETAIL 1 (RETROFIT TYPE 4)


SCALE:  $\frac{1}{2}$ " = 1'-0" LOOKING STA. AHEAD

|       |      |   |       |       | RETE  | ROFIT | TYPE,            | DIMEN | SIONS            | & OTI | HER CO | OMME  | NTS   |       |       |       |       |       |       |                  |       |       |       |                          |                  |
|-------|------|---|-------|-------|-------|-------|------------------|-------|------------------|-------|--------|-------|-------|-------|-------|-------|-------|-------|-------|------------------|-------|-------|-------|--------------------------|------------------|
| PIER# | TYPE | TRAFFIC CONTROL LOCATION(S)               | Α     | В     | С     | D     | E <sup>(1)</sup> | F     | G <sup>(1)</sup> | Н     | J      | K     | L     | M     | N     | Р     | Q     | R     | T     | V <sup>(1)</sup> | W     | Х     | Υ     | <b>AA</b> <sup>(2)</sup> | BB <sup>(2</sup> |
| FILK# |      | TRAFFIC CONTROL LOCATION(3)               | (ft.) | (ft.) |
| A5447 | 2    | ROCKVILLE PIKE N.B.                       | 3.05  | 7.05  | 7.05  | 3.22  | 5.43             | 6.50  | 5.59             | 1.00  | 3.00   | 3.00  | 1.00  | 1.67  | 1.67  | 4.92  | 4.92  | 1.25  | 9.83  | 20.52            | 1.01  | 4.21  | 4.19  | 7.83                     | 5.92             |
| A5435 | 3    | ROCKVILLE PIKE N.B.                       | 3.19  | 7.00  | 7.00  | 3.19  | 5.52             | 6.50  | 5.52             | 1.17  | 3.50   | 4.50  | 1.00  | 1.67  | 2.33  | 4.92  | 5.58  | 1.25  | 10.50 | 20.54            | 0.79  | 4.20  | 4.20  | 10.00                    | 6.04             |
| A5403 | 5    | ROCKVILLE PIKE N.B.                       | 3.40  | 4.59  | 9.61  | 2.71  | 3.07             | 7.00  | 7.40             | 1.00  | 5.00   | 3.50  | 1.17  | 2.58  | 1.67  | 6.08  | 5.17  | 1.33  | 11.25 | 20.47            | 0.79  | 4.44  | 4.01  | 10.50                    | 5.77             |
| A5392 | 3    | ROCKVILLE PIKE N.B. & ROCKVILLE PIKE S.B. | 3.41  | 7.10  | 7.10  | 2.66  | 5.34             | 7.50  | 4.60             | 1.17  | 3.50   | 5.00  | 1.00  | 1.67  | 2.33  | 5.42  | 6.08  | 1.25  | 11.50 | 20.44            | 0.79  | 4.22  | 4.29  | 10.50                    | 5.74             |
| A5376 | 4    | ROCKVILLE PIKE S.B.                       | 3.28  | 7.06  | 7.06  | 2.94  | 5.67             | 6.50  | 5.33             | 0.92  | 5.50   | 3.50  | 1.17  | 3.25  | 1.75  | 6.50  | 5.00  | 1.25  | 11.50 | 20.50            | 0.79  | 4.18  | 4.22  | 10.92                    | 5.88             |
| A5366 | 2    | ROCKVILLE PIKE S.B.                       | 3.21  | 7.01  | 7.01  | 3.14  | 5.80             | 6.00  | 5.72             | 0.92  | 2.50   | 2.50  | 0.92  | 1.67  | 1.67  | 4.67  | 4.67  | 1.25  | 9.33  | 20.52            | 0.77  | 4.17  | 4.18  | 6.67                     | 6.02             |
| A5356 | 2    | NONE REQ'D BASED ON THE CRITERIA BELOW    | 3.19  | 7.00  | 7.00  | 3.19  | 5.77             | 6.00  | 5.77             | 0.92  | 2.50   | 2.50  | 0.92  | 1.67  | 1.67  | 4.67  | 4.67  | 1.25  | 9.33  | 20.54            | 0.77  | 4.17  | 4.17  | 6.67                     | 6.04             |
| A5345 | 2    | NONE REQ'D BASED ON THE CRITERIA BELOW    | 3.22  | 7.01  | 7.01  | 3.11  | 5.82             | 6.00  | 5.70             | 0.92  | 2.50   | 2.50  | 0.92  | 1.67  | 1.67  | 4.67  | 4.67  | 1.25  | 9.33  | 20.52            | 0.77  | 4.17  | 4.18  | 6.67                     | 5.99             |
| A5335 | 2    | NONE REQ'D BASED ON THE CRITERIA BELOW    | 3.27  | 7.07  | 7.07  | 2.98  | 5.67             | 6.50  | 5.38             | 0.92  | 2.50   | 2.50  | 0.92  | 1.67  | 1.67  | 4.92  | 4.92  | 1.25  | 9.83  | 20.55            | 0.77  | 4.18  | 4.21  | 6.67                     | 5.90             |
| A5324 | 2    | NONE REQ'D BASED ON THE CRITERIA BELOW    | 3.39  | 7.12  | 7.12  | 2.74  | 5.84             | 6.50  | 5.19             | 0.92  | 2.50   | 2.50  | 0.92  | 1.67  | 1.67  | 4.92  | 4.92  | 1.25  | 9.83  | 20.53            | 0.77  | 4.17  | 4.23  | 6.67                     | 5.80             |
| A5313 | 2    | NONE REQ'D BASED ON THE CRITERIA BELOW    | 3.39  | 7.12  | 7.12  | 2.71  | 5.84             | 6.50  | 5.17             | 0.92  | 2.50   | 2.50  | 0.92  | 1.67  | 1.67  | 4.92  | 4.92  | 1.25  | 9.83  | 20.51            | 0.77  | 4.17  | 4.23  | 6.67                     | 5.77             |
| A5302 | 2    | NONE REQ'D BASED ON THE CRITERIA BELOW    | 3.39  | 7.12  | 7.12  | 2.71  | 5.84             | 6.50  | 5.17             | 0.92  | 2.50   | 2.50  | 0.92  | 1.67  | 1.67  | 4.92  | 4.92  | 1.25  | 9.83  | 20.51            | 0.77  | 4.17  | 4.23  | 6.67                     | 5.77             |
| A5290 | 1    | NONE REQ'D BASED ON THE CRITERIA BELOW    | 3.39  | 7.12  | 7.12  | 2.71  | 5.84             | 6.50  | 5.17             | 0.92  | 2.50   | 2.50  | 0.92  | 1.67  | 1.67  | 4.92  | 4.92  | 1.25  | 9.83  | 20.51            | 0.77  | 4.17  | 4.23  | 6.67                     | 5.77             |
| A5279 | 2    | NONE REQ'D BASED ON THE CRITERIA BELOW    | 3.39  | 7.12  | 7.12  | 2.71  | 5.84             | 6.50  | 5.17             | 0.92  | 2.50   | 2.50  | 0.92  | 1.67  | 1.67  | 4.92  | 4.92  | 1.25  | 9.83  | 20.51            | 0.77  | 4.17  | 4.23  | 6.67                     | 5.77             |
| A5268 | 2    | NONE REQ'D BASED ON THE CRITERIA BELOW    | 3.39  | 7.12  | 7.12  | 2.71  | 5.84             | 6.50  | 5.17             | 0.92  | 2.50   | 2.50  | 0.92  | 1.67  | 1.67  | 4.92  | 4.92  | 1.25  | 9.83  | 20.51            | 0.76  | 4.17  | 4.23  | 6.67                     | 5.77             |
| A5258 | 2    | NONE REQ'D BASED ON THE CRITERIA BELOW    | 3.39  | 7.12  | 7.12  | 2.71  | 5.84             | 6.50  | 5.17             | 0.92  | 2.50   | 2.50  | 0.92  | 1.67  | 1.67  | 4.92  | 4.92  | 1.25  | 9.83  | 20.51            | 0.75  | 4.17  | 4.23  | 6.67                     | 5.77             |
| A5248 | 2    | NONE REQ'D BASED ON THE CRITERIA BELOW    | 3.39  | 7.12  | 7.12  | 2.71  | 5.84             | 6.50  | 5.17             | 0.92  | 2.50   | 2.50  | 0.92  | 1.67  | 1.67  | 4.92  | 4.92  | 1.25  | 9.83  | 20.51            | 0.75  | 4.17  | 4.23  | 6.67                     | 5.77             |
| A5238 | 2    | I-495 W.B. SHOULDER                       | 3.42  | 7.12  | 7.12  | 2.61  | 5.37             | 7.50  | 4.56             | 1.00  | 3.00   | 3.75  | 1.00  | 1.67  | 1.67  | 5.42  | 5.42  | 1.25  | 10.83 | 20.43            | 0.75  | 4.21  | 4.29  | 8.58                     | 5.69             |
| A5212 | 3    | NONE REQ'D BASED ON THE CRITERIA BELOW    | 3.40  | 7.09  | 7.09  | 2.76  | 5.82             | 6.50  | 5.18             | 1.00  | 3.00   | 3.00  | 1.00  | 1.67  | 1.67  | 4.92  | 4.92  | 1.25  | 9.83  | 20.49            | 0.75  | 4.17  | 4.23  | 7.83                     | 5.82             |
| A5199 | 3    | NONE REQ'D BASED ON THE CRITERIA BELOW    | 3.22  | 7.02  | 7.02  | 3.08  | 5.57             | 6.50  | 5.43             | 1.00  | 3.00   | 3.00  | 1.00  | 1.67  | 1.67  | 4.92  | 4.92  | 1.25  | 9.83  | 20.50            | 0.75  | 4.19  | 4.21  | 7.83                     | 5.96             |
| A5186 | 3    | NONE REQ'D BASED ON THE CRITERIA BELOW    | 3.19  | 7.00  | 7.00  | 3.19  | 5.52             | 6.50  | 5.52             | 1.00  | 3.00   | 3.00  | 1.00  | 1.67  | 1.67  | 4.92  | 4.92  | 1.25  | 9.83  | 20.54            | 0.75  | 4.20  | 4.20  | 7.83                     | 6.04             |


TRAFFIC CONTROL IS BASED ON AN ASSUMED CONSTRUCTION WORK AREA OF 5'-0" AROUND PERIMETER FOR PLACEMENT OF SHORING AND FORMING.
ADDITIONAL LOCATIONS OF TRAFFIC CONTROL MAY BE REQUIRED FOR PLACEMENT AND DELIVERY OF CONCRETE, GROUT AND OTHER CONSTRUCTION MATERIALS.

- (1) DIMENSIONS ARE BASED ON ORIGINAL PIERS; ADJUST DIMENSIONS AS NECESSARY SUCH THAT CONTROL DIMENSIONS 1 & 2 ARE MAINTAINED.
- (2) SEE DRAWING NO. A13-S-107 FOR DEFINITION OF DIMENSIONS "AA" AND "BB".
- RETROFIT TYPES 1, 2, AND 3 ARE OF SIMILAR CONFIGURATION WITH DIFFERENT POST-TENSIONING AND CONCRETE REINFORCEMENT LAYOUTS.
- RETROFIT TYPES 4 AND 5 ARE UNIQUE DUE TO CLEARANCE CONCERNS TO MD SHA ROADWAYS.

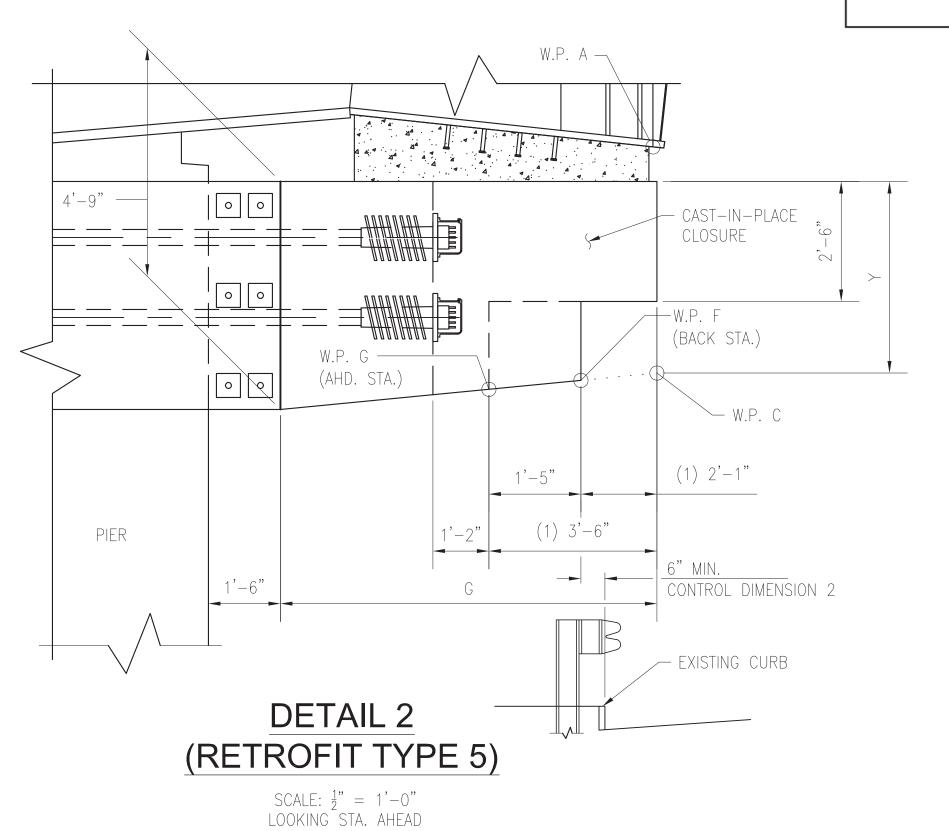

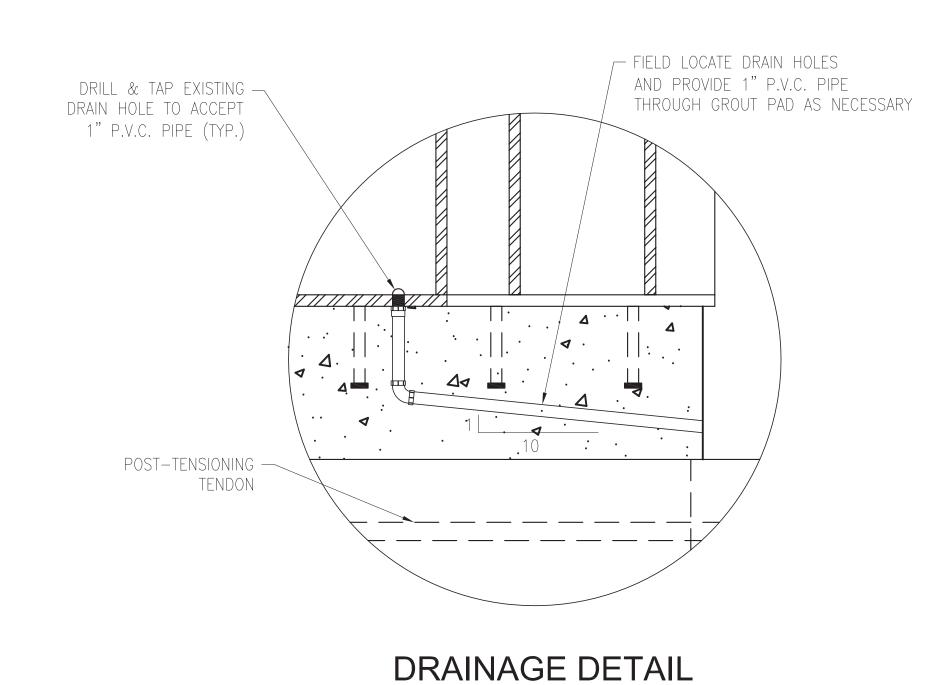

SCALE:  $1\frac{1}{2}$ " = 1'-0"

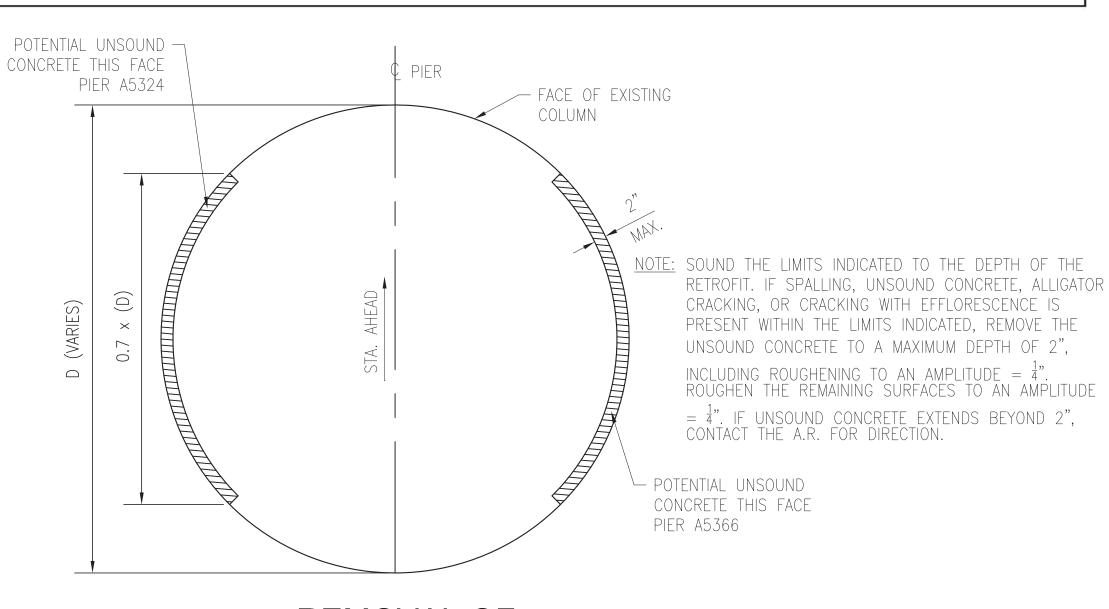

# REMOVAL OF DETERIORATED CONCRETE

SCALE:  $\frac{3}{4}$ " = 1'-0"

PROFESSIONAL CERTIFICATION. I HEREBY CERTIFY THAT THESE DOCUMENTS WERE PREPARED OR APPROVED BY ME, AND THAT I AM A DULY LICENSED PROFESSIONAL ENGINEER UNDER THE LAWS OF THE STATE OF MARYLAND, LICENSE NO. 24077, EXPIRATION DATE 02-24-2015

NOTE: SEE DRAWING NO. A13-S-103 FOR ILLUSTRATION OF RETROFIT DIMENSIONS

FQ15093



# WASHINGTON METROPOLITAN AREA TRANSIT AUTHORITY

DEPARTMENT OF TRANSIT INFRASTRUCTURE
AND ENGINEERING SERVICES
OFFICE OF INFRASTRUCTURE RENEWAL PROGRAM



# RED LINE REHABILITATION GROSVENOR AERIAL STRUCTURE


PIER CAP RETROFIT DIMENSIONS


D BRAD MASON
PROJECT MANAGER

SCALE
AS SHOWN


**DRAWING NO.**A13−S−104

M1272-125

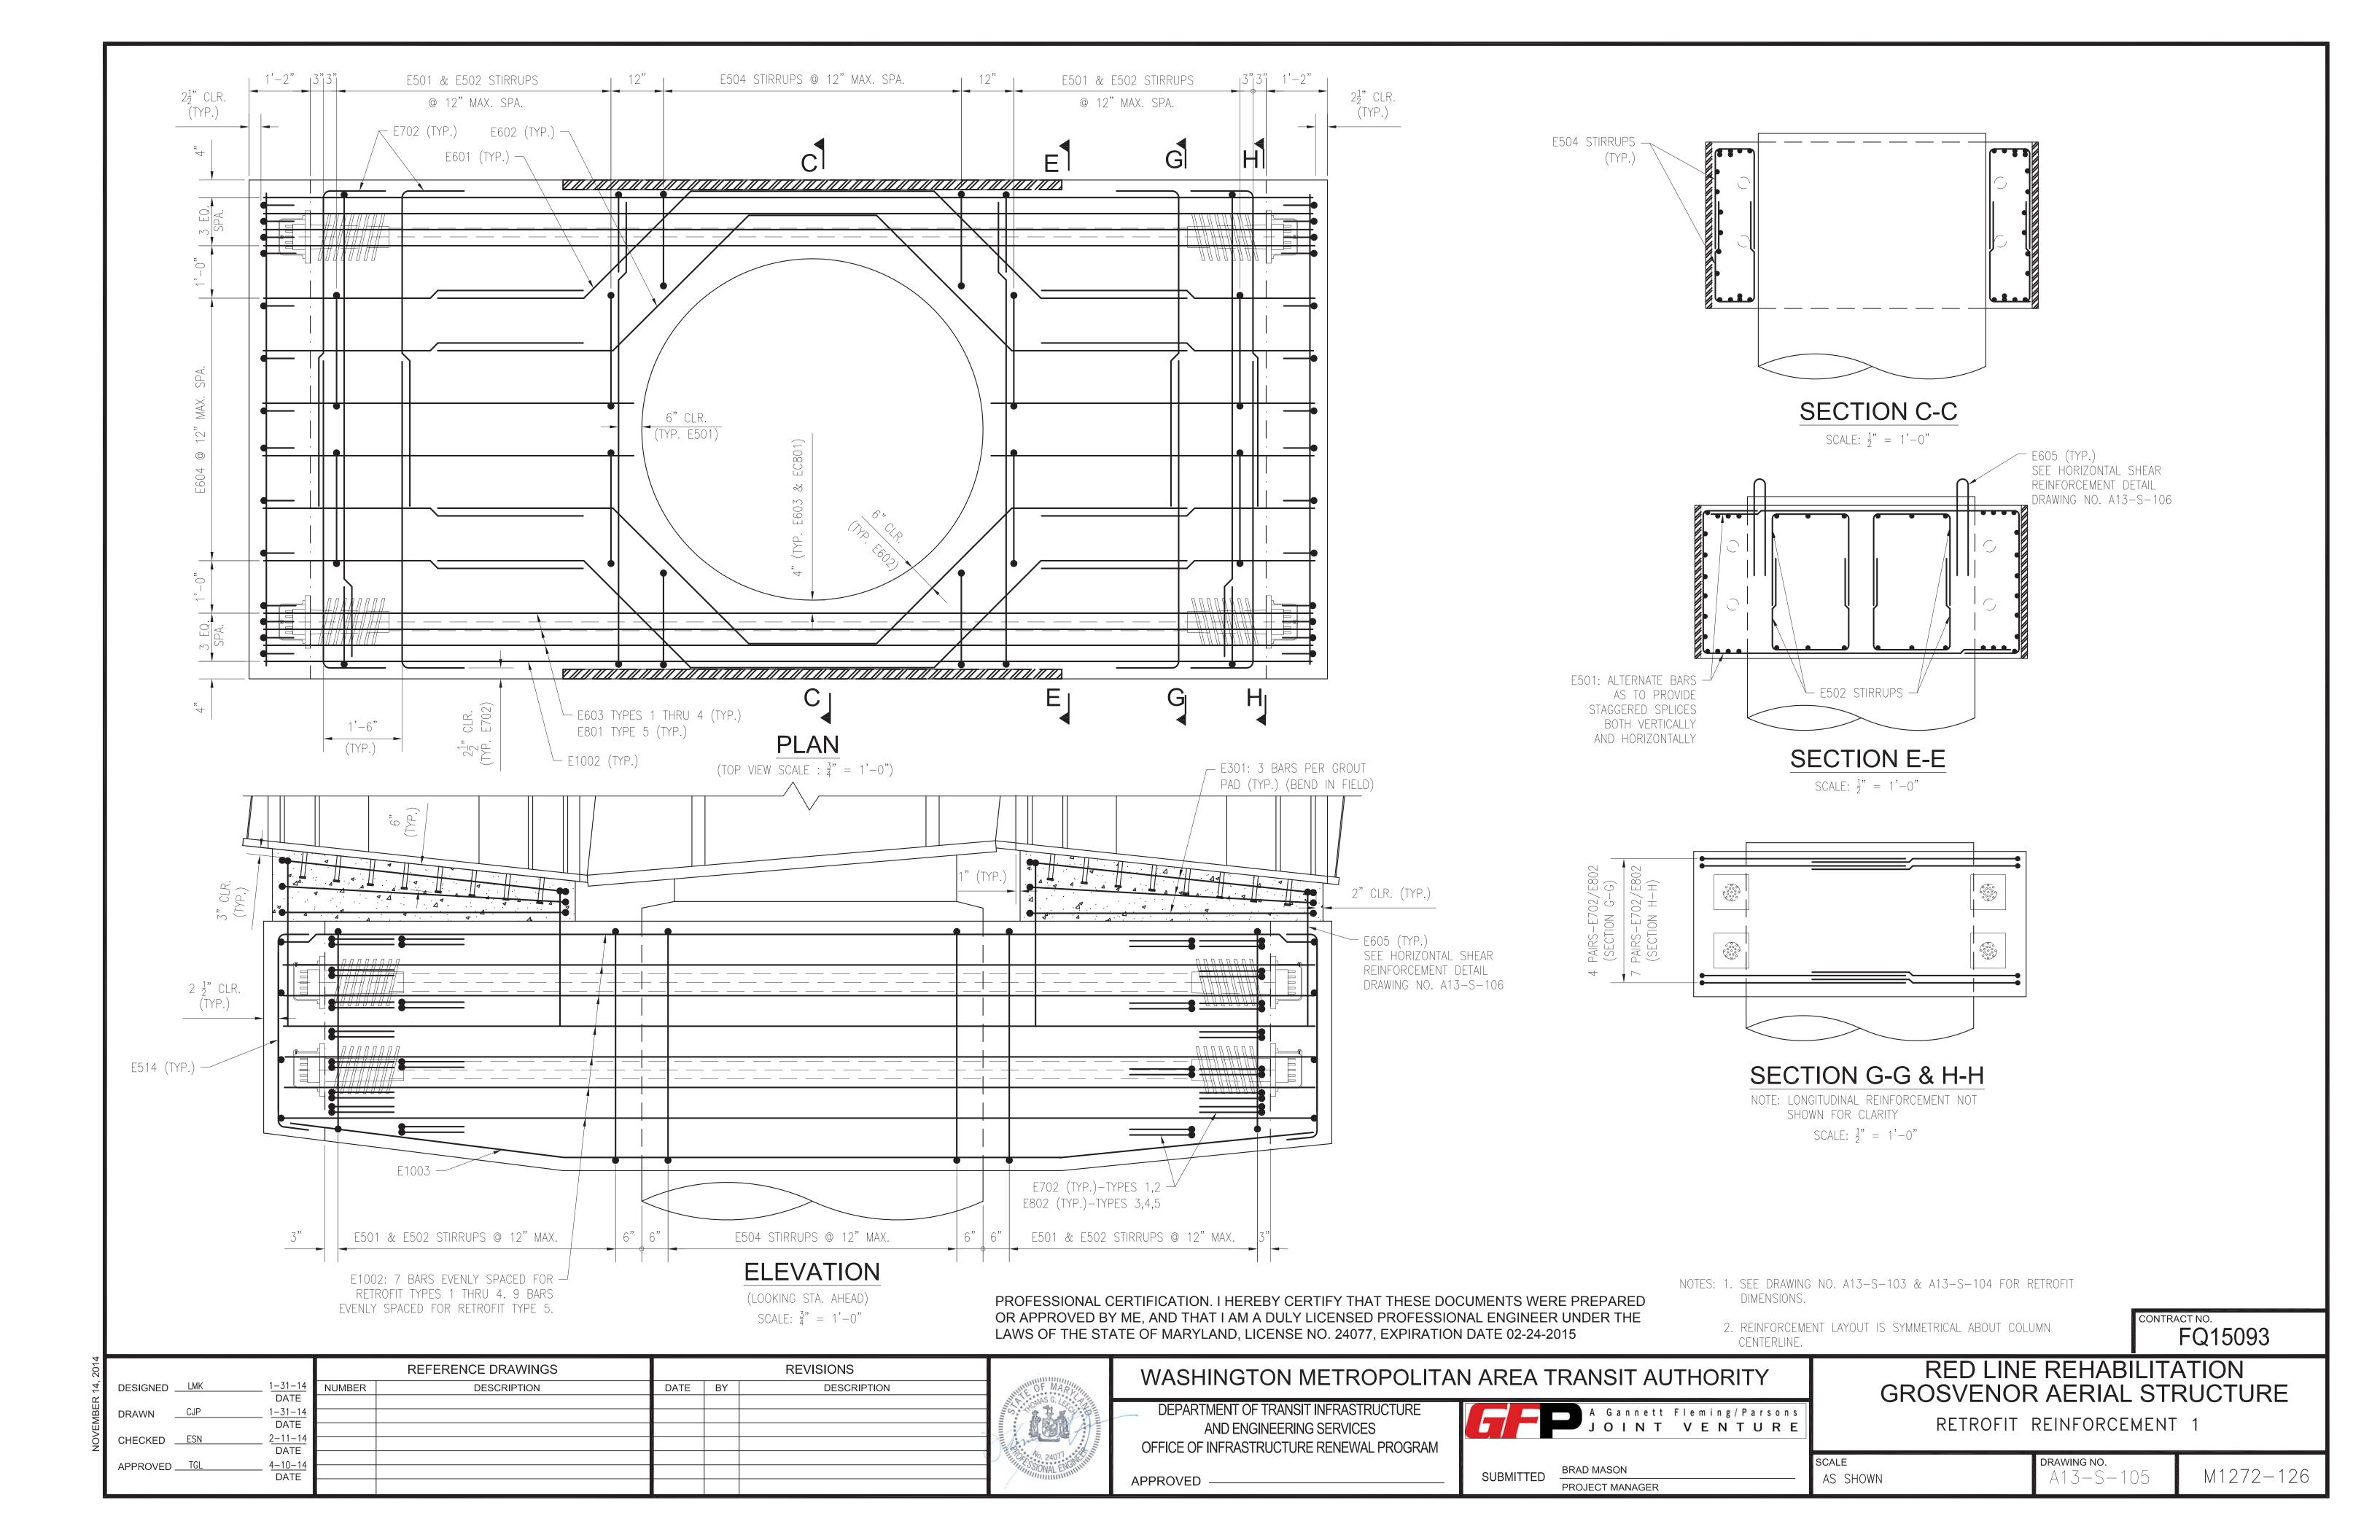

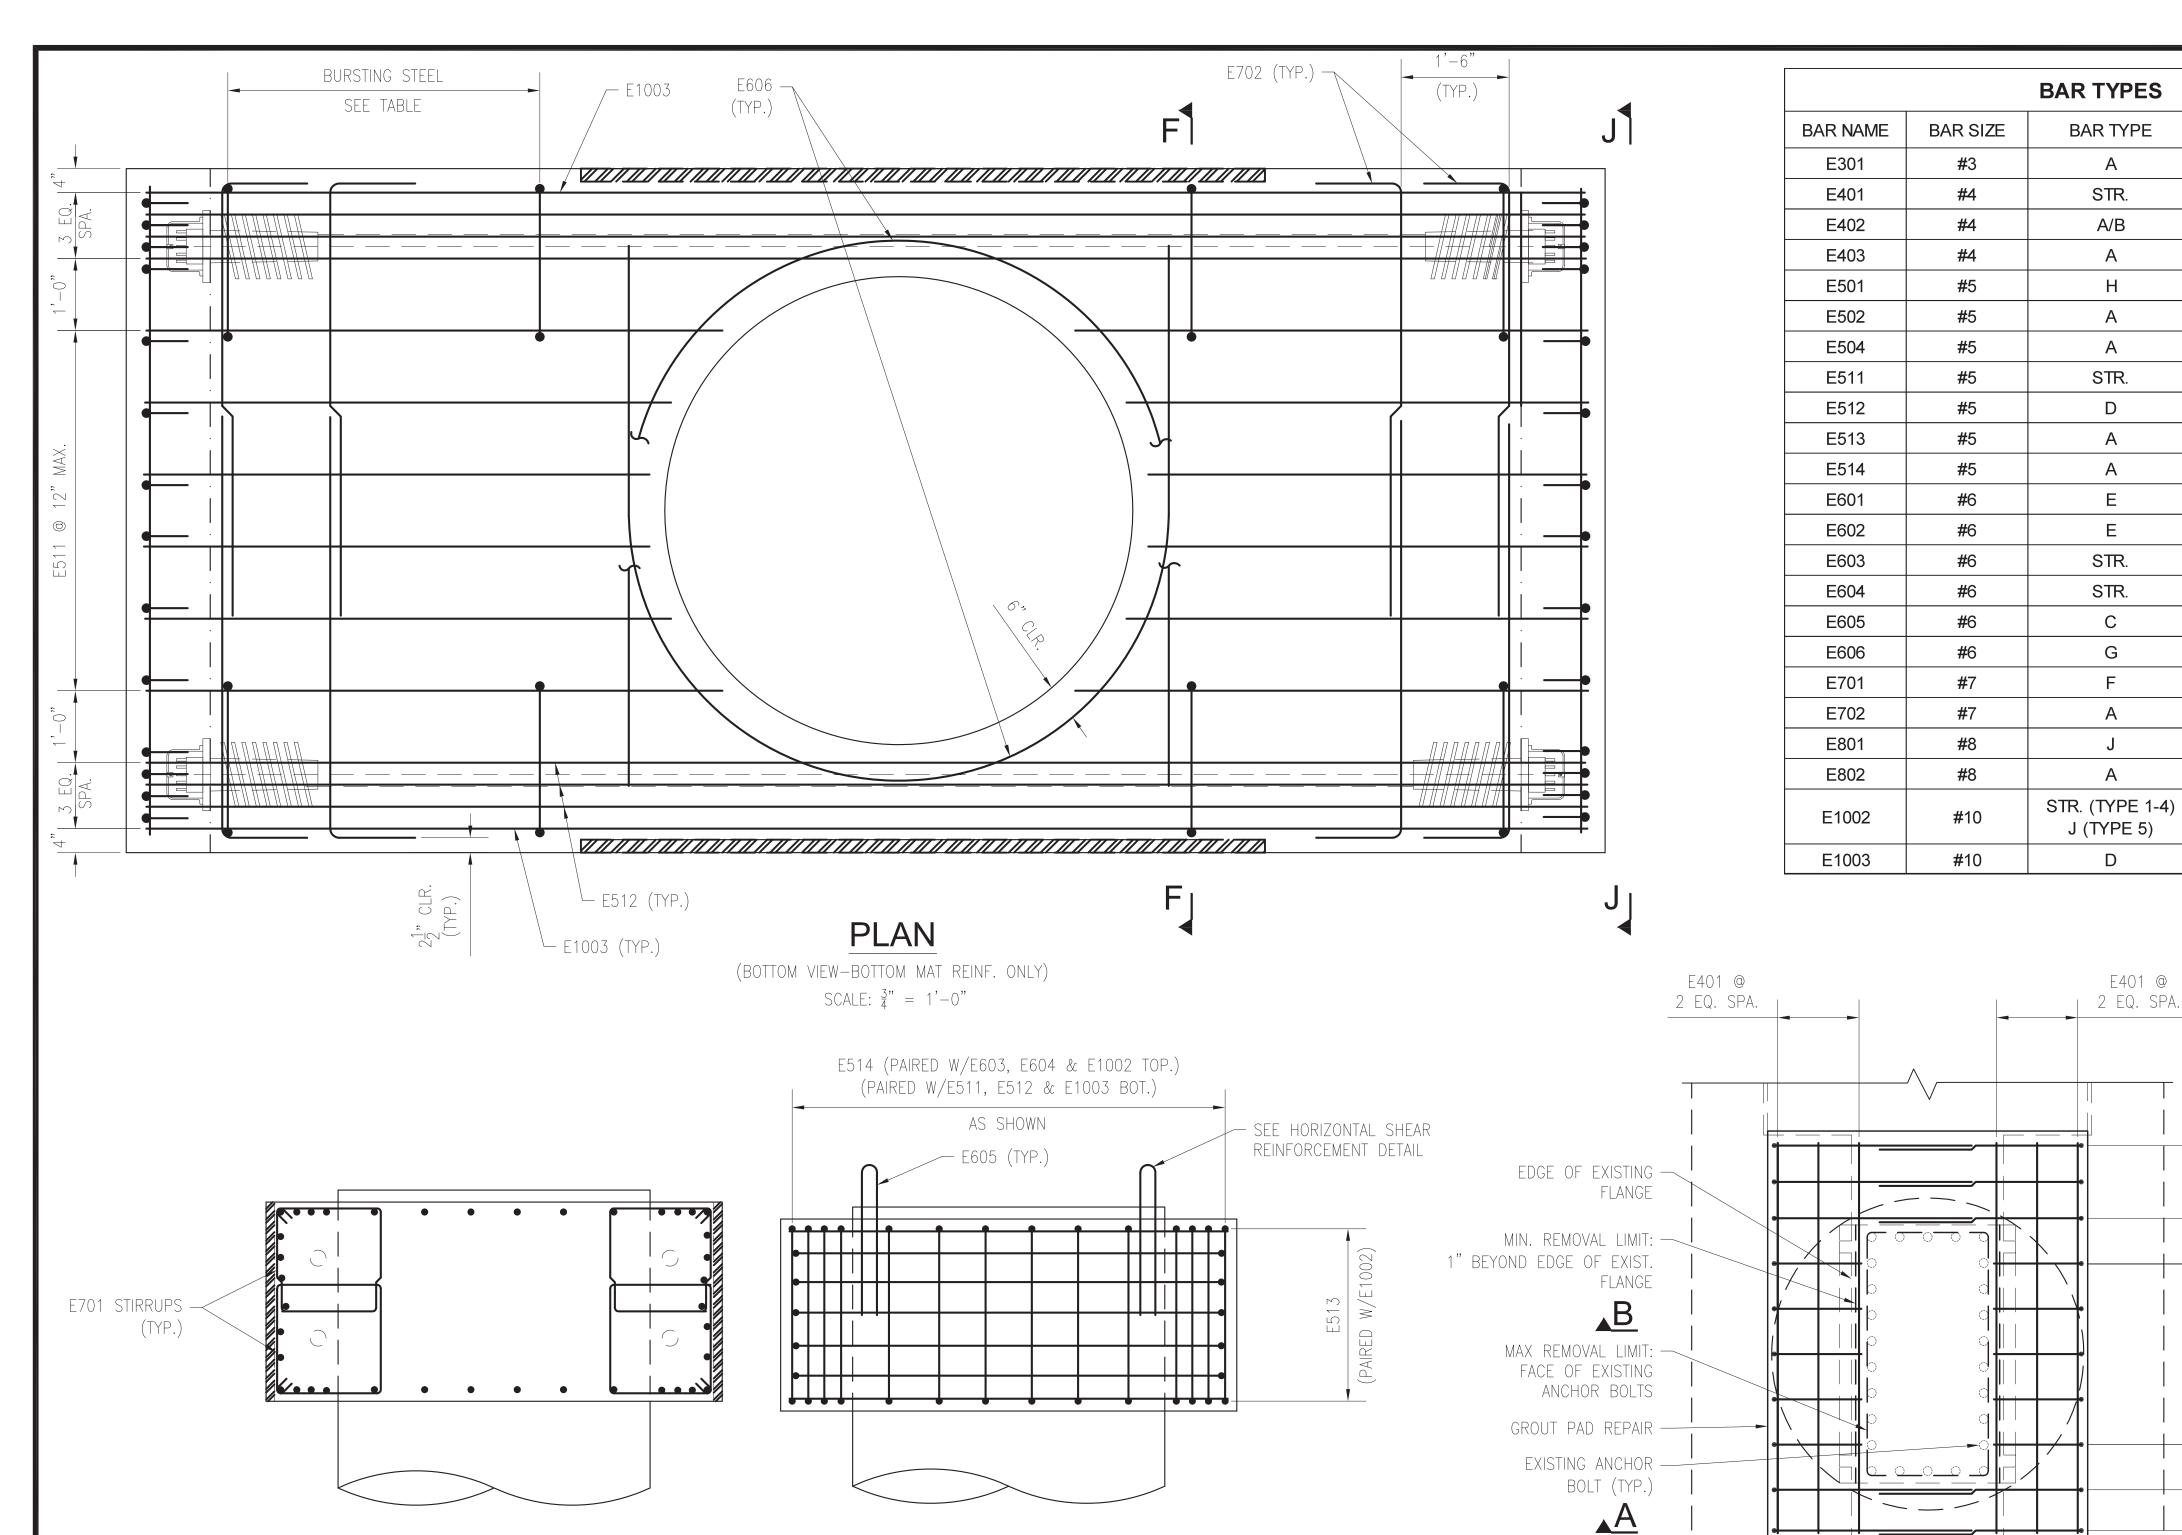


**BAR TYPES BAR TYPE** MIN. SPLICE / EMBED. 24" SPLICE N/A 18" SPLICE N/A 26" SPLICE 26" SPLICE 26" SPLICE N/A N/A N/A N/A 32" SPLICE 32" SPLICE N/A 32" SPLICE 24" EMBEDMENT N/A N/A 44" (63") SPLICE 57" (80") SPLICE STR. (TYPE 1-4) N/A J (TYPE 5) N/A

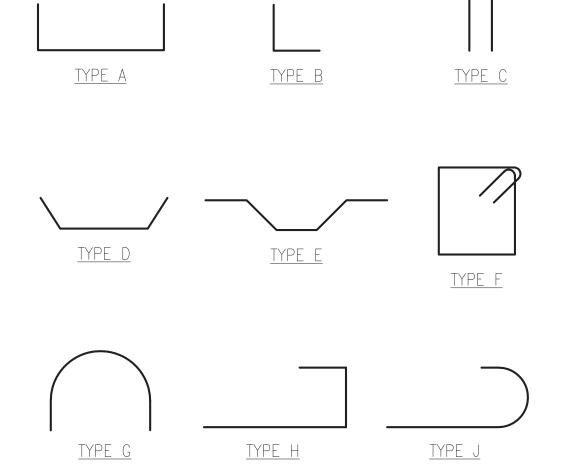


() THE SPLICE LENGTHS IN PARENTHESIS INDICATE THE LAP SPLICE LENGTH REQUIRED FOR TOP HORIZONTAL OR NEARLY HORIZONTAL REINFORCEMENT, SO PLACED THAT MORE THAN 12" OF CONCRETE IS CAST BELOW THE REINFORCEMENT.

|               | BURSTING STEEL                               |
|---------------|--|
| RETROFIT TYPE | REINFORCEMENT                                |
| 1,2           | 7 PAIRS E701 STIRRUPS AROUND TENDONS @ 9"    |
| 3,4           | 8 PAIRS E701 STIRRUPS AROUND TENDONS @ 8"    |
| 5             | 10 PAIRS E701 STIRRUPS AROUND TENDONS @ 6.5" |

E402 —

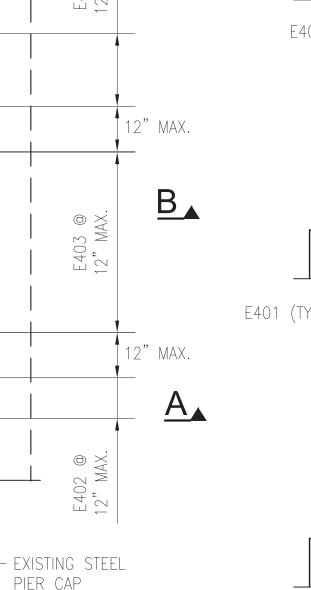

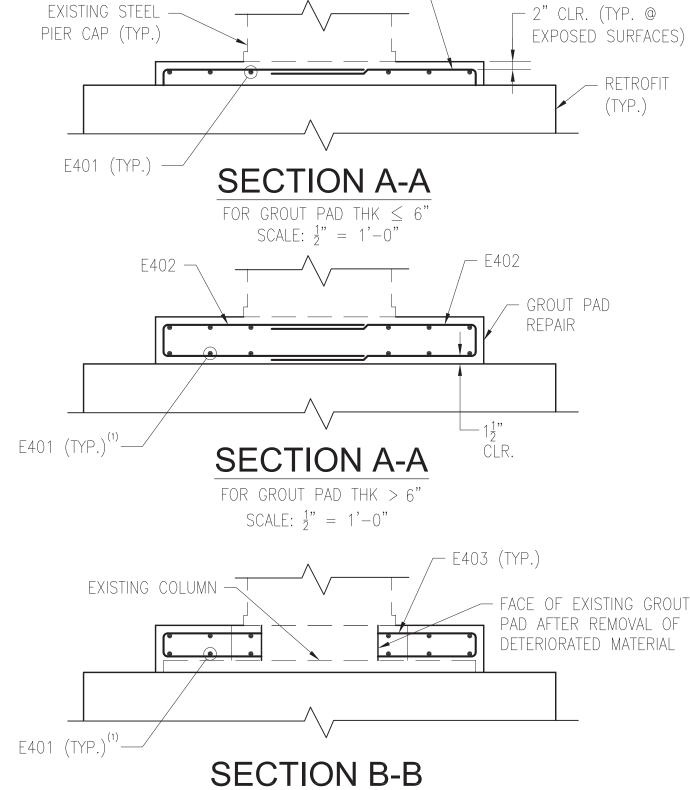

NOTES: 1. SEE DRAWING NO. A13-S-103 & A13-S-104 FOR

RETROFIT DIMENSIONS.

CENTERLINE.

2. REINFORCEMENT LAYOUT IS SYMMETRICAL ABOUT COLUMN

SECTION F-F

SCALE:  $\frac{1}{2}$ " = 1'-0"

PROFESSIONAL CERTIFICATION. I HEREBY CERTIFY THAT THESE DOCUMENTS WERE PREPARED OR APPROVED BY ME, AND THAT I AM A DULY LICENSED PROFESSIONAL ENGINEER UNDER THE LAWS OF THE STATE OF MARYLAND, LICENSE NO. 24077, EXPIRATION DATE 02-24-2015

SECTION J-J

SCALE:  $\frac{1}{2}$ " = 1'-0"

# EXISTING GROUT PAD REPAIR DETAIL

FACE OF

RETROFIT

- COLD JOINT

RETROFIT -GROUT PAD

SCALE:  $\frac{1}{2}$ " = 1'-0" NOTE (1): FIELD BEND E401 BARS IN BOTTOM MAT FOR CLEARANCE FROM TOP OF EXISTING COLUMN.

SCALE:  $\frac{1}{2}$ " = 1'-0"


FQ15093

| 2014     |          |     |                 |        | REFERENCE DRAWINGS |      |    | REVISIONS   |          |           |
|----------|----------|-----|-----------------|--------|--------------------|------|----|-------------|----------|-----------|
| R 14,    | DESIGNED | LMK | 1-31-14<br>DATE | NUMBER | DESCRIPTION        | DATE | BY | DESCRIPTION | STATE OF | TE O      |
| NOVEMBER | DRAWN    | CJP | 1-31-14<br>DATE |        |                    |      |    |             | S        | THOM SHOW |
| NOV      | CHECKED  | ESN | 3-3-14<br>DATE  |        |                    |      |    |             | 1        | THE WORLD |
|          | APPROVED | TGL | 4-10-14<br>DATE |        |                    |      |    |             | Tilly,   | SSIO      |

# WASHINGTON METROPOLITAN AREA TRANSIT AUTHORITY

DEPARTMENT OF TRANSIT INFRASTRUCTURE AND ENGINEERING SERVICES OFFICE OF INFRASTRUCTURE RENEWAL PROGRAM


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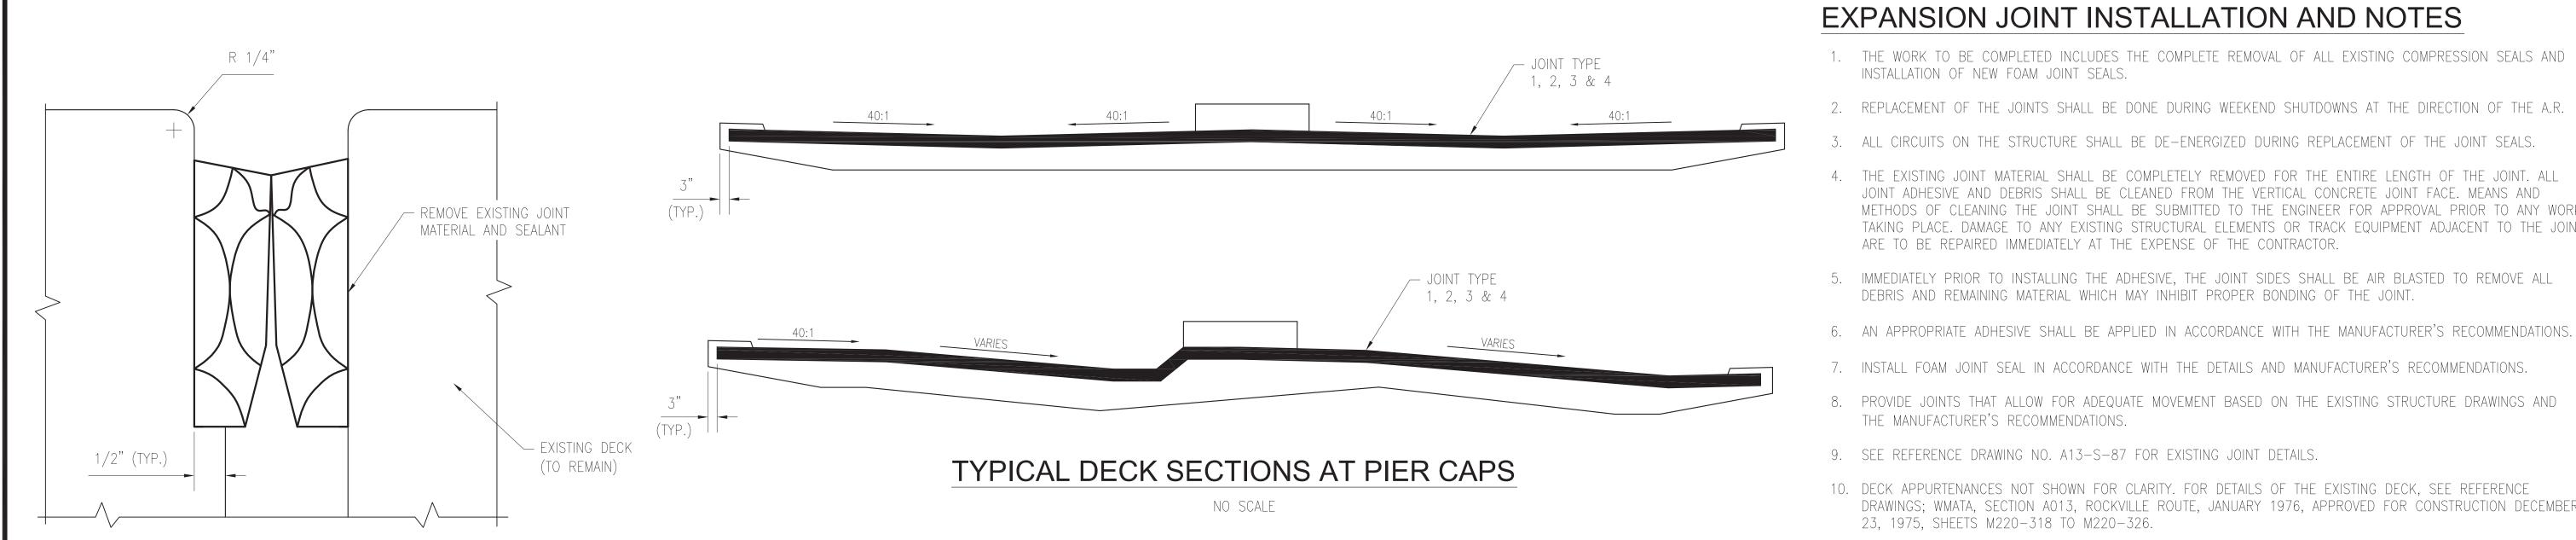

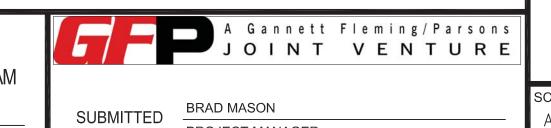
| RED LINE REHABILITATION   |
|---------------------------|
| GROSVENOR AERIAL STRUCTUR |

RETROFIT REINFORCEMENT 2

SCALE M1272 - 127A13-S-106 AS SHOWN PROJECT MANAGER



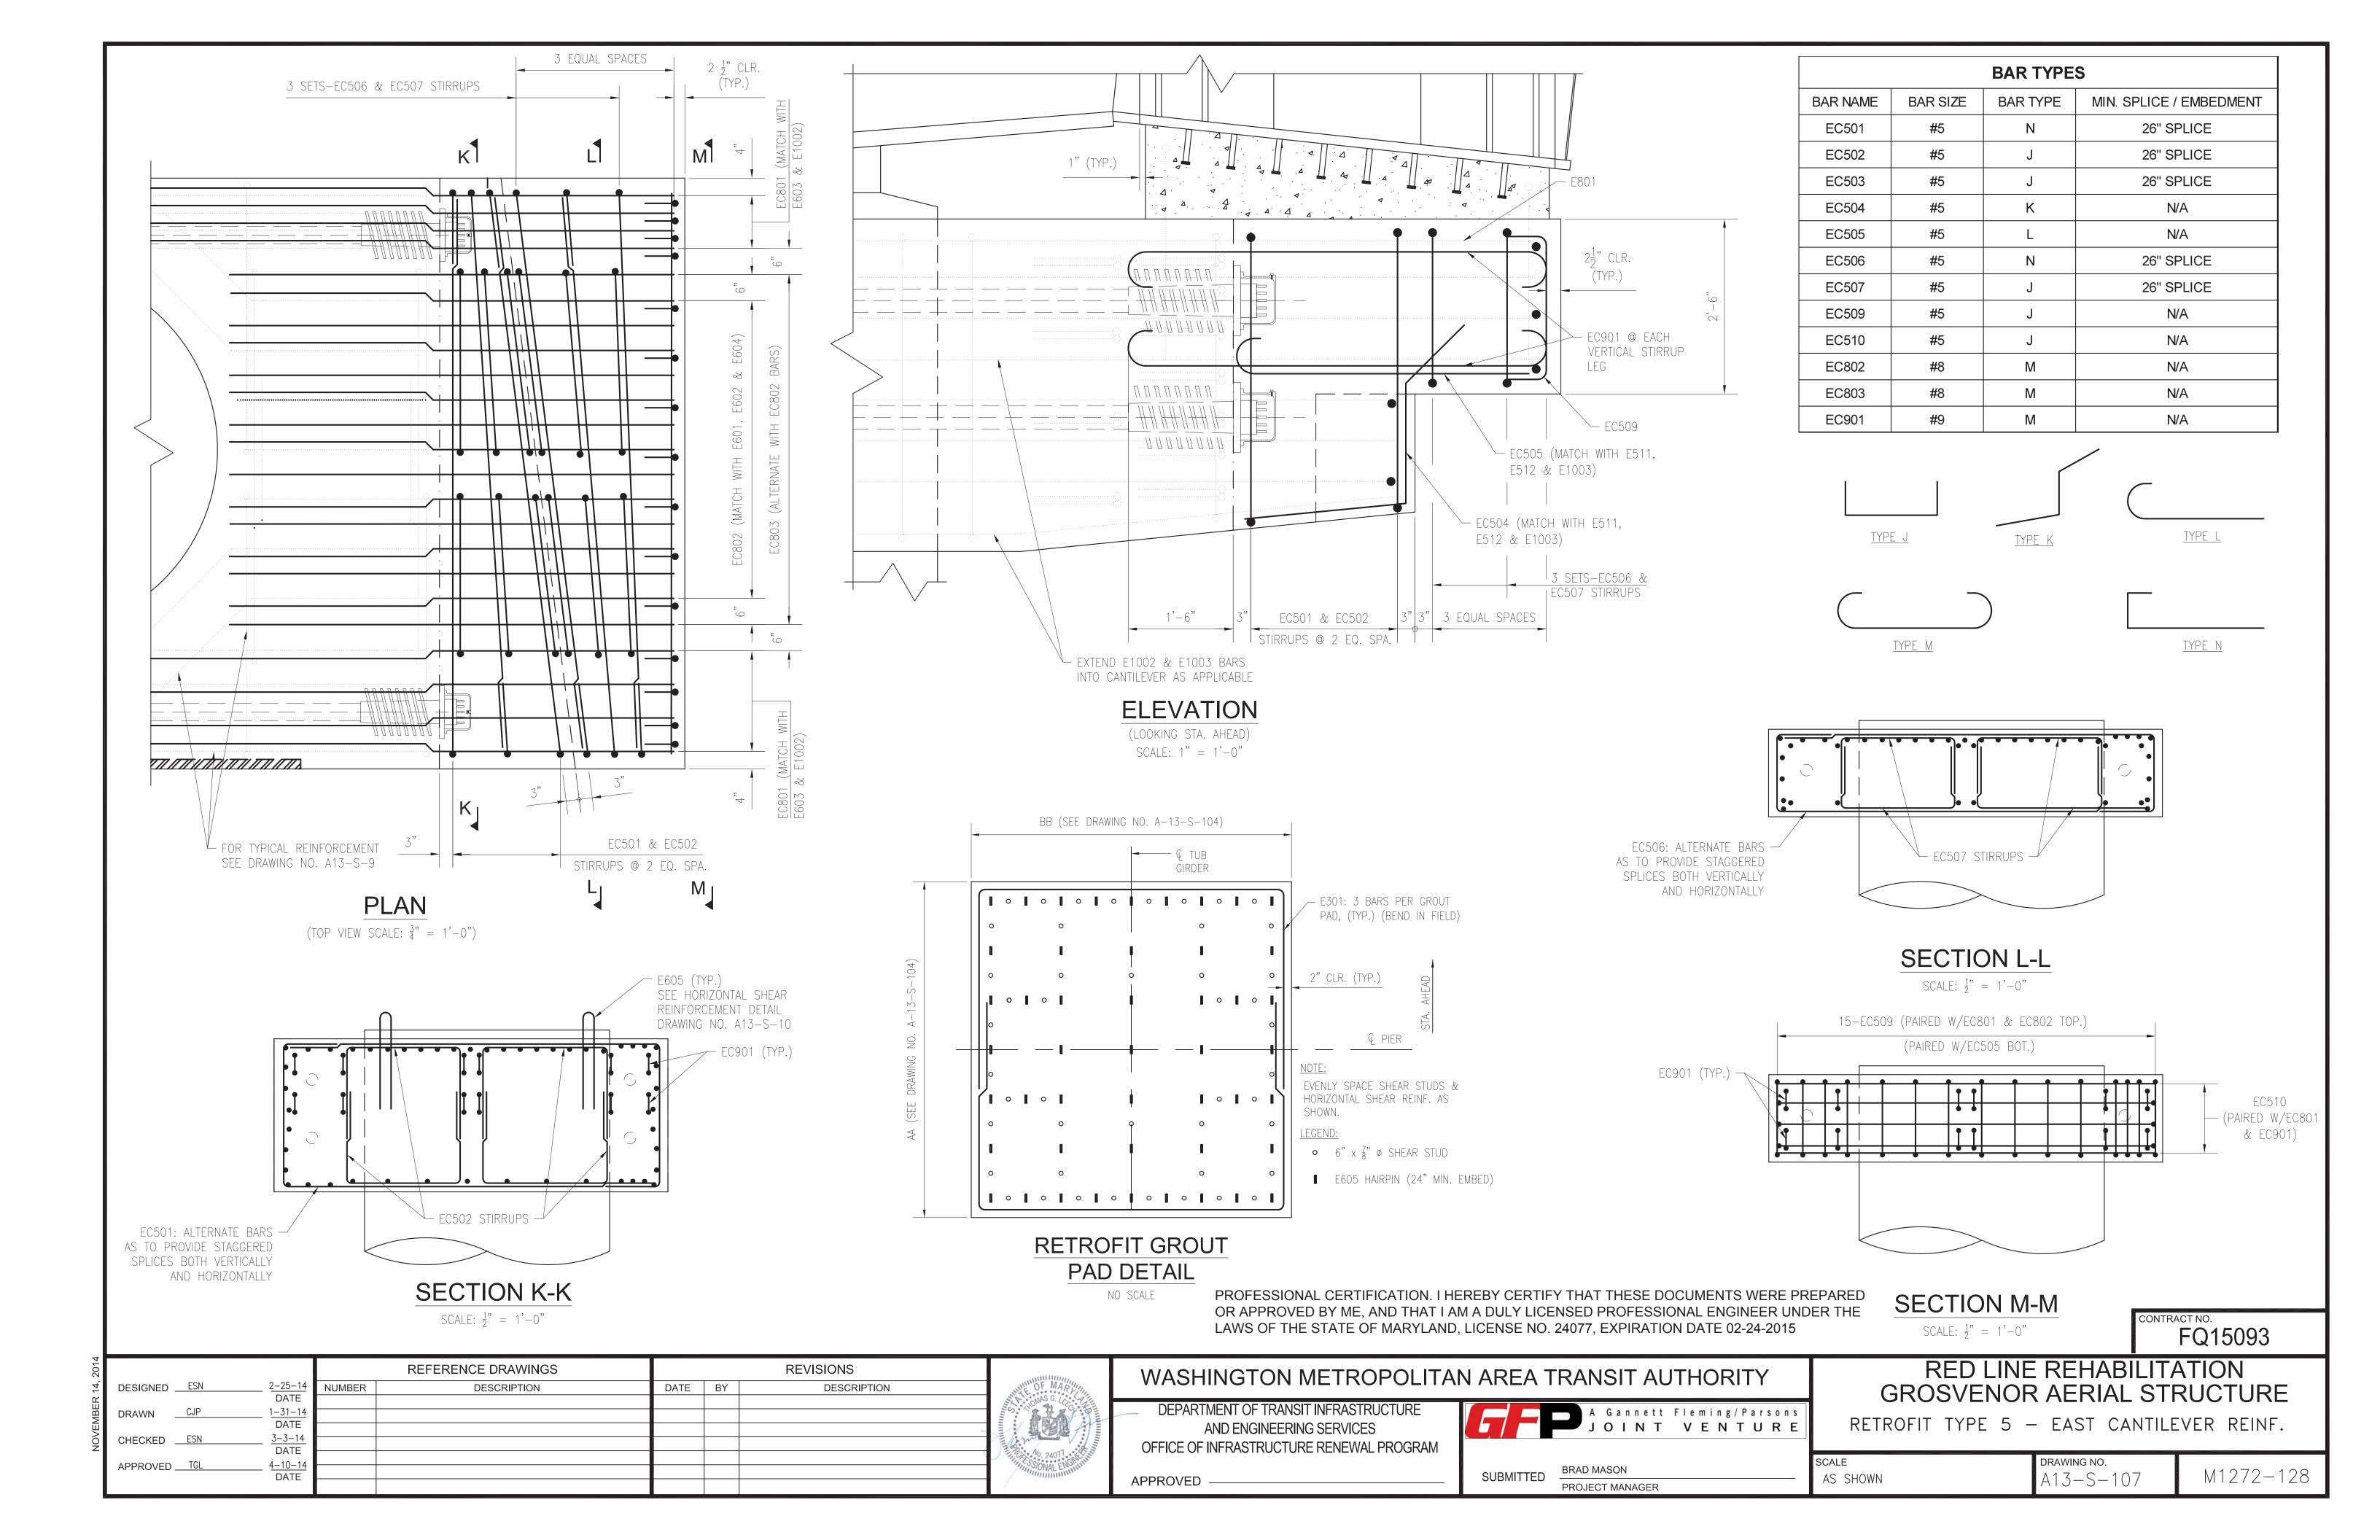


# **EXISTING COMPRESSION JOINT** (TYPES 1, 2 & 3)

NO SCALE

(TYPE 4)

NO SCALE

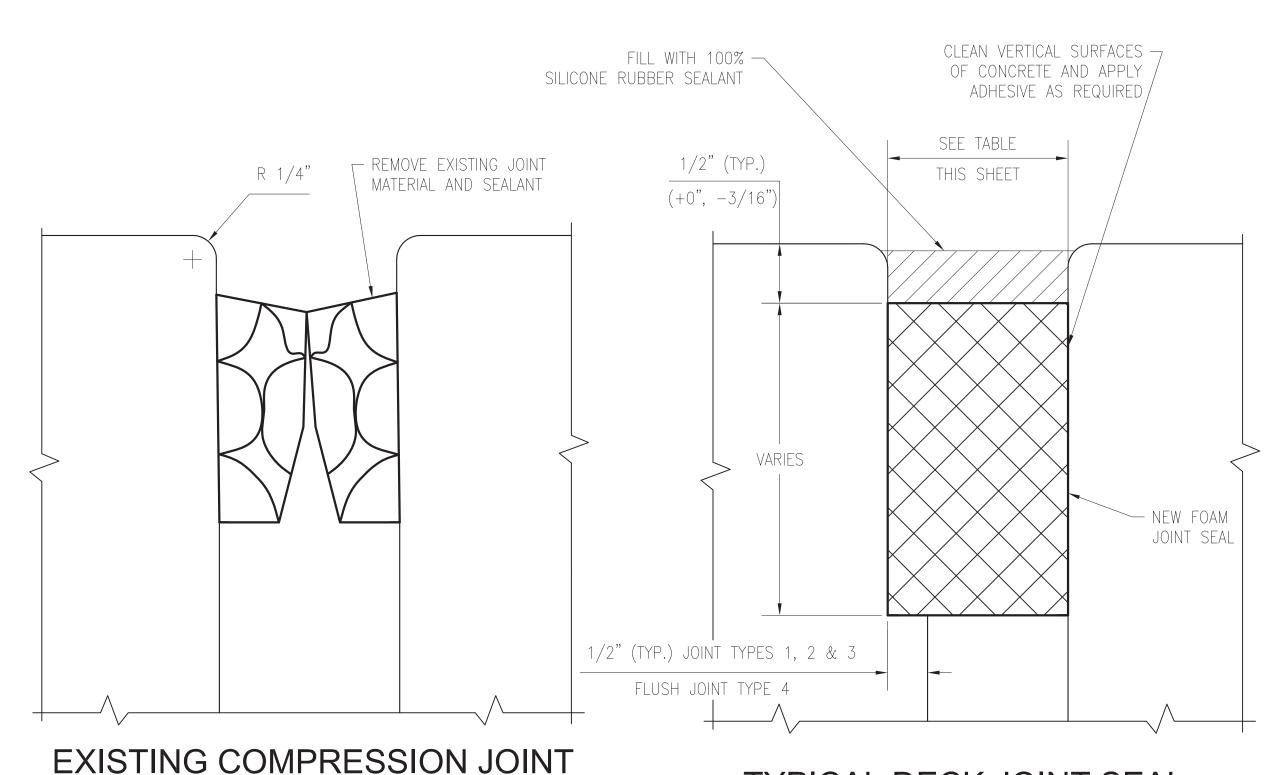

# TYPICAL DECK JOINT SEAL REPLACEMENT

FOR EXISTING JOINT TYPES 1, 2, 3 & 4 NO SCALE

PROFESSIONAL CERTIFICATION. I HEREBY CERTIFY THAT THESE DOCUMENTS WERE PREPARED OR APPROVED BY ME, AND THAT I AM A DULY LICENSED PROFESSIONAL ENGINEER UNDER THE LAWS OF THE STATE OF MARYLAND, LICENSE NO. 24077, EXPIRATION DATE 02-24-2015

| JOINT LOCATION        | (1) EXISTING JOINT TYPE | (2) JOINT OPENING | (3) JOINT LENGTH |
|-----------------------|-------------------------|-------------------|------------------|
| ABUT. NO A5460        | 2                       | 3"                | 41' - 3"         |
| PIER NO. A5447 AHEAD  | 4                       | 2"                | 34' - 0"         |
| PIER NO. A5447 BACK   | 4                       | 2"                | 34' - 0"         |
| PIER NO. A5435 AHEAD  | 2                       | 3"                | 29' - 9"         |
| PIER NO. A5435 BACK   | 3                       | 3 3/4"            | 29' - 9"         |
| FRAME NO. A5419 AHEAD | 4                       | 2"                | 30' - 0"         |
| FRAME NO. A5419 BACK  | 4                       | 2"                | 30' - 0"         |
| PIER NO. A5403 AHEAD  | 3                       | 3 3/4"            | 29' - 9"         |
| PIER NO. A5403 BACK   | 1                       | 2 3/4"            | 29' - 9''        |
| PIER NO. A5392 AHEAD  | 4                       | 2"                | 34' - 9"         |
| PIER NO. A5392 BACK   | 4                       | 2"                | 34' - 9"         |
| PIER NO. A5376 AHEAD  | 3                       | 3 3/4"            | 31' - 6"         |
| PIER NO. A5376 BACK   | 1                       | 2 3/4"            | 31' - 6"         |
| PIER NO. A5366 AHEAD  | 4                       | 2"                | 31' - 6"         |
| PIER NO. A5366 BACK   | 4                       | 2"                | 31' - 6"         |
| PIER NO. A5356 AHEAD  | 1                       | 2 3/4"            | 31' - 6"         |
| PIER NO. A5356 BACK   | 1                       | 2 3/4"            | 31' - 6"         |
| PIER NO. A5345 AHEAD  | 4                       | 2"                | 31' - 6"         |
| PIER NO. A5345 BACK   | 4                       | 2"                | 31' - 6"         |
| PIER NO. A5335 AHEAD  | 1                       | 2 3/4"            | 31' - 6"         |
| PIER NO. A5335 BACK   | 1                       | 2 3/4"            | 31' - 6"         |
| PIER NO. A5324 AHEAD  | 4                       | 2"                | 31' - 6"         |
|                       |                         |                   |                  |

JOINT SCHEDULE

#### **NOTES**

PIER NO. A5324 BACK

PIER NO. A5313 AHEAD

PIER NO. A5313 BACK

- (1) EXISTING JOINT TYPES ARE GIVEN FOR INFORMATION PURPOSES ONLY.
- (2) JOINT OPENINGS GIVEN ARE @ 60°F AND ARE BASED ON THE ORIGINAL DESIGN DRAWINGS.
- (3) JOINT LENGTHS ARE GIVEN TO THE NEAREST 3" INCREMENT
- (4) REPLACEMENT OF THE JOINTS AT PIER A5290 IS TO BE COMPLETED UNDER THE J.O.C. CONTRACT

FQ15093

REFERENCE DRAWINGS REVISIONS 2-25-1 DESIGNED \_\_\_ESN DATE BY NUMBER DESCRIPTION **DESCRIPTION** 2-27-1 DRAWN DATE 3-3-14 DATE CHECKED ESN 4-10-14 APPROVED \_\_\_\_TGL



# WASHINGTON METROPOLITAN AREA TRANSIT AUTHORITY

2"

3"

3"

DEPARTMENT OF TRANSIT INFRASTRUCTURE AND ENGINEERING SERVICES OFFICE OF INFRASTRUCTURE RENEWAL PROGRAM

A Gannett Fleming/Parsons
JOINT VENTURE

31' - 6"

31' - 6"

31' - 6"

# RED LINE REHABILITATION GROSVENOR AERIAL STRUCTURE

DECK JOINT DETAILS

SCALE A13-S-108 NO SCALE

PROJECT MANAGER

3

INSTALLATION OF NEW FOAM JOINT SEALS.

THE MANUFACTURER'S RECOMMENDATIONS.

23, 1975, SHEETS M220-318 TO M220-326.

JOINT LOCATION

PIER NO. A5302 AHEAD

PIER NO. A5302 BACK

(4) PIER NO. A5290 AHEAD

(4) PIER NO. A5290 BACK

PIER NO. A5279 AHEAD

PIER NO. A5279 BACK

PIER NO. A5268 AHEAD

PIER NO. A5268 BACK

PIER NO. A5258 AHEAD

PIER NO. A5258 BACK

PIER NO. A5248 AHEAD

PIER NO. A5248 BACK

PIER NO. A5238 AHEAD

PIER NO. A5238 BACK

FRAME NO. A5225 AHEAD

FRAME NO. A5225 BACK

PIER NO. A5212 AHEAD

PIER NO. A5212 BACK

PIER NO. A5199 AHEAD

PIER NO. A5199 BACK

PIER NO. A5186 AHEAD

PIER NO. A5186 BACK

FRAME NO. A5174 AHEAD

FRAME NO. A5174 BACK

**ABUT. NO A5162** 

JOINT ADHESIVE AND DEBRIS SHALL BE CLEANED FROM THE VERTICAL CONCRETE JOINT FACE. MEANS AND

ARE TO BE REPAIRED IMMEDIATELY AT THE EXPENSE OF THE CONTRACTOR.

DEBRIS AND REMAINING MATERIAL WHICH MAY INHIBIT PROPER BONDING OF THE JOINT.

METHODS OF CLEANING THE JOINT SHALL BE SUBMITTED TO THE ENGINEER FOR APPROVAL PRIOR TO ANY WORK

TAKING PLACE. DAMAGE TO ANY EXISTING STRUCTURAL ELEMENTS OR TRACK EQUIPMENT ADJACENT TO THE JOINT

DRAWINGS; WMATA, SECTION A013, ROCKVILLE ROUTE, JANUARY 1976, APPROVED FOR CONSTRUCTION DECEMBER

JOINT SCHEDULE

2

2

(1) EXISTING JOINT TYPE (2) JOINT OPENING

2"

2"

3"

3"

2"

3"

2 3/4"

2"

2"

2 3/4"

2 3/4"

3 3/4"

3 3/4"

2"

2"

3"

2"

2"

3 3/4"

3 3/4"

2"

M1272 - 129

(3) JOINT LENGTH

31' - 6"

31' - 6"

30' - 9"

30' - 9"

30' - 3"

30' - 3"

30' - 0"

30' - 0"

29' - 9"

29' - 9"

30' - 9"

30' - 9"

30' - 9"

30' - 9"

31' - 3"

31' - 3"

31' - 0"

31' - 0"

30' - 9"

30' - 9"

29' - 9"

29' - 9"

30' - 9"

30' - 9"

31' - 3"

APPROVED

#### GENERAL NOTES - BEARING REPLACEMENT

- 1. FOR DESCRIPTION OF WORK, APPLICABLE REFERENCES, REQUIRED SUBMITTALS. QUALITY ASSURANCE, MATERIALS, EXECUTION, METHOD OF MEASUREMENT AND BASIS OF PAYMENT. SEE PROJECT SPECIFICATIONS IN ADDITION TO THESE NOTES.
- 2. ALL STATIONS SHOWN ON THE DRAWINGS ARE IN FEET AND REFER TO THE PROJECT COORDINATE SYSTEM USED IN THE REFERENCE DRAWINGS.
- 3. ALL ELEVATIONS SHOWN ON THE DRAWINGS ARE IN FEET AND REFER TO U.S.C & G.S. MEAN SEA LEVEL DATUM, 1929 GENERAL ADJUSTMENT.
- 4. ALL PLAN DIMENSIONS SHALL BE MEASURED IN A TRUE HORIZONTAL PLANE, UNLESS NOTED OTHERWISE.
- 5. ALL VERTICAL DIMENSIONS SHALL BE MEASURED IN A TRUE VERTICAL PLANE, UNLESS NOTED OTHERWISE.
- 6. DESIGN CRITERIA:
  - A. DESIGN CODES AND STANDARDS, CURRENT EDITIONS:
    - 1. STANDARD SPECIFICATIONS FOR HIGHWAY BRIDGES, ADOPTED BY THE AMERICAN ASSOCIATION OF STATE HIGHWAY AND TRANSPORTATION OFFICIALS (AASHTO) AS MODIFIED BY THE WASHINGTON METROPOLITAN AREA TRANSIT AUTHORITY (WMATA).
    - 2. MANUAL FOR RAILWAY ENGINEERING, OF THE AMERICAN RAILWAY ENGINEERING AND MAINTENANCE-OF-WAY ASSOCIATION (AREMA).
    - 3. WMATA MANUAL OF DESIGN CRITERIA RELEASE 9 REV.1, 2014.
    - 4. BRIDGE WELDING CODE.ANSI/AASHTO/AWS D1.5, BY THE AMERICAN WELDING SOCIETY, AASHTO AND
    - 5. AISC STEEL CONSTRUCTION MANUAL, THIRTEENTH EDITION.
  - B. DESIGN LOADS:

DESIGNED VTD

DRAWN GMJ

CHECKED RVR

APPROVED CAM

- 1. IN ACCORDANCE WITH THE MANUAL OF DESIGN CRITERIA FOR RAPID TRANSIT SYSTEM, BY WMATA.
- 7. ALL STEEL SHALL BE NEW AND IN ACCORDANCE WITH SPECIFICATIONS.
- 8. ALL PERMANENT STRUCTURAL STEEL SHALL CONFORM TO ASTM DESIGNATION A709 GRADE 50W. UNPAINTED WEATHERING STEEL UNLESS OTHERWISE NOTED. STRUCTURAL STEEL FOR TEMPORARY EXTERNAL FRAMES AT ALL PIERS SHALL CONFORM TO ASTM A709 GRADE 50.
- 9. ALL BOLTS USED SHALL HAVE THREADS EXCLUDED FROM PLANE OF SHEAR. BOLTS SHALL BE TIGHTENED USING THE TURN-OF-NUT METHOD.
- 10. HIGH STRENGTH BOLTS USED SHALL BE 7/8" DIAMETER, SLIP-CRITICAL CONFORMING TO ASTM DESIGNATION A325, TYPE 3, UNLESS OTHERWISE NOTED. All 7/8" BOLTS SHALL HAVE A MINIMUM OF 3" CENTER TO CENTER AND 1 1/2" EDGE DISTANCE UNLESS OTHERWISE NOTED.
- 11. SUBMERGED ARC WELDING ELECTRODES AND RODS SHALL BE E70XX.
- 12. ALL DIMENSIONS, LOCATIONS AND ELEVATIONS OF EXISTING STRUCTURES SHOWN ON THE DRAWINGS SHALL BE VERIFIED BY THE CONTRACTOR IN THE FIELD PRIOR TO PREPARATION OF SHOP DRAWINGS AND COMMENCEMENT OF ANY WORK. IF DISCREPANCIES ARE DISCOVERED BETWEEN EXISTING CONDITIONS AND THE CONTRACT WORK, THE CONTRACTOR SHALL IMMEDIATELY NOTIFY THE AUTHORITY REPRESENTATIVE.
- 13. FOR DETAILS OF EXISTING STRUCTURES, SEE REFERENCE DRAWINGS.

NUMBER

DATE

06-14

DATE

- 14. PRIOR TO FABRICATION OF NEW BEARINGS, CONTRACTOR SHALL VERIFY THAT OPENINGS ARE LARGE ENOUGH TO ACCESS THE BEARING AREAS FOR REMOVAL OF EXISTING AND INSTALLATION OF THE NEW BEARINGS. SEE AS-BUILT REFERENCE DRAWINGS FOR EXISTING ACCESS HATCH/OPENING LOCATIONS, ONE IN EACH SPAN AND DIRECTION, ON BOX GIRDERS TO REPLACE BEARINGS FOR THE CONTRACTOR'S BENEFIT, CONTRACTOR CAN PROVIDE ANY NEW ACCESS OPENINGS BASED ON FIELD CONDITIONS TO COMPLETE THE WORK. THE CONTRACTOR SHALL SUBMIT HIS PROPOSED NEW ACCESS LOCATIONS AND PROCEDURE TO CUT THE OPENINGS AND METHOD OF CLOSURE ONCE COMPLETED PRIOR TO COMMENCEMENT OF THE WORK FOR APPROVAL BY THE AUTHORITY REPRESENTATIVE.
- 15. TEMPLATES SHALL BE PREPARED, BEFORE FABRICATION, FOR TIGHT SPACES TO VERIFY DIMENSIONS OF NEW ELEMENTS BEING INSTALLED INTO THE EXISTING STRUCTURE.
- 16. DURING ENTIRE PERIOD OF WORKING WITH THE SHEAR BLOCK BOLTS, LIVE LOAD IS NOT PERMITTED ON THE AERIAL STRUCTURE. BOLTS SHALL BE REPLACED, IF NOTED, ONE AT A TIME DURING THE REPLACEMENT OF THE BEARINGS.
- 17. CONTRACTOR IS RESPONSIBLE FOR DESIGN OF JACKS, EXTERNAL JACK SUPPORT FRAMES/SYSTEM, JACKING OPERATIONS AND ALL REQUIRED OPERATIONS TO COMPLETE THE REPLACEMENT OF THE BEARINGS AT ABUTMENT NO. A5460, PIER NO. A5447, PIER NO. A5324 AND PIER NO. A5212.

- 18. CONTRACTOR SHALL SUBMIT HIS PROPOSED BEARING REPLACEMENT PROCEDURES AND PLANS INCLUDING JACKING PROCEDURES, JACK CALIBRATION AND CERTIFIED CALIBRATION CHARTS, AND HIS PROPOSED HYDRAULIC CONFIGURATION, FOR APPROVAL BY THE AUTHORITY REPRESENTATIVE.
- 19. UPON COMPLETION OF THE WORK THE CONTRACTOR SHALL RESTORE ALL THE WORK AREAS USED IN THE VICINITY INCLUDING, BUT NOT LIMITED TO AREAS OF TEMPORARY SUPPORT, STAGING AREAS, BACKFILLING AND RESTORING THE GRADE(S) ETC. TO IT'S ORIGINAL CONDITION PRIOR TO THE START OF THE BEARING REPLACEMENT WORK AND/OR CONTRACT.
- 20. THE EXISTING BRIDGE SUPERSTRUCTURE, COLUMNS, FOOTINGS AND TEMPORARY FRAMES SHALL BE MAINTAINED, PROTECTED AND MONITORED CONTINUOUSLY DURING JACKING AND BEARING REPLACEMENT IN ACCORDANCE WITH THE SPECIFICATIONS. IF ANY SIGN OF DISTRESS IN THE SUPERSTRUCTURE OR SUBSTRUCTURE IS NOTED, JACKING AND BEARING REPLACEMENT OPERATIONS SHALL BE IMMEDIATELY HALTED AND THE AUTHORITY REPRESENTATIVE NOTIFIED.
- 21. CONTRACTOR SHALL NOT DRILL OR CUT ANY HOLES OR PROVIDE ANY PERMANENT ATTACHMENTS TO THE AERIAL STRUCTURE EXCEPT AS NOTED ON THE PLANS OR AS APPROVED BY THE AUTHORITY REPRESENTATIVE.
- 22. THE AERIAL STRUCTURE SHALL NOT BE JACKED FOR BEARING REPLACEMENT IN ADVERSE WEATHER CONDITIONS OR WHEN WINDS EXCEED 15 MILES PER HOUR.
- 23. THE CONTRACTOR SHALL MAINTAIN, PROTECT AND MONITOR EXISTING DRAIN PIPES AND UTILITIES DURING THE EXECUTION OF THE WORK.
- 24. IF REQUIRED, THE CONTRACTOR SHALL DISCONNECT AND SUPPORT UTILITIES DURING ENTIRE BEARING REPLACEMENT PROCESS. THE CONTRACTOR SHALL RESTORE UTILITIES IMMEDIATELY AFTER THE NEW BEARINGS ARE INSTALLED. HAND RAILS, RUNNING RAILS AND CONTACT RAIL FASTENERS WILL BE RELEASED AND RESTORED BY WMATA.
- 25. SEE SPECIFICATION SECTION 01140 ACCESS TO WORKSITE FOR HOURS OF WORK.
- 26. THE CONTRACTOR SHALL EXERCISE CAUTION WHEN WORKING IN THE VICINITY OF EXISTING CONDUITS.
- 27. DURING FLAME CUTTING, THE CONTRACTOR SHALL PROVIDE PROTECTIVE BLANKETS TO SHIELD EXISTING BEARINGS, CONDUITS, STEEL AND OTHER BRIDGE ELEMENTS FROM HIGH TEMPERATURES AND MOLTEN STEEL.
- 28. VENTILATION AND LIGHTING SHALL BE MAINTAINED INSIDE THE BOX GIRDERS DURING ENTIRE PERIOD OF THE BEARINGS REPLACEMENT.
- 29. EDGES OF ALL FLAME CUT AND NEW HOLES SHALL BE GROUND SMOOTH, FREE OF BURRS AND SHARP EDGES IMMEDIATELY AFTER OPENINGS ARE CUT.
- 30. DUE TO TIGHT CLEARANCES, THE CONTRACTOR MAY BE REQUIRED TO CUT THE EXISTING BEARINGS IN ORDER TO REMOVE THEM.
- 31. DURING JACKING LIVE LOAD IS NOT PERMITTED ON THE BRIDGE UNTIL THE NEW BEARINGS ARE PROPERLY SEATED AND THE JACKS HAVE BEEN REMOVED.
- 32. FOR ABUTMENT (A5460) ELEVATION AND SECTION, SEE AS-BUILT PLAN SHEET NO. M220-248 AND M220-249.testing

PROFESSIONAL CERTIFICATION: I HEREBY CERTIFY THAT THESE DOCUMENTS WERE PREPARED OR APPROVED BY ME. AND THAT I AM A DULY LICENSED PROFESSIONAL ENGINEER UNDER THE LAWS OF THE STATE OF MARYLAND, LICENSE NO. 15211, EXPIRATION DATE 12/23/16

APPROVED -

REFERENCE DRAWINGS REVISIONS DESCRIPTION DATE BY DESCRIPTION



AND ENGINEERING SERVICES OFFICE OF INFRASTRUCTURE RENEWAL PROGRAM



RED LINE REHAB.-FRIENDSHIP HEIGHTS TO **GROSVENOR - PART 3** 


BEARING REPLACEMENT GENERAL NOTES


Brad Mason, P.E. SUBMITTED PROJECT MANAGER

SCALE


M1272-130 A13-S-109 NO SCALE


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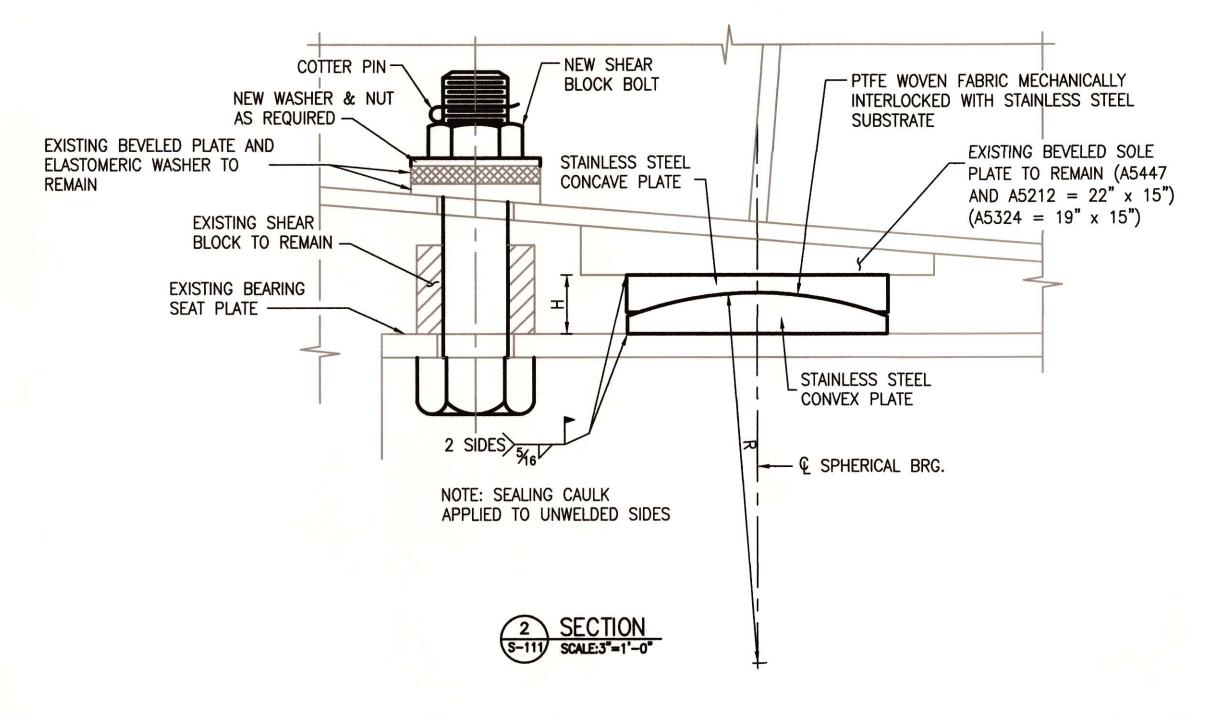

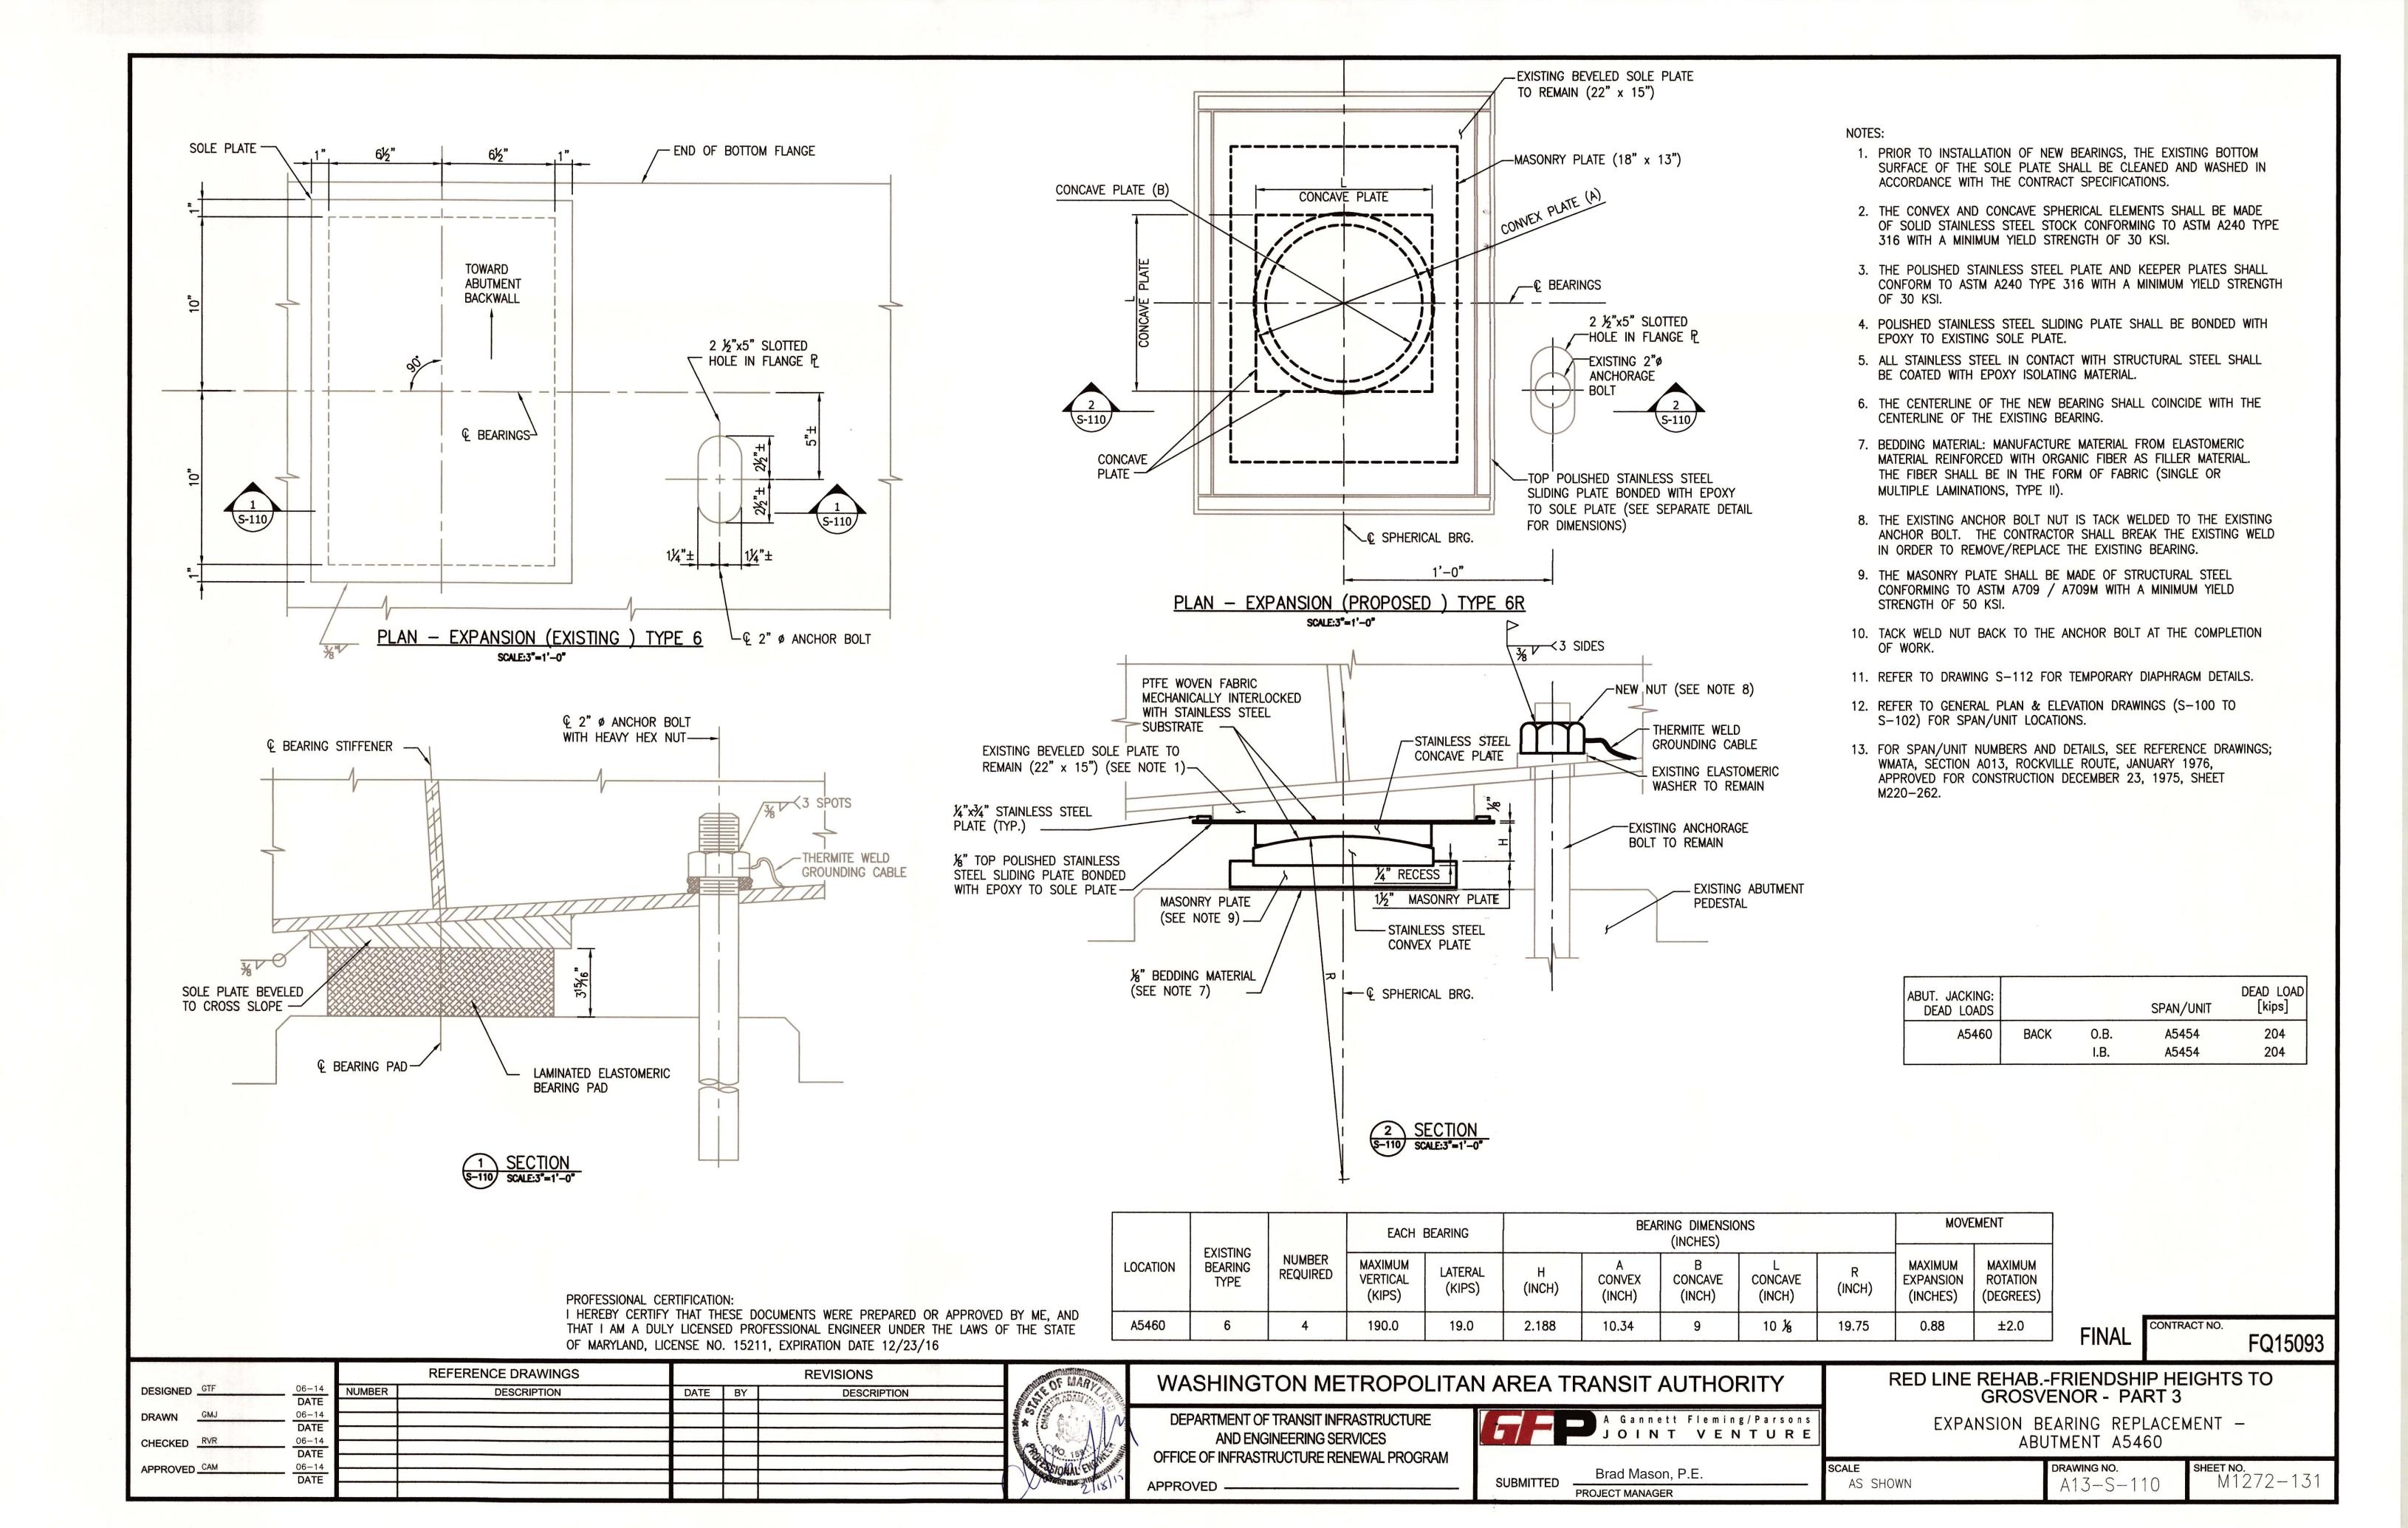
# PLAN - FIXED (EXISTING) TYPE 7 & 8 SCALE:3"=1'-0"

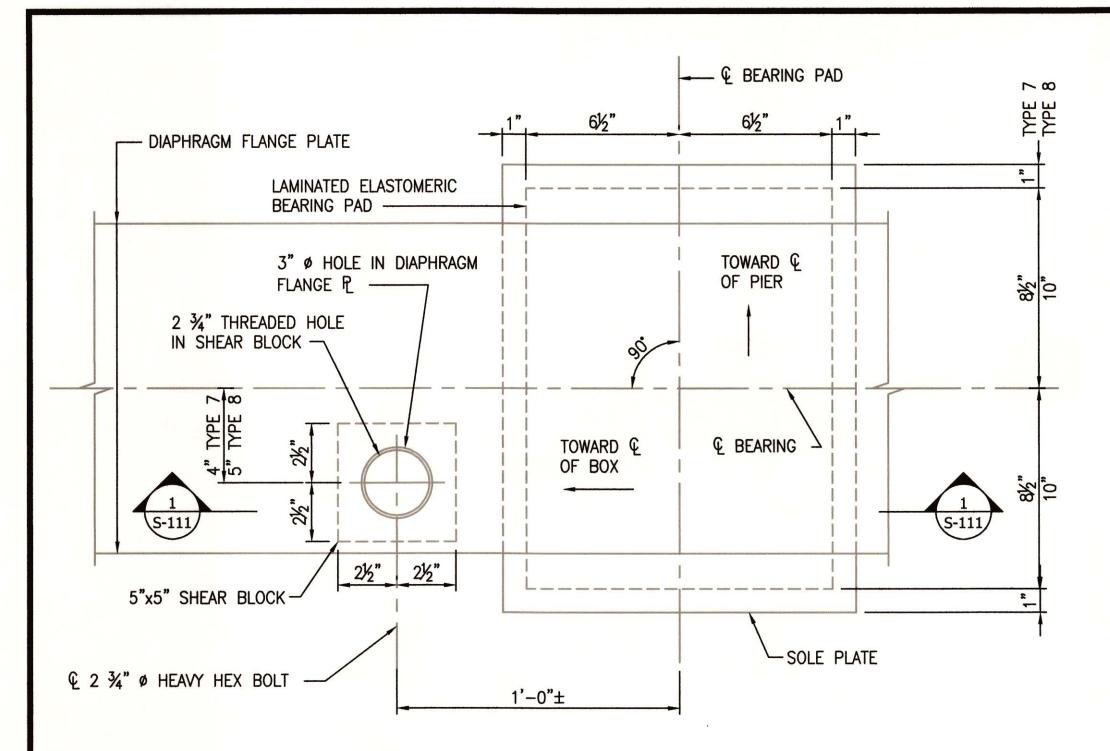

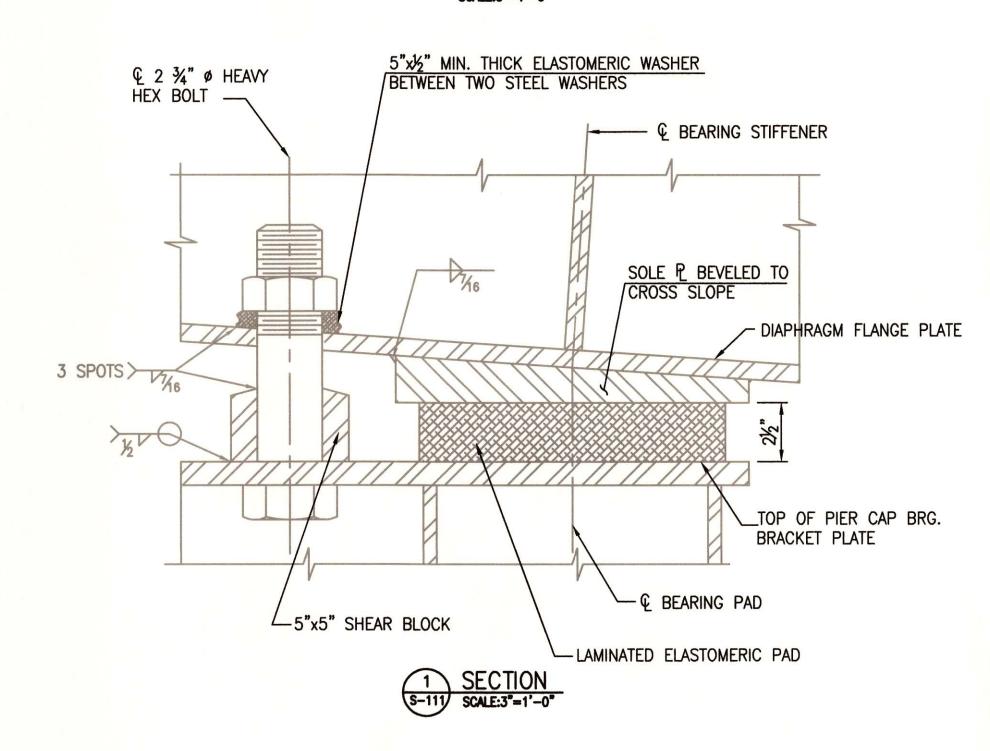

PLAN - FIXED (PROPOSED) TYPE 7R & 8R

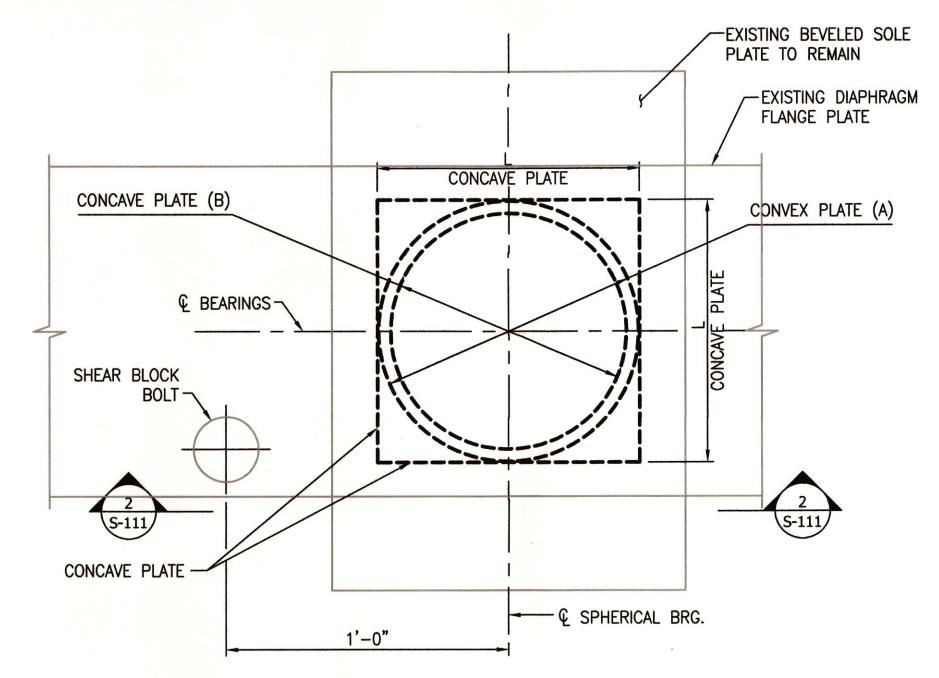

| PIER JACKING:<br>DEAD LOADS |       |              | SPAN/UNIT      | DEAD LOAD<br>[kips] |
|-----------------------------|-------|--------------|----------------|---------------------|
| A5447                       | AHEAD | 0.B.<br>I.B. | A5454<br>A5454 | 204<br>204          |
|                             | BACK  | 0.B.<br>I.B. | A5441<br>A5441 | 199<br>199          |
| A5324                       | AHEAD | O.B.<br>I.B. | A5330<br>A5330 | 178<br>178          |
|                             | BACK  | O.B.<br>I.B. | A5318<br>A5318 | 179<br>179          |
| A5212                       | AHEAD | O.B.<br>I.B. | A5219<br>A5219 | 215<br>205          |
|                             | BACK  | 0.B.<br>I.B. | A5206<br>A5206 | 210<br>210          |

#### NOTES:

- 1. PRIOR TO INSTALLATION OF NEW BEARINGS, THE EXISTING BOTTOM SURFACE OF THE SOLE PLATE SHALL BE CLEANED AND WASHED IN ACCORDANCE WITH THE CONTRACT SPECIFICATIONS
- 2. THE CONVEX AND CONCAVE SPHERICAL ELEMENTS SHALL BE MADE OF SOLID STAINLESS STEEL STOCK CONFORMING TO ASTM A240 TYPE 316 WITH A MINIMUM YIELD STRENGTH OF 30 KSI
- 3. SHEAR BLOCK BOLTS, NUTS AND WASHERS SHALL CONFORM TO ASTM A588. BOLTS, NUTS AND WASHERS SHALL BE COATED WITH ZINC.
- 4. ¼" HOLE SHALL BE SHOP DRILLED FOR ¼" DIAMETER COTTER PIN.
- 5. THE EXISTING SHEAR BLOCK BOLT IS TACK WELDED TO THE EXISTING SHEAR BLOCK. THE CONTRACTOR SHALL BREAK EXISTING WELD BETWEEN BOLT AND SHEAR BLOCK IN ORDER TO REMOVE BOLT WITHOUT DAMAGING EXISTING SHEAR BLOCK.
- 6. ALL STAINLESS STEEL IN CONTACT WITH STRUCTURAL STEEL SHALL BE COATED WITH EPOXY ISOLATING MATERIAL.
- 7. THE CENTERLINE OF THE NEW BEARING SHALL COINCIDE WITH THE CENTERLINE OF THE EXISTING BEARING.
- 8. TACK WELD NUT BACK TO THE ANCHOR BOLT AT THE COMPLETION OF WORK.
- 9. REFER TO DRAWING S-112 FOR TEMPORARY DIAPHRAGM DETAILS.
- 10. REFER TO GENERAL PLAN & ELEVATION DRAWINGS (S-100 TO S-102) FOR SPAN/UNIT LOCATIONS.
- 11. FOR SPAN/UNIT NUMBERS AND DETAILS, SEE REFERENCE DRAWINGS; WMATA, SECTION A013, ROCKVILLE ROUTE, JANUARY 1976, APPROVED FOR CONSTRUCTION DECEMBER 23, 1975, SHEETS M220-262 THRU M22-281.

|          | EVICTINO                    |                    | EACH I                        | BEARING           |             | BEAF                  | RING DIMENSIO          | NS                     |             | MOVE                             | MENT                             |
|----------|-----------------------------|--------------------|-------------------------------|-------------------|-------------|-----------------------|------------------------|------------------------|-------------|----------------------------------|----------------------------------|
| LOCATION | EXISTING<br>BEARING<br>TYPE | NUMBER<br>REQUIRED | MAXIMUM<br>VERTICAL<br>(KIPS) | LATERAL<br>(KIPS) | H<br>(INCH) | A<br>CONVEX<br>(INCH) | B<br>CONCAVE<br>(INCH) | L<br>CONCAVE<br>(INCH) | R<br>(INCH) | MAXIMUM<br>EXPANSION<br>(INCHES) | MAXIMUM<br>ROTATION<br>(DEGREES) |
| A5447    | 8                           | 8                  | 188.75                        | 28.31             | 2.498       | 11.04                 | 10                     | 11.125                 | 15.75       | N/A                              | ±2.0                             |
| A5324    | 7                           | 8                  | 177.50                        | 26.63             | 2.498       | 11.04                 | 10                     | 11.125                 | 15.75       | N/A                              | ±2.0                             |
| A5212    | 8                           | 8                  | 192.50                        | 28.88             | 2.498       | 11.04                 | 10                     | 11.125                 | 15.75       | N/A                              | ±2.0                             |

CONTRACT NO. FQ15093

| OF MARYLAND, LICENSE NO. 15211, EXPIRATION DATE 12/23/16
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| OF MARYLAND, LICENSE NO. 15211, EXPIRA

PROFESSIONAL CERTIFICATION:

I HEREBY CERTIFY THAT THESE DOCUMENTS WERE PREPARED OR APPROVED BY ME, AND

THAT I AM A DULY LICENSED PROFESSIONAL ENGINEER UNDER THE LAWS OF THE STATE



# WASHINGTON METROPOLITAN AREA TRANSIT AUTHORITY

DEPARTMENT OF TRANSIT INFRASTRUCTURE
AND ENGINEERING SERVICES
OFFICE OF INFRASTRUCTURE RENEWAL PROGRAM

APPROVED



SUBMITTED Brad Mason, P.E.

PROJECT MANAGER


RED LINE REHAB.-FRIENDSHIP HEIGHTS TO GROSVENOR - PART 3

FIXED BEARING REPLACEMENT — PIER A5447, A5324 AND A5212

**FINAL** 

ALE DRAWING NO.
AS SHOWN A13-S-111

M1272-132

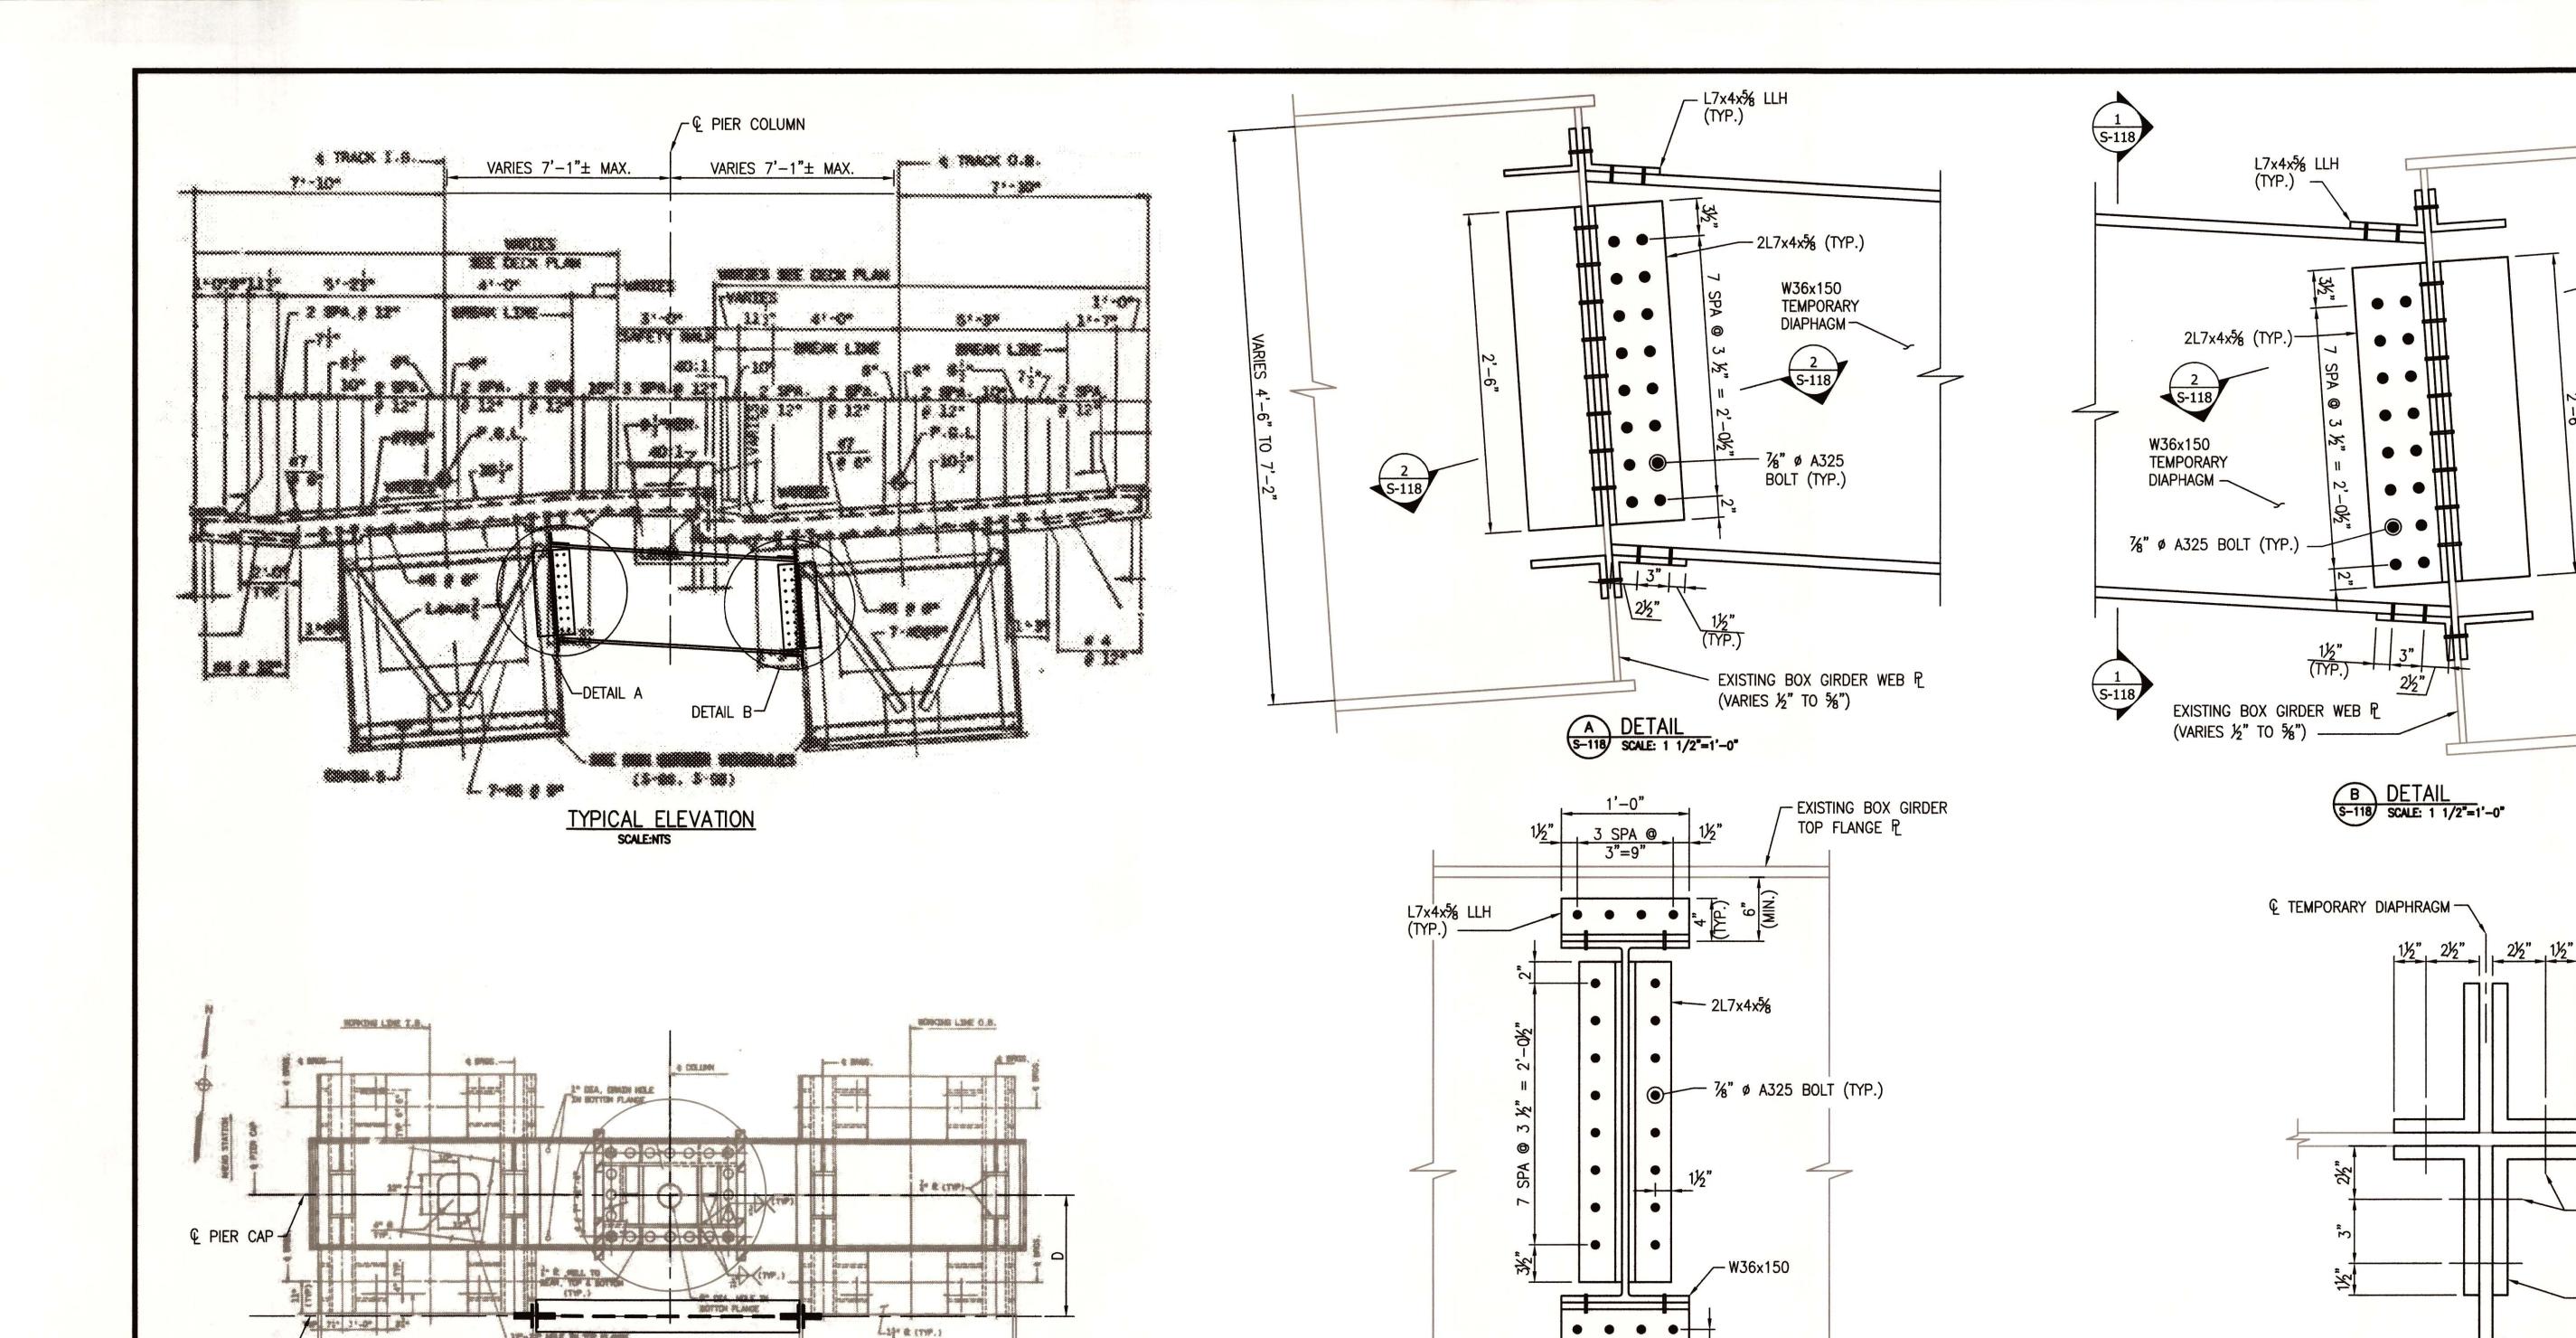

TEMPORARY DIAPHRAGM PLAN

LOCATION D (FT) A5460 1'-6"±\* 5'-9"± A5447 A5324 5'-0"± A5212 5'-9"±

\* THIS DIMENSION MEASURED FROM & OF BEARING AT ABUTMENT

€ W36x150 -

JACKING DIAPHRAGMS SHALL BE LOCATED TO AVOID


ALL INTERIOR EXISTING STRUCTURAL COMPONENTS

PROFESSIONAL CERTIFICATION: I HEREBY CERTIFY THAT THESE DOCUMENTS WERE PREPARED OR APPROVED BY ME, AND THAT I AM A DULY LICENSED PROFESSIONAL ENGINEER UNDER THE LAWS OF THE STATE OF MARYLAND, LICENSE NO. 15211, EXPIRATION DATE 12/23/16

EXISTING BOX GIRDER BOTTOM FLANGE P

APPROVED

REFERENCE DRAWINGS **REVISIONS** 06-14 **DATE** DESIGNED VTD DESCRIPTION DATE BY DESCRIPTION NUMBER DRAWN GMJ DATE CHECKED RVR 06-14 **DATE** APPROVED CAM 06-14 DATE

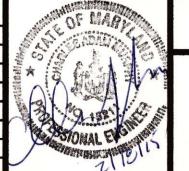

1 SECTION S-118 SCALE: 1 1/2"=1'-0"

DEPARTMENT OF TRANSIT INFRASTRUCTURE AND ENGINEERING SERVICES OFFICE OF INFRASTRUCTURE RENEWAL PROGRAM



RED LINE REHAB.-FRIENDSHIP HEIGHTS TO **GROSVENOR - PART 3** 

2 SECTION S-118 SCALE: 3"=1'-0"

TEMPORARY DIAPHRAGM DETAILS

**FINAL** 

M1272 - 133A13-S-112

FQ15093

— EXISTING BOX GIRDER WEB

-€ %" ø A325 BOLT (TYP.)

---2L7x4x% (TYP.)

DIAPHRAGM

---W36x150 TEMPORARY

S-118

WASHINGTON METROPOLITAN AREA TRANSIT AUTHORITY

Brad Mason, P.E.


PROJECT MANAGER

SCALE AS SHOWN


#### MECHANICAL GENERAL NOTES

- 1. ALL NEW WORK SHALL COMPLY WITH NATIONAL, STATE, AND LOCAL CODE REQUIREMENTS, INCLUDING BUT NOT LIMITED TO THE FOLLOWING (SEE SPECIFICATIONS FOR LISTING OF APPLICABLE CODES AND STANDARDS):

  1.a. 2012 INTERNATIONAL BUILDING CODE
  - 1.b. 2012 INTERNATIONAL PLUMBING CODE

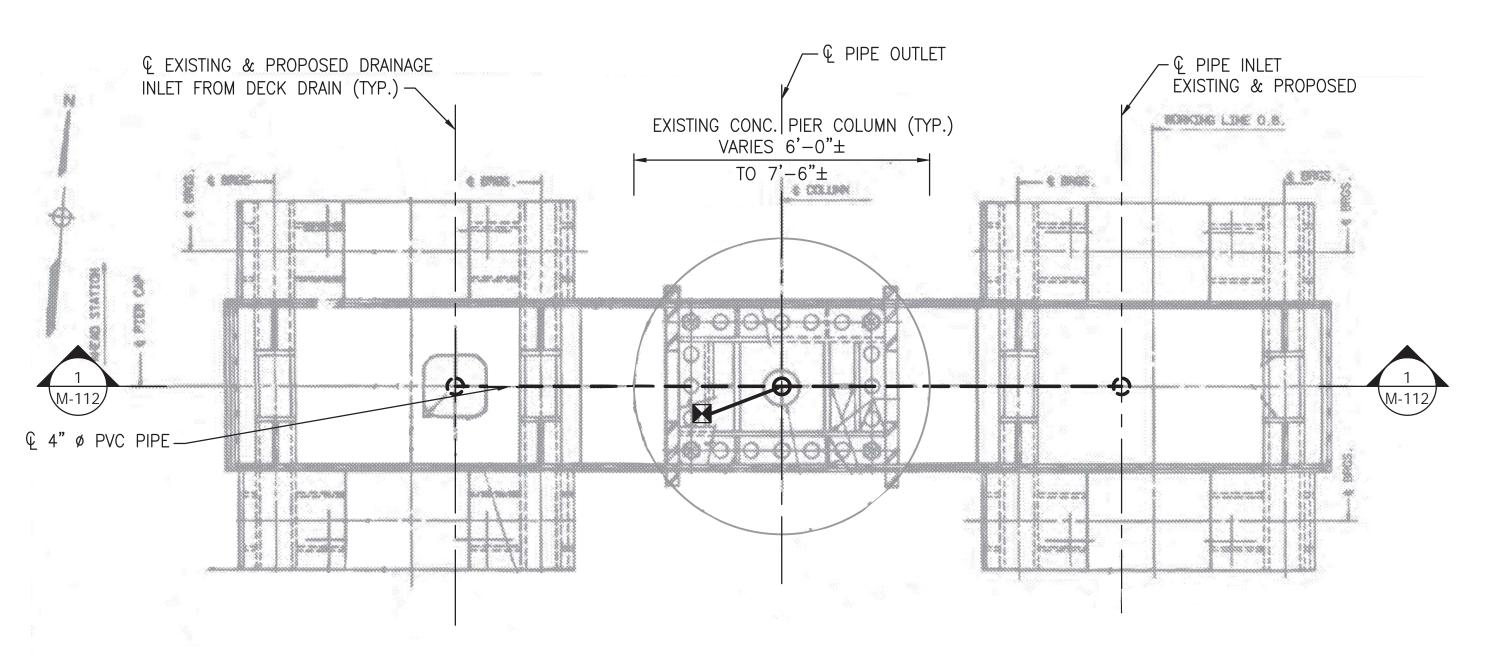

TYPICAL PIER CAP DRAINAGE PLAN (EXISTING)
SCALE:N.T.S.

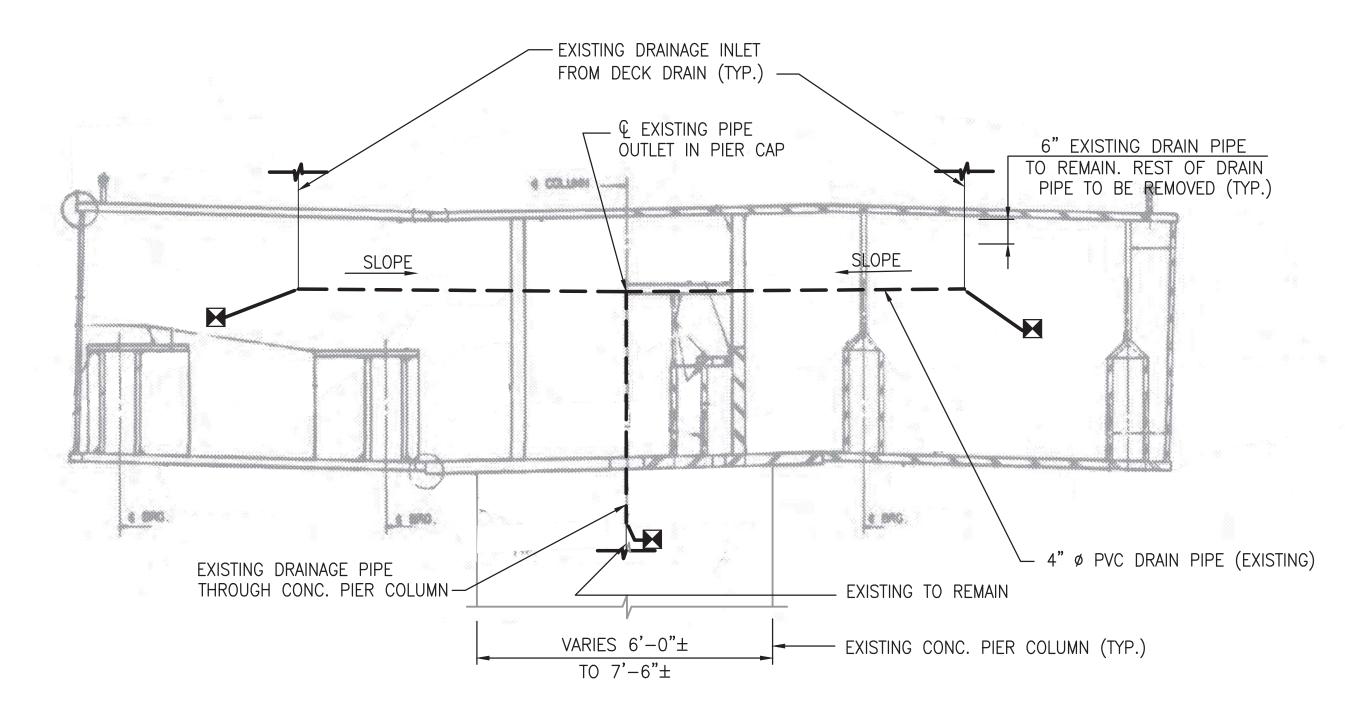

#### NOTES:

- 1. REFER TO AS-BUILT PLAN SHEET NOS. M220-214 THRU M220-348 FOR PIER CAP & OTHER STRUCTURAL DETAILS.
- 2. REFER TO AS-BUILT PLAN SHEET NOS. M220-77 THRU M220-82 FOR EXISTING DRAINAGE DETAILS.
- 3. REMOVE ALL EXISTING 4" DIA. PVC DRAIN PIPES INSIDE PIER CAP BOXES BEGINNING FROM THE BOTTOM OF THE DECK DRAIN DOWNSPOUTS ALL THE WAY TO THE EXISTING DRAINAGE DOWNSPOUT THROUGH THE CENTER OF THE CONCRETE PIER COLUMN.
- 4. REMOVE AND REPLACE ALL EXISTING PIPE SUPPORT BRACKETS/HANGERS AND U-BOLTS INSIDE THE PIER CAP SUPPORTING THE EXISTING PVC DRAIN PIPE SYSTEM.

1 ELEVATION — SECTION (EXISTING)
SCALE:N.T.S.

PROFESSIONAL CERTIFICATION. I HEREBY CERTIFY THAT THESE DOCUMENTS WERE PREPARED OR APPROVED BY ME, AND THAT I AM A DULY LICENSED PROFESSIONAL ENGINEER UNDER THE LAWS OF THE STATE OF MARYLAND, LICENSE NO. 23210, EXPIRATION DATE 06-30-2016.

APPROVED -



### WASHINGTON METROPOLITAN AREA TRANSIT AUTHORITY

SUBMITTED

DEPARTMENT OF TRANSIT INFRASTRUCTURE
AND ENGINEERING SERVICES
OFFICE OF INFRASTRUCTURE RENEWAL PROGRAM



PROJECT MANAGER


RED LINE REHAB.-FRIENDSHIP HEIGHTS TO GROSVENOR - PART 3


EXISTING DRAINAGE REMOVAL DETAILS, TYPE I — AT TYPICAL CANTILEVER STEEL CAP AND SINGLE COLUMN PIER

SCALE DRAWING NO. SHEET NO. M1272-134

FINAL

FQ15093

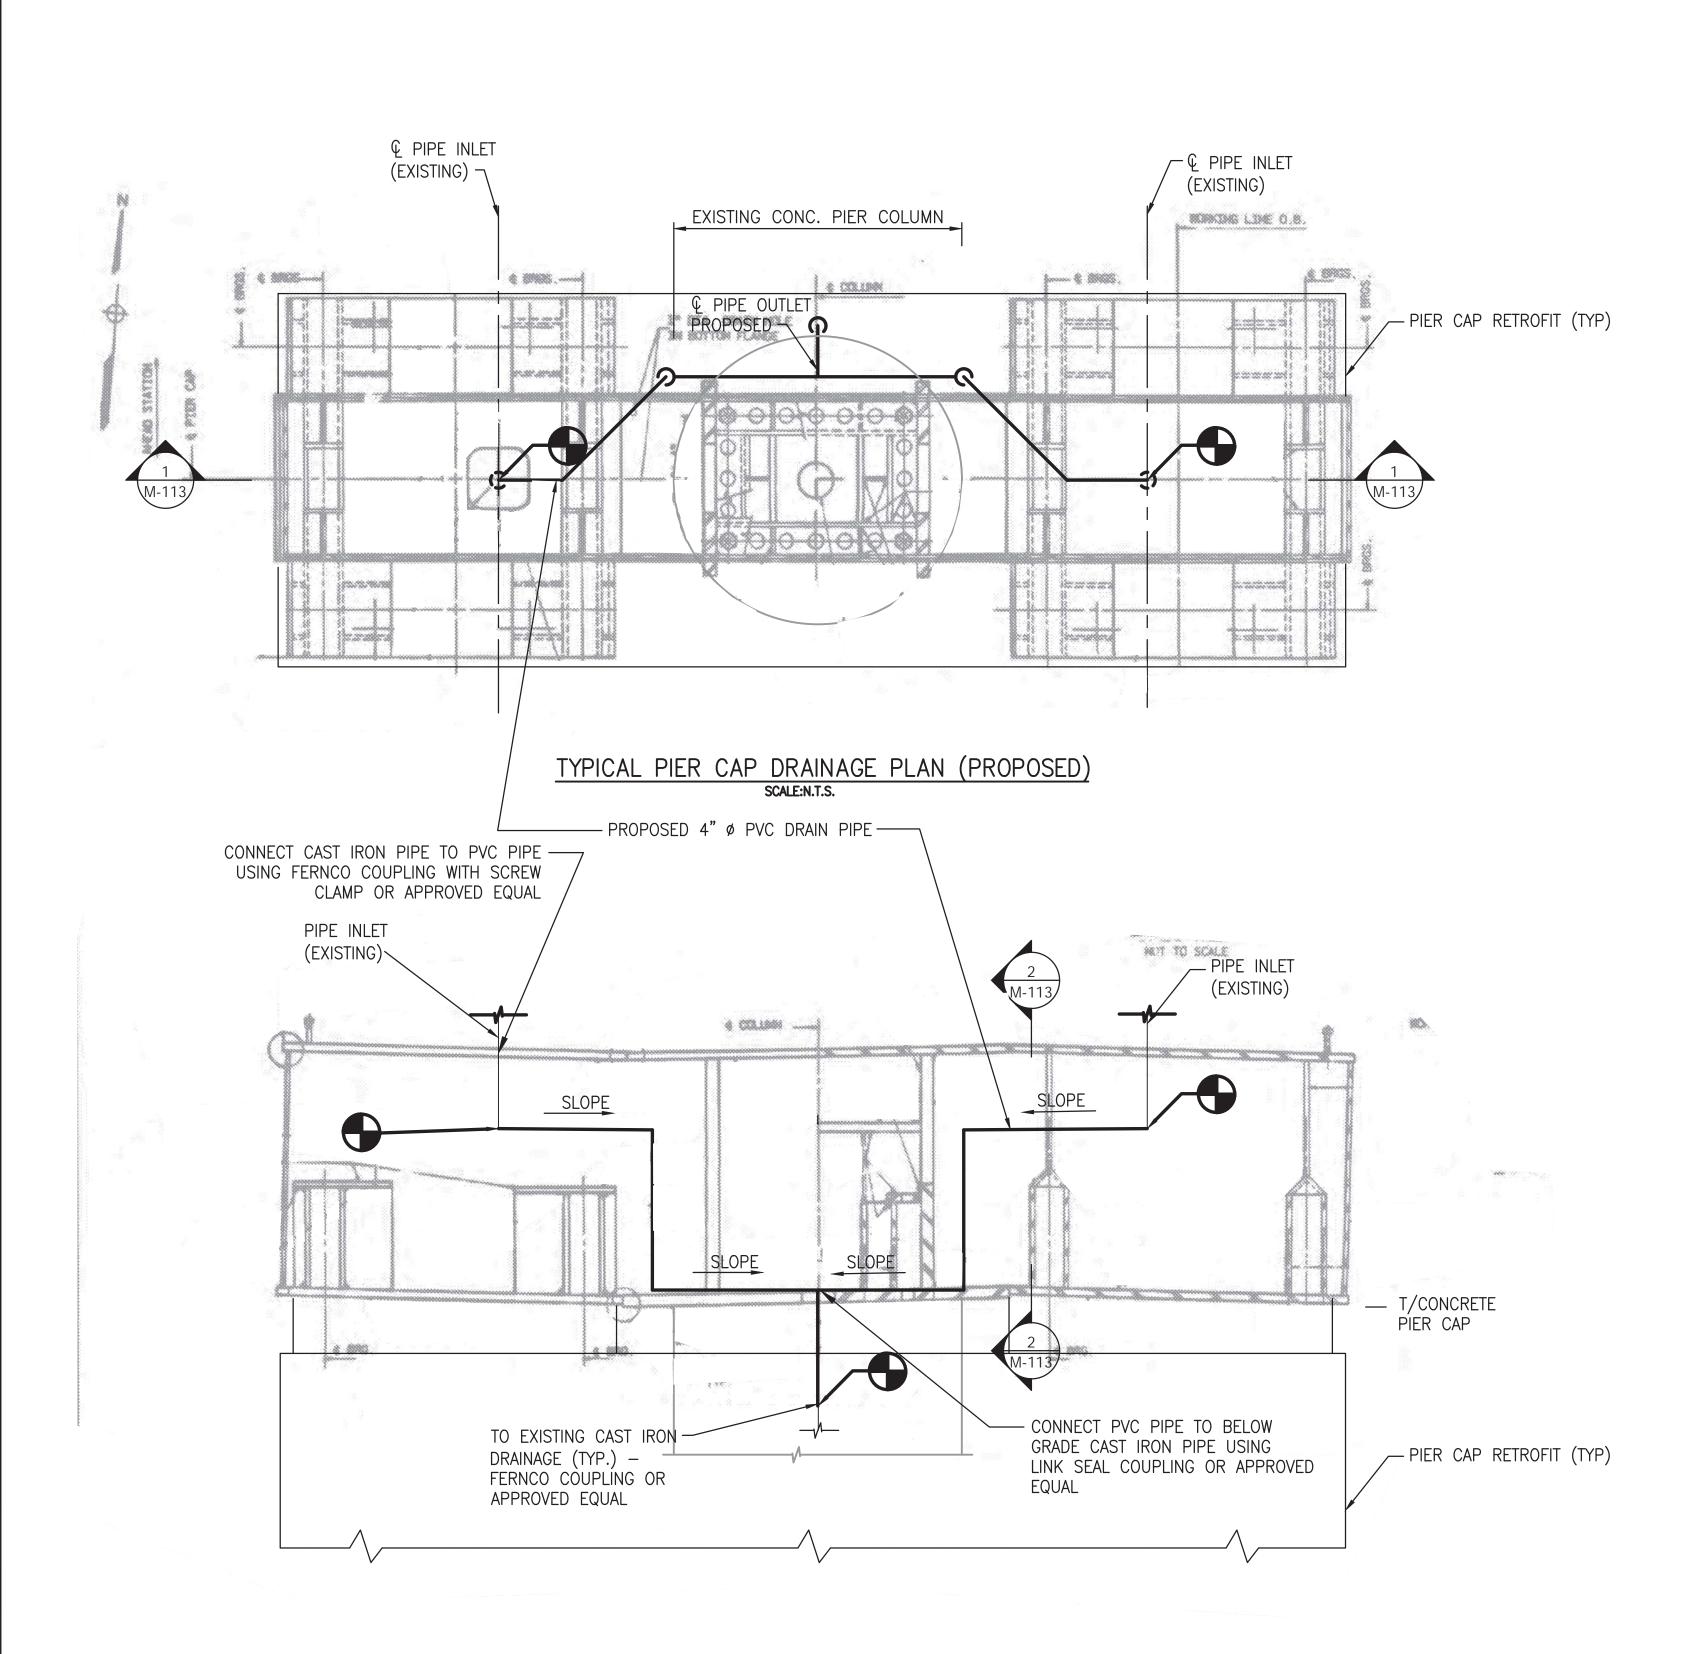

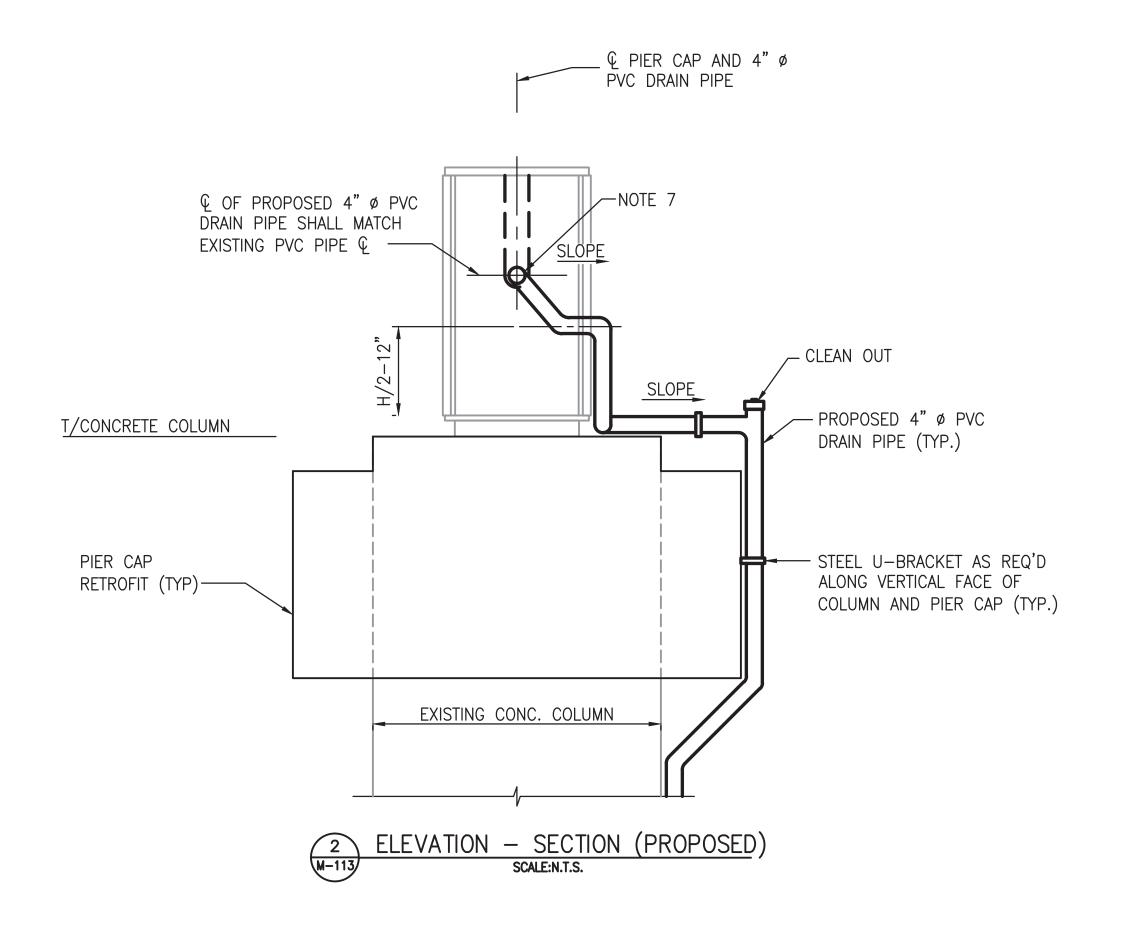

#### NOTES:

- 1. REPLACE ALL EXISTING PIPE SUPPORT BRACKETS/HANGERS AND U-BOLTS INSIDE THE PIER CAP SUPPORTING THE EXISTING PVC DRAIN PIPE SYSTEM.
- 2. PLUG AND SEAL EXISTING DRAIN PIPE IN CENTER OF CONCRETE PIER COLUMN A MINIMUM OF 1 FT. WITH GROUT. SEE SPECIFICATION SECTION 036213 FOR NON-METALLIC, NON-SHRINK GROUT.
- 3. TO EXIT THE PROPOSED DRAIN PIPE OUT OF STEEL PIER CAP, CUT TWO (2) 6" DIA. HOLES IN THE WEB OF THE STEEL PIER CAP BOX AS SHOWN IN THE PLANS. THE CENTERLINE OF NEW HOLES IN THE WEB SHALL BE ALIGNED HORIZONTALLY MIDWAY BETWEEN THE INSIDE FACE OF THE STEEL BOX BEAM WEB AND ADJACENT TRANSVERSE WEB STIFFENER NEAR THE CENTER OF THE STEEL PIER CAP. CENTERLINE OF CUT HOLES IN THE WEB SHALL BE VERTICALLY LOCATED SUCH THAT IT WILL ALLOW POSITIVE DRAINAGE INTO THE DOWNSPOUT PIPE.
- 4. INSTALL PROPOSED 4" DIA. PVC DRAIN PIPE INSIDE STEEL PIER CAP. PROPOSED DRAIN PIPE SHALL EXIT PIER CAP THROUGH NEWLY MADE HOLES IN THE WEB. AFTER EXITING THE PIER CAP, THE PROPOSED DRAIN PIPE SHALL CONTINUE DOWN ALONG THE FACE OF PROPOSED PIER CAP RETROFIT AND CONCRETE PIER COLUMN AND CONNECT TO THE EXISTING AT GRADE OR BELOW GRADE DRAINAGE SYSTEM.
- 5. MINIMUM SLOPE OF PIPES SHALL BE 1/4" PER FOOT.
- 6. ALL UNDERGROUND PIPING SHALL MATCH EXISTING PIPE SYSTEMS. FOR EXISTING DRAINAGE DETAILS SEE AS-BUILT PLANS M220-77 THRU M220-82.
- 7. ALL PVC PIPE SHALL BE SCHEDULE 80.

1 ELEVATION — SECTION (PROPOSED)
SCALE:N.T.S.

PROFESSIONAL CERTIFICATION. I HEREBY CERTIFY THAT THESE DOCUMENTS WERE PREPARED OR APPROVED BY ME, AND THAT I AM A DULY LICENSED PROFESSIONAL ENGINEER UNDER THE LAWS OF THE STATE OF MARYLAND, LICENSE NO. 23210, EXPIRATION DATE 06-30-2016.

APPROVED —

FINAL

FQ15093



#### WASHINGTON METROPOLITAN AREA TRANSIT AUTHORITY

DEPARTMENT OF TRANSIT INFRASTRUCTURE
AND ENGINEERING SERVICES
OFFICE OF INFRASTRUCTURE RENEWAL PROGRAM

A Gannett Fleming/Parsons
JOINT VENTURE


Brad Mason, P.E.

PROJECT MANAGER

RED LINE REHAB.-FRIENDSHIP HEIGHTS TO GROSVENOR - PART 3

PROPOSED DRAINAGE DETAILS, TYPE I R — AT TYPICAL CANTILEVER CAP AND SINGLE COLUMN PIER


SCALE DRAWING NO. SHEET NO. M1272-135

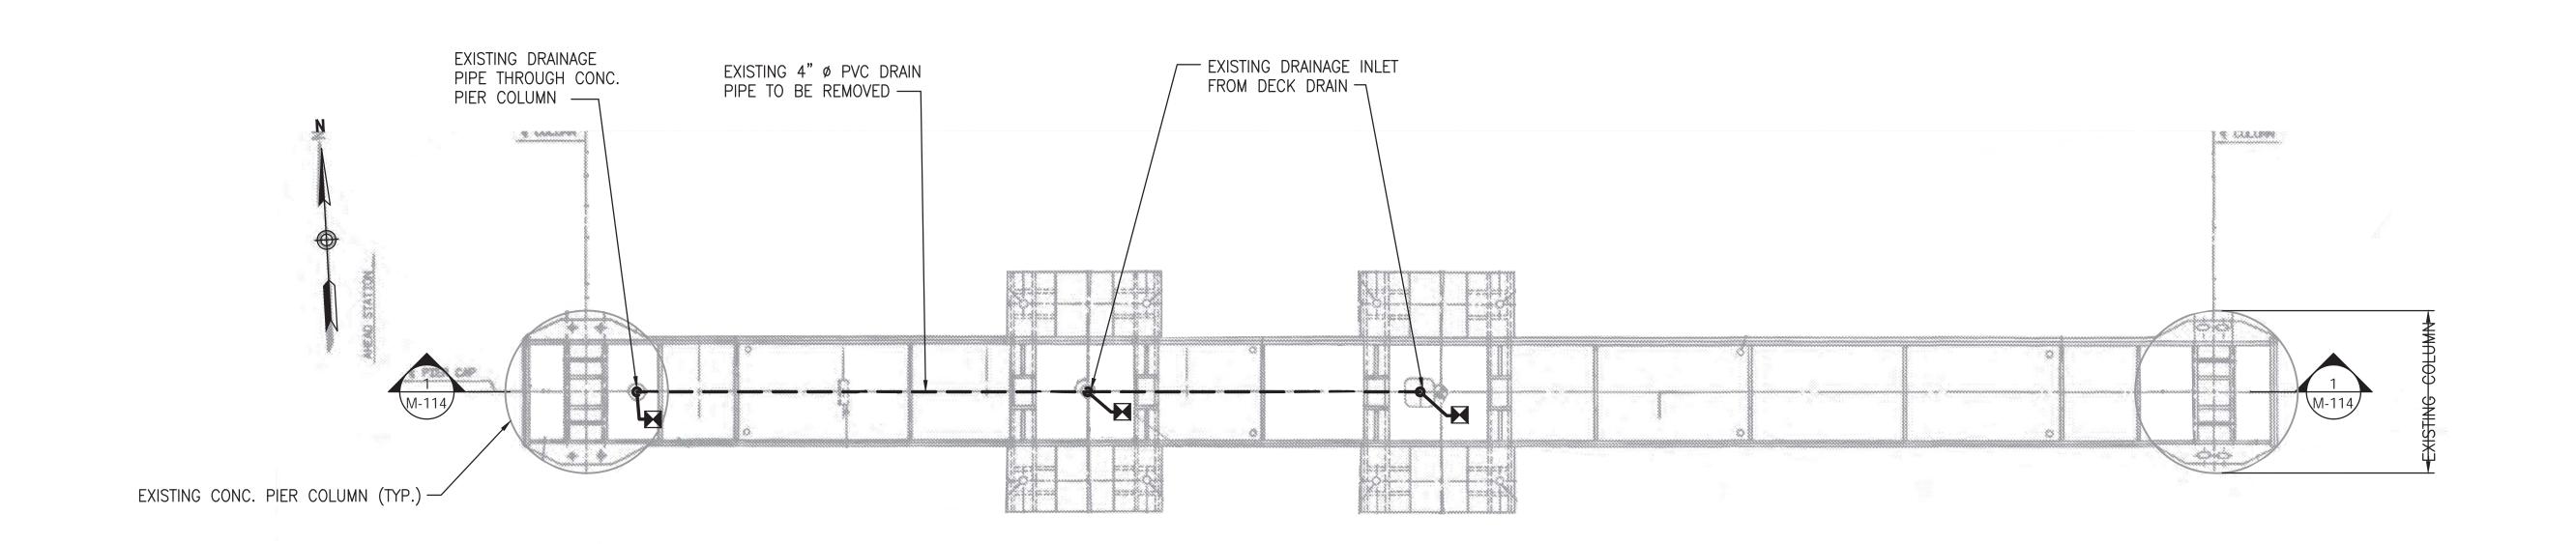

#### A5419 PIER CAP FRAME DRAINAGE PLAN (EXISTING) SCALE:N.T.S.

#### NOTES:

- 1. REFER TO AS-BUILT PLAN SHEET NO M220-77, M220-293 & 294 FOR MORE DETAILS ABOUT EXISTING DRAINAGE AND STEEL PIER CAP.
- 2. REMOVE ALL EXISTING 4" DIA. PVC DRAIN PIPES INSIDE PIER CAP BOXES BEGINNING FROM THE BOTTOM OF THE DECK DRAIN DOWNSPOUTS ALL THE WAY TO THE EXISTING DRAINAGE DOWNSPOUT THROUGH THE CENTER OF THE CONCRETE PIER FRAME COLUMN.
- 3. REMOVE AND REPLACE ALL EXISTING PIPE SUPPORT BRACKETS/HANGERS AND U-BOLTS INSIDE THE PIER CAP SUPPORTING THE EXISTING PVC DRAIN PIPE SYSTEM.

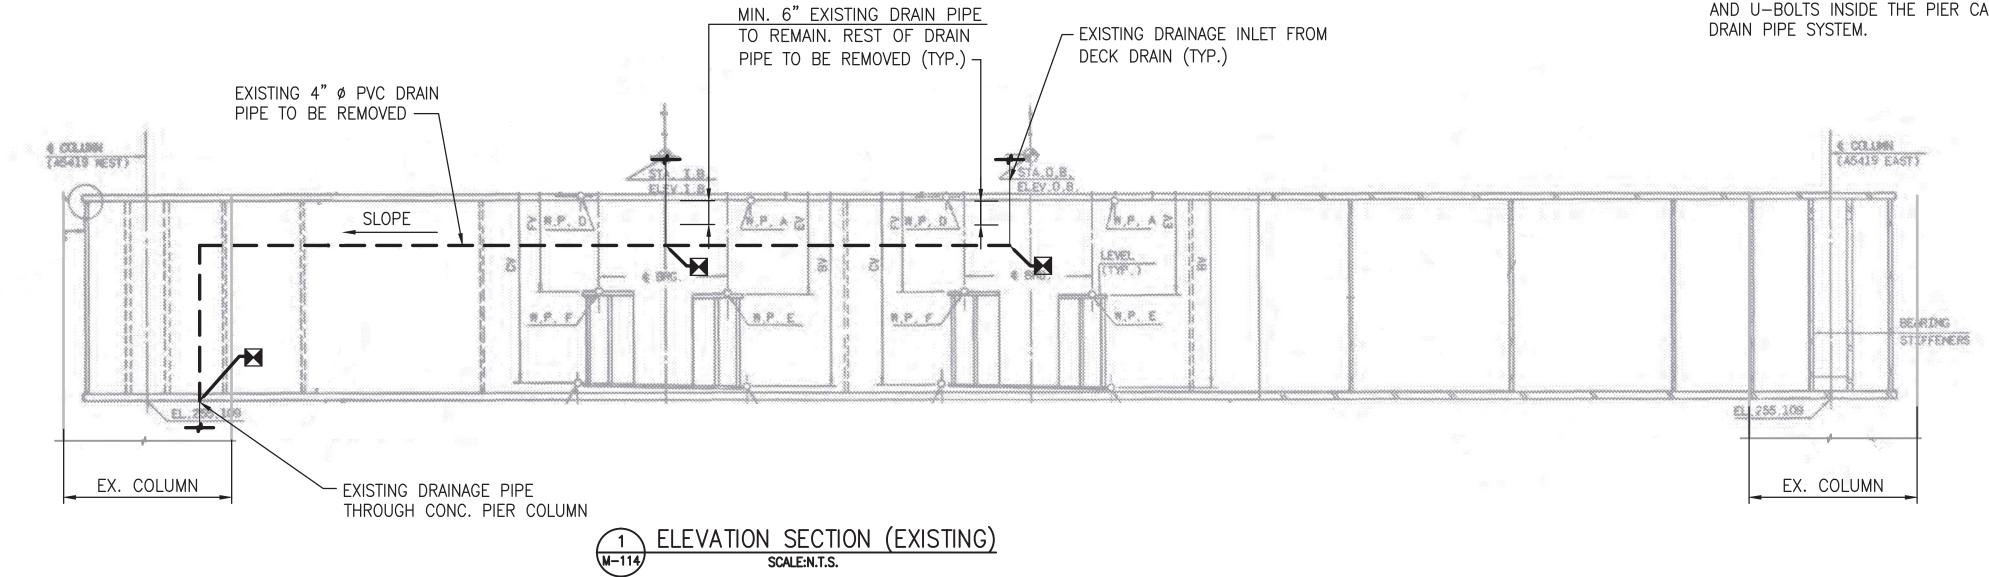

PROFESSIONAL CERTIFICATION. I HEREBY CERTIFY THAT THESE DOCUMENTS WERE PREPARED OR APPROVED BY ME, AND THAT I AM A DULY LICENSED PROFESSIONAL ENGINEER UNDER THE LAWS OF THE STATE OF MARYLAND, LICENSE NO. 23210, EXPIRATION DATE 06-30-2016.

APPROVED ——

FINAL

FQ15093

|              |                         | R      | EFERENCE DRAWINGS |      |  | REVISIONS   |             |
|--------------|-------------------------|--------|-------------------|------|--|-------------|-------------|
| DESIGNED DPR | 11/2014<br>DATE         | NUMBER | DESCRIPTION       | DATE | BY   | DESCRIPTION |             |
| DRAWN DPR    | 11/2014                 |        |                   |      |  |             | -           |
|              | DATE                    |        |                   |      |  |             | $\neg \neg$ |
| CHECKED CMR  | <u>11/201</u> 4<br>DATE |        |                   |      |  |             |             |
| APPROVED JP  | 11/2014                 |        |                   |      | <del>                                     </del> |             |             |
|              | DATE                    |        |                   |      | <del>                                     </del> |             | _           |



# WASHINGTON METROPOLITAN AREA TRANSIT AUTHORITY


DEPARTMENT OF TRANSIT INFRASTRUCTURE AND ENGINEERING SERVICES OFFICE OF INFRASTRUCTURE RENEWAL PROGRAM


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|--|---|--|--|--|--|--|
| Brad Mason, P.E. SUBMITTED ——————————————————————————————————— |   |  |  |  |  |  |
| SOBMITTED  | PROJECT MANAGER                         |  |  |  |  |  |

| RED LINE REHABFRIENDSHIP HEIGHTS TO GROSVENOR - PART 3 |                 |  |  |  |  |
|--|-----------------|--|--|--|--|
| EXISTING DRAINAGE                                      | REMOVAL DETAILS |  |  |  |  |

TYPE II - PIER A5419


| SCALE        | DRAWING NO. | SHEET NO. |
|--------------|-------------|-----------|
| NOT TO SCALE | A13-M-114   | M1272-136 |

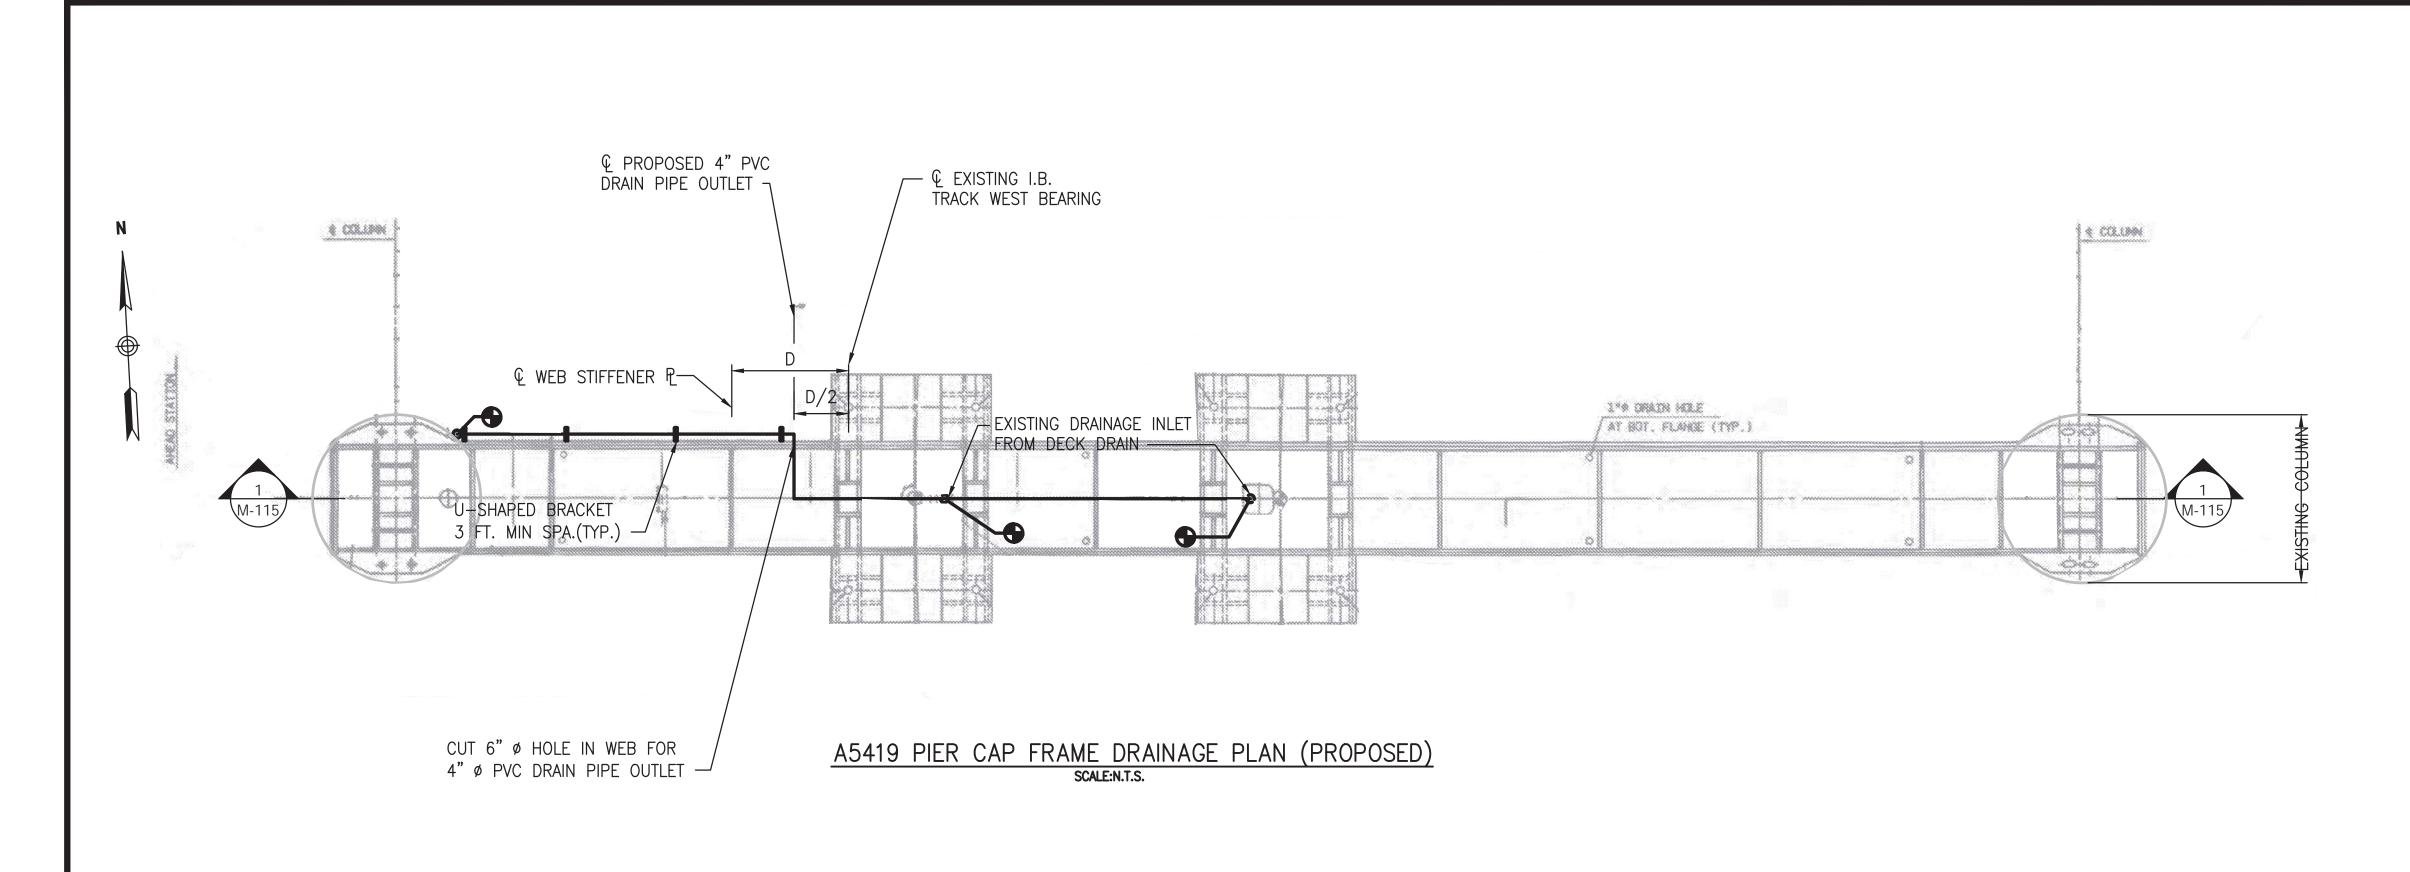

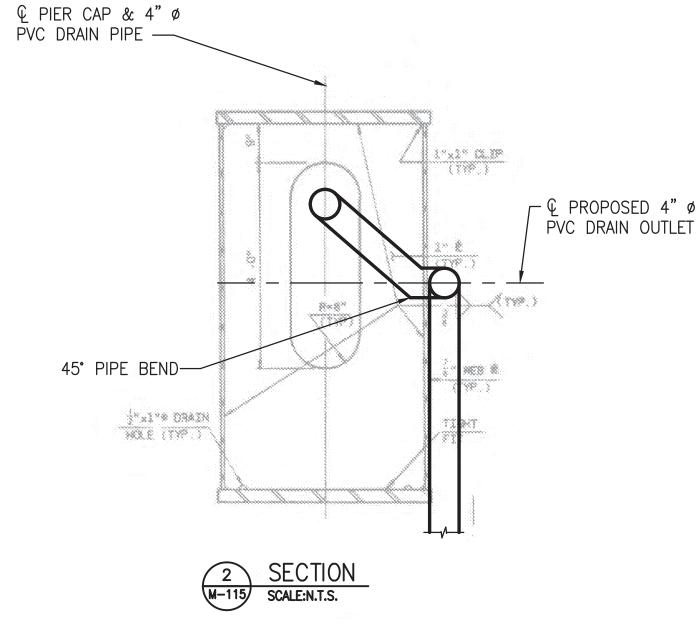

### NOTES:

- 1. REMOVE OR REUSE ALL EXISTING PIPE SUPPORT BRACKETS/HANGERS AND U-BOLTS INSIDE THE PIER CAP SUPPORTING THE EXISTING PVC DRAIN PIPE SYSTEM.
- 2. PLUG AND SEAL EXISTING DRAIN PIPE IN CENTER OF CONCRETE COLUMN A MIN. OF 1 FT WITH GROUT. SEE SPECIFICATION SECTION 036213 FOR NON-METALLIC, NON-SHRINK GROUT.
- 3. TO EXIT THE PROPOSED DRAIN PIPE OUT OF STEEL PIER CAP, CUT ONE (1) 6" DIA. HOLE IN THE WEB OF THE STEEL PIER CAP BOX AS SHOWN IN THE PLANS. THE CENTERLINE OF NEW HOLE IN THE WEB SHALL BE ALIGNED AS SHOWN IN THE PLANS.
- 4. INSTALL PROPOSED 4" DIA. PVC DRAIN PIPE INSIDE STEEL PIER CAP. PROPOSED DRAIN PIPE SHALL EXIT PIER CAP THROUGH NEWLY MADE HOLE IN THE WEB. AFTER EXITING THE PIER CAP, THE PROPOSED DRAIN PIPE SHALL CONTINUE ALONG THE FACE OF THE STEEL PIER CAP. AT THE CONCRETE COLUMN TURN PIPE DOWN ALONG THE FACE OF CONCRETE PIER COLUMN AND CONNECT TO THE EXISTING BELOW GRADE DRAINAGE SYSTEM.
- 5. MINIMUM SLOPE OF PIPES SHALL BE 1/4" PER FOOT.
- 6. ALL UNDERGROUND PIPING SHALL MATCH EXISTING PIPE SYSTEMS. FOR EXISTING DRAINAGE DETAILS SEE AS—BUILT PLANS M220—77 THRU M220—82.
- 7. ALL PVC PIPE SHALL BE SCHEDULE 80.

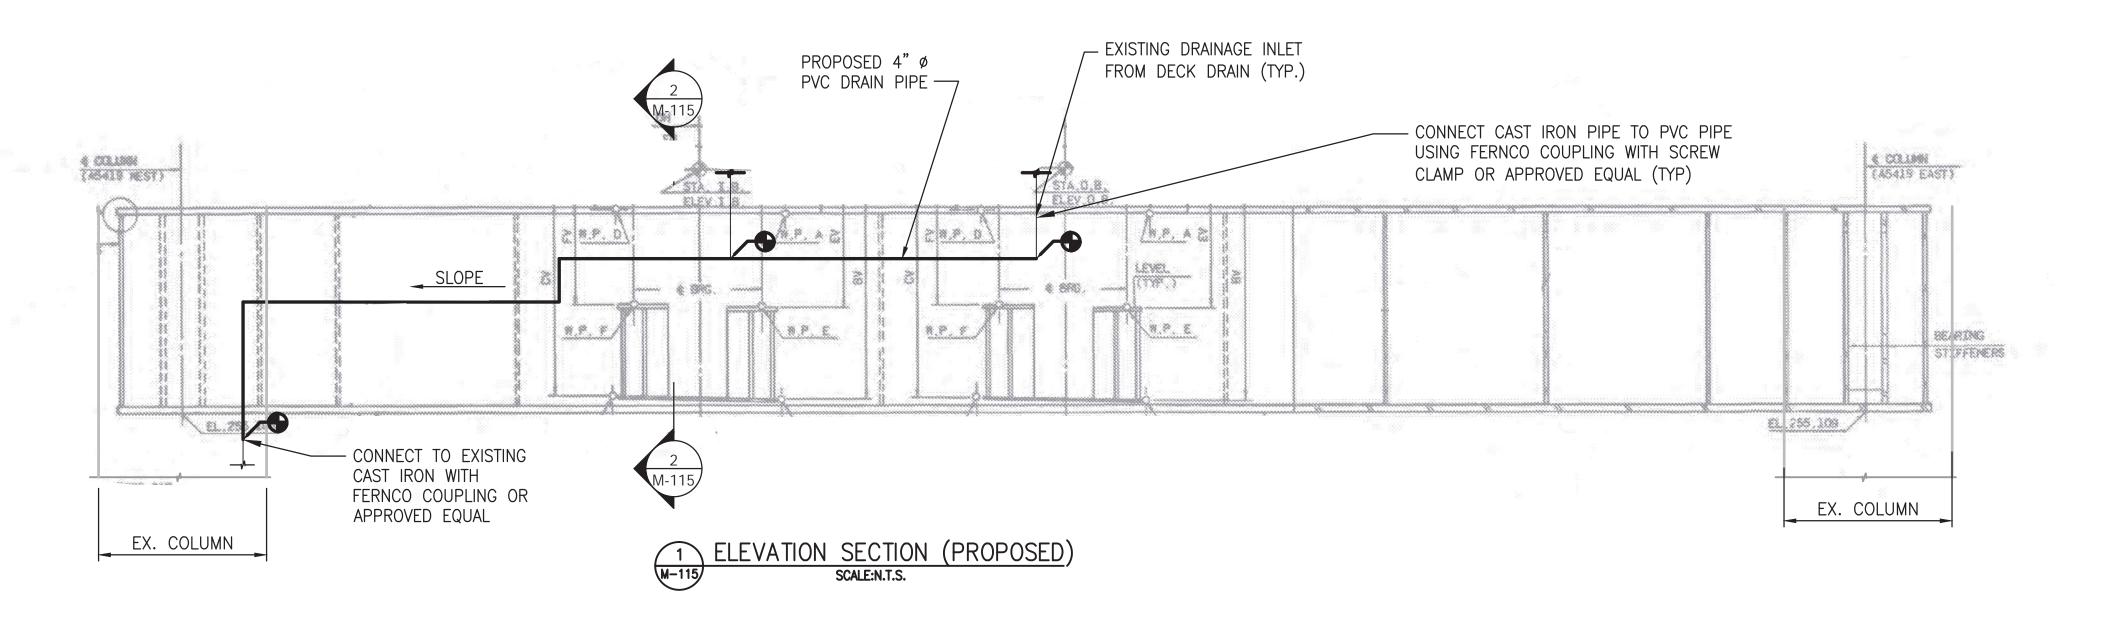

PROFESSIONAL CERTIFICATION. I HEREBY CERTIFY THAT THESE DOCUMENTS WERE PREPARED OR APPROVED BY ME, AND THAT I AM A DULY LICENSED PROFESSIONAL ENGINEER UNDER THE LAWS OF THE STATE OF MARYLAND, LICENSE NO. 23210, EXPIRATION DATE 06-30-2016.

APPROVED —



#### WASHINGTON METROPOLITAN AREA TRANSIT AUTHORITY

DEPARTMENT OF TRANSIT INFRASTRUCTURE AND ENGINEERING SERVICES OFFICE OF INFRASTRUCTURE RENEWAL PROGRAM



FINAL


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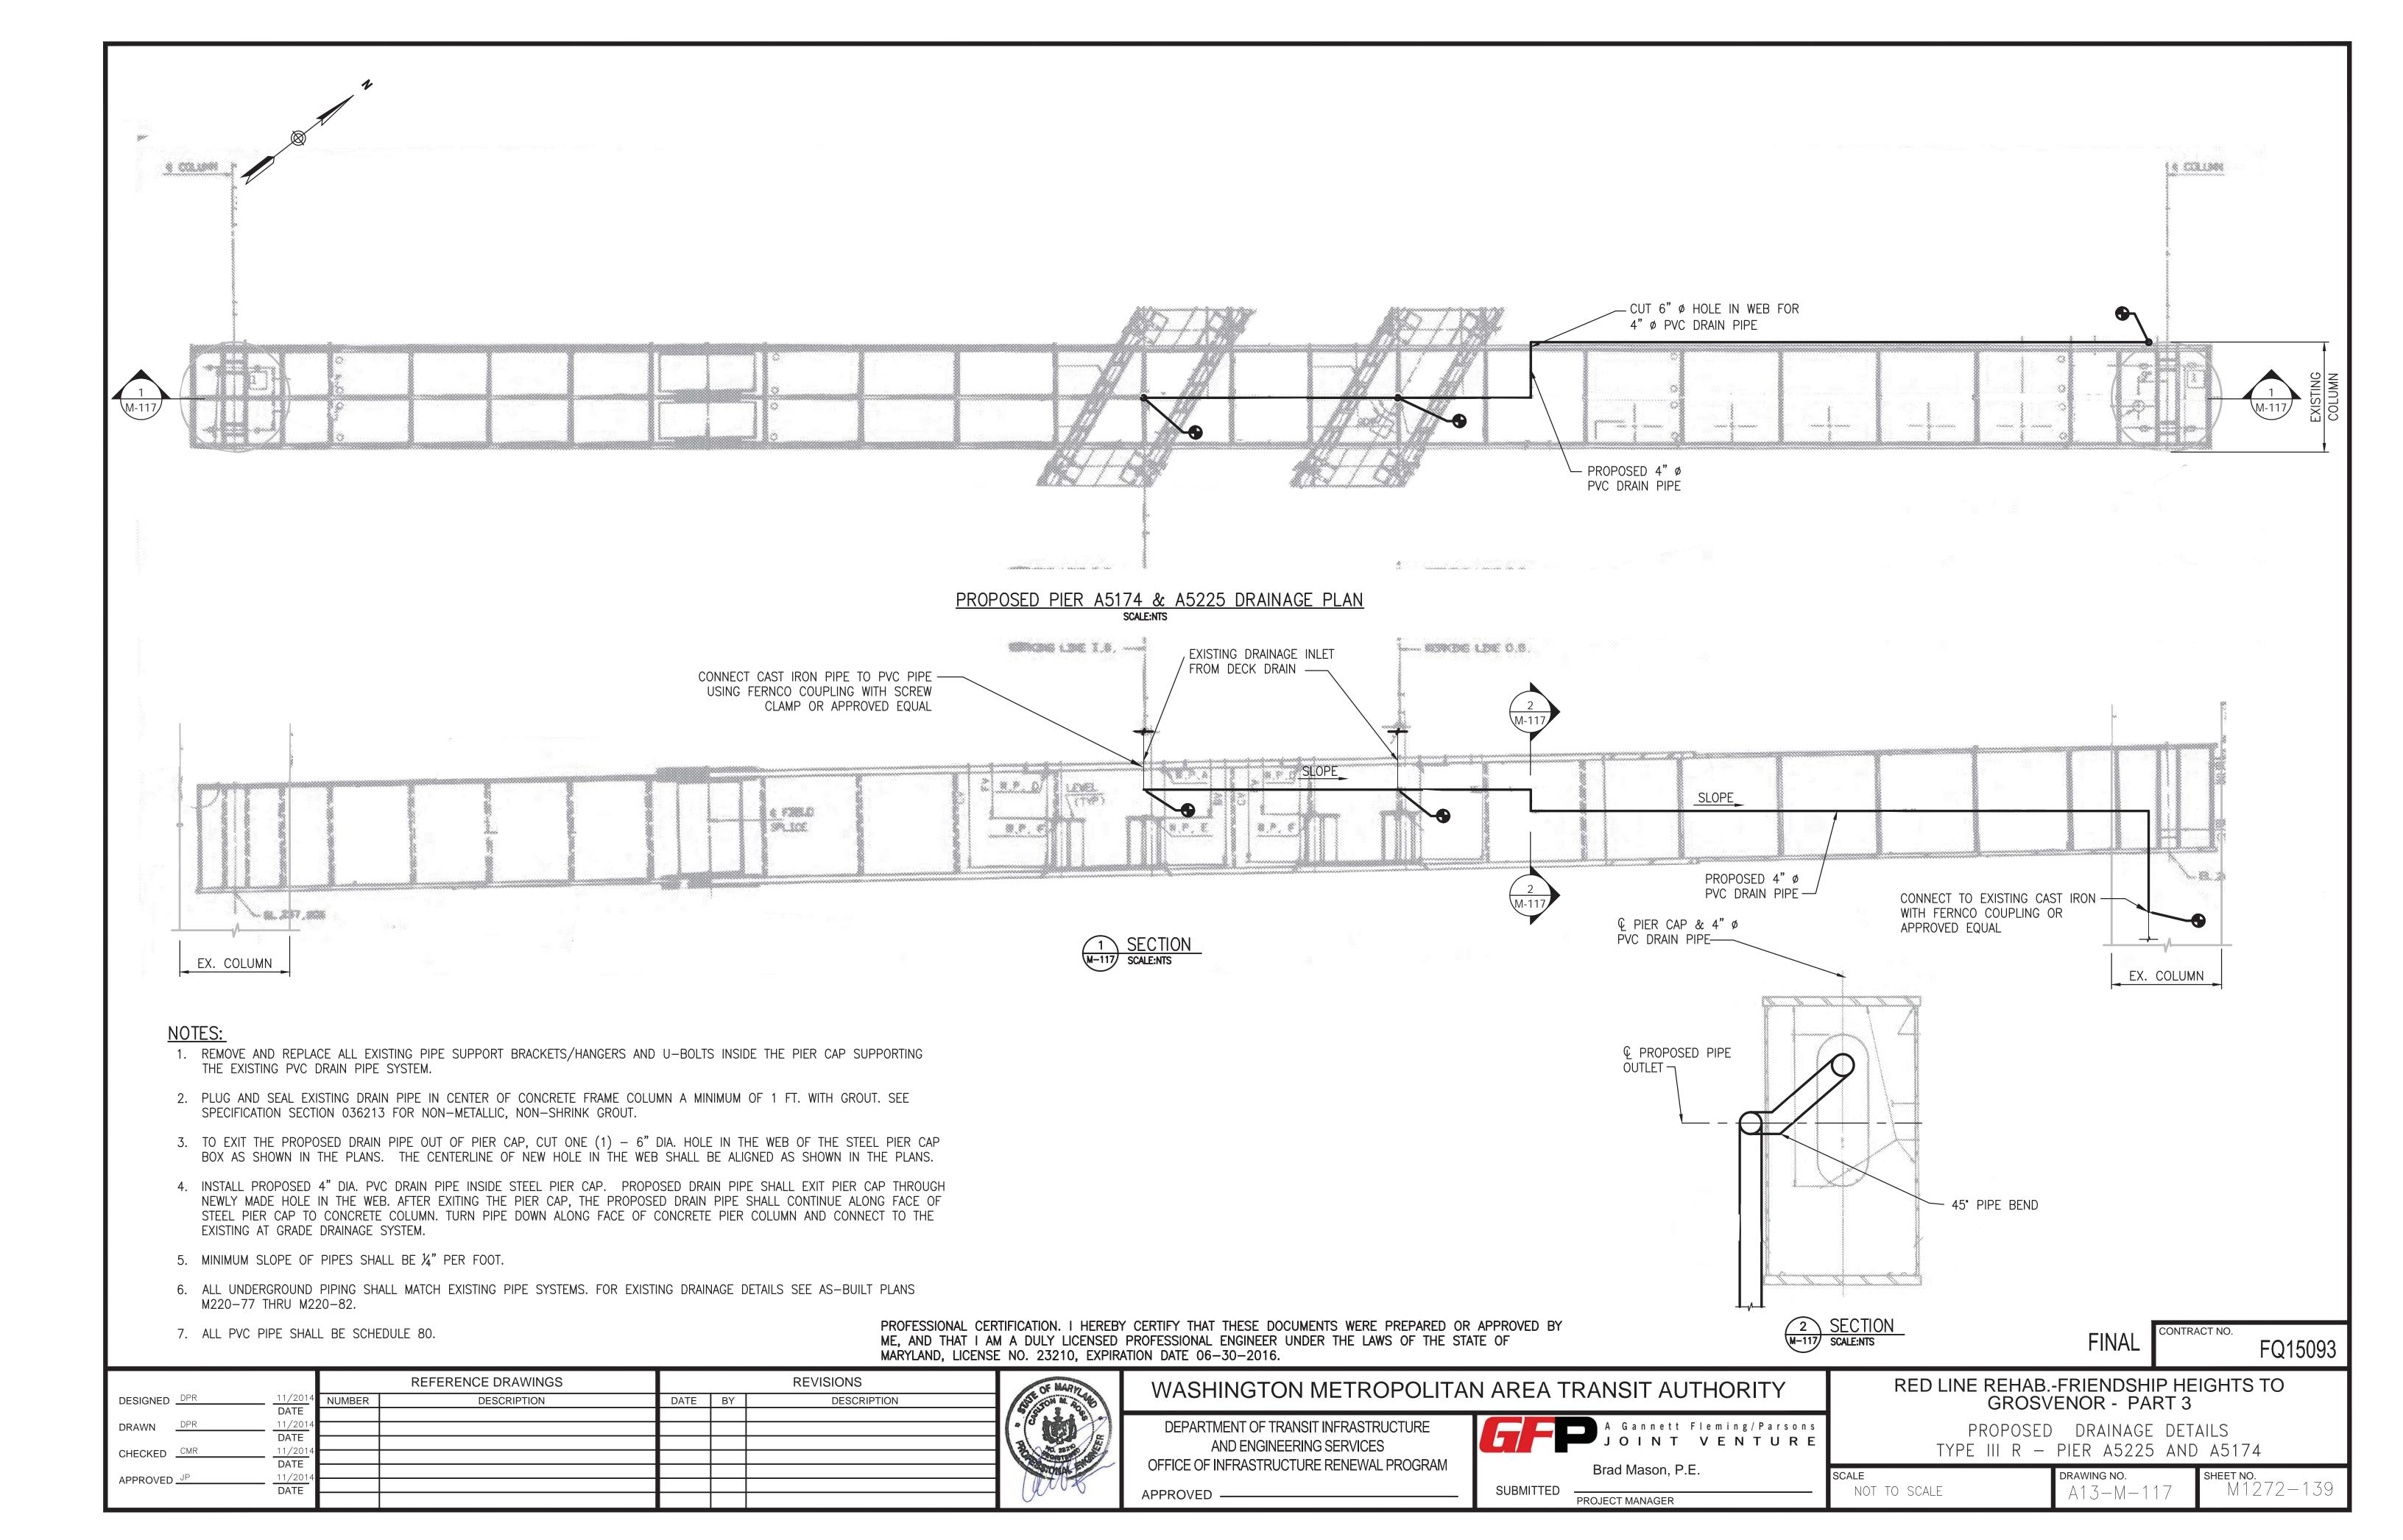
GROSVENOR - PART 3
PROPOSED DRAINAGE DETAILS


PROPOSED DRAINAGE DETAIL TYPE II R — PIER A5419

RED LINE REHAB.-FRIENDSHIP HEIGHTS TO

SCALE DRAWING NO. SHEET NO. M1272-137



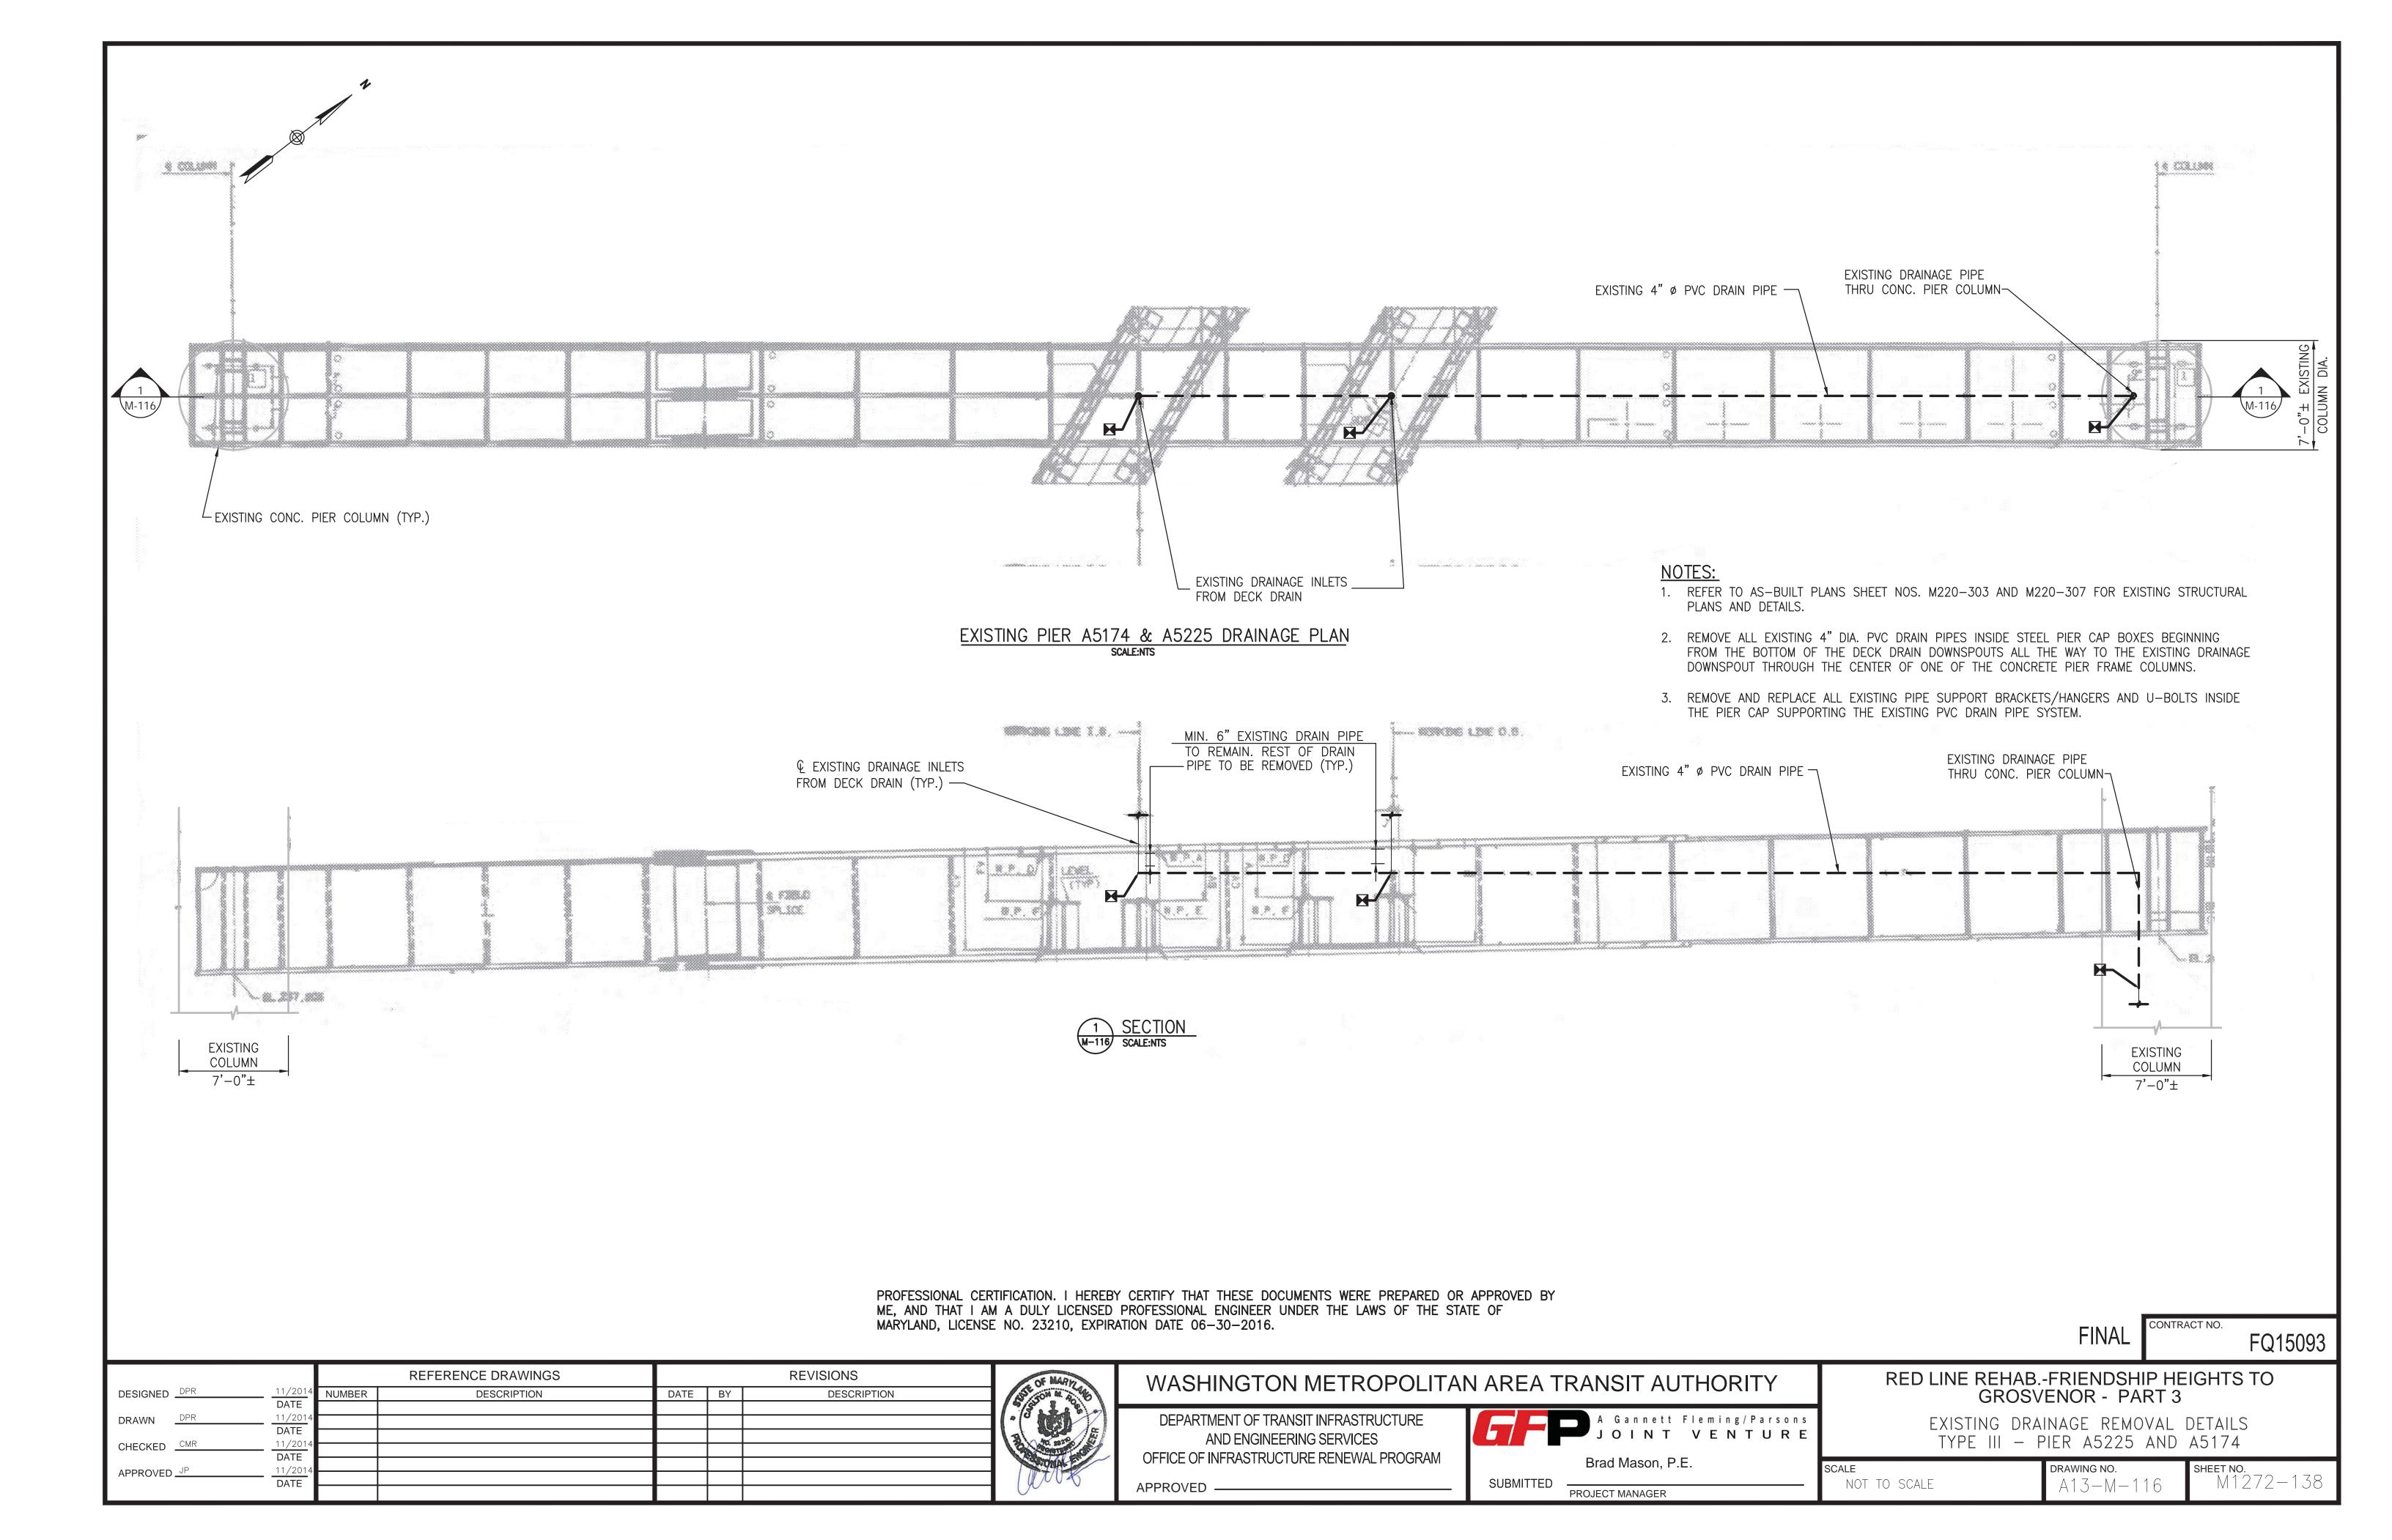

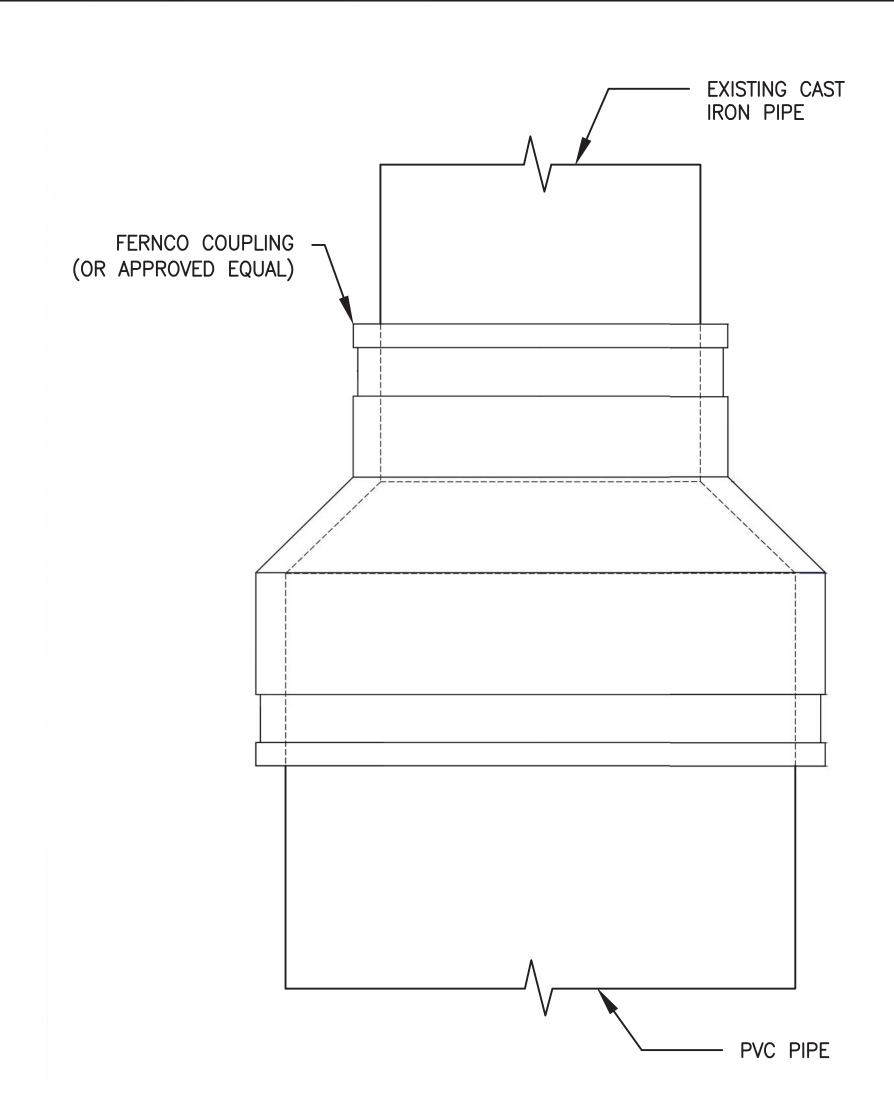

GRADE

LINKSEAL (OR APPROVED EQUAL)


PVC PIPE

WALL

EXISTING CAST IRON PIPE

HORIZONTAL CONNECTION OF PVC PIPE TO EXISTING DRAINAGE SYSTEM — FOR LINKSEAL OR APPROVED EQUAL SCALE:NTS

VERTICAL CONNECTION OF PVC PIPE TO EXISTING DRAINAGE SYSTEM — FOR FERNCO COUPLING OR APPROVED EQUAL SCALE:NTS

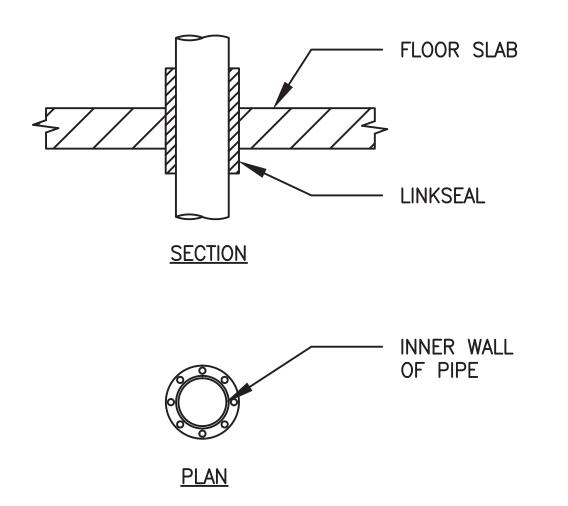

VERTICAL CONNECTION OF PVC PIPE TO EXISTING DRAINAGE SYSTEM — FOR LINKSEAL OR APPROVED EQUAL SCALE:NTS

PROFESSIONAL CERTIFICATION. I HEREBY CERTIFY THAT THESE DOCUMENTS WERE PREPARED OR APPROVED BY ME, AND THAT I AM A DULY LICENSED PROFESSIONAL ENGINEER UNDER THE LAWS OF THE STATE OF MARYLAND, LICENSE NO. 23210, EXPIRATION DATE 06-30-2016.

FINAL

RACT NO.

FQ15093

|              |                        | REFERENCE DRAWINGS |             | REVISIONS |    |             |    |
|--------------|------------------------|--------------------|-------------|-----------|----|-------------|----|
| DESIGNED DPR | 11/2014<br>DATE        | NUMBER             | DESCRIPTION | DATE      | BY | DESCRIPTION |    |
| DRAWN DPR    | 11/2014                | $\vdash$           |             |           |    |             |    |
| CHECKED CMR  | <b>DATE</b><br>11/2014 |                    |             |           |    |             | B  |
| CHECKED CMR  | DATE                   |                    |             |           |    |             | 13 |
| APPROVED JP  | 11/2014<br>DATE        |                    |             |           |    |             |    |
|              | DATE                   |                    |             |           |    |             |    |



# WASHINGTON METROPOLITAN AREA TRANSIT AUTHORITY

DEPARTMENT OF TRANSIT INFRASTRUCTURE AND ENGINEERING SERVICES OFFICE OF INFRASTRUCTURE RENEWAL PROGRAM

| A Gannett Fleming/Parsons JOINT VENTURE |  |  |  |  |  |  |
|---|--|--|--|--|--|--|
| Brad Mason, P.E.                        |  |  |  |  |  |  |
| DDO IECT MANAGED                        |  |  |  |  |  |  |

RED LINE REHAB.-FRIENDSHIP HEIGHTS TO GROSVENOR - PART 3

PROPOSED TYPICAL DRAINAGE DETAILS

SCALE DRAWING NO SHEET NO

NOT TO SCALE A13-M-500 SHEET NO. M1272-140

#### 1 PLATFORM - STAGING PLAN WORK ZONES SCALE: NTS

#### **GENERAL PHASING NOTES**

- THE PHASING OUTLINE INDICATED IN THE DRAWING ABOVE IS FOR REFERENCE ONLY. THE CONTRACTOR IS RESPONSIBLE FOR DEVELOPING A PHASING PLAN FOR REVIEW AND APPROVAL BY THE AR.
- ALL WORK IN EACH PHASE MUST BE COMPLETE BEFORE THE CONTRACTOR IS PERMITTED TO PROCEED TO THE NEXT PHASE UNLESS AGREED TO BY WMATA.
- WORK PHASES WILL BE SEPARATED FROM REVENUE SPACES BY WOOD FRAME PARTITIONS WITH PLYWOOD FACES. IT IS THE RESPONSIBILITY OF THE CONTRACTOR TO DESIGN, INSTALL, AND MAINTAIN THIS WOODEN PARTITION WALL SYSTEM. PLYWOOD SURFACES THAT MAY BE IN CONTACT WITH THE PUBLIC SHOULD BE SMOOTH AND FREE OF SHARP EDGES.
- THE STATION WILL REMAIN IN OPERATION THROUGHOUT THE CONSTRUCTION PERIOD. SAFETY OF THE PUBLIC AND EMPLOYEES OF WMATA AND THE CONTRACTOR WILL BE OF THE GREATEST IMPORTANCE DURING THE CONSTRUCTION PERIOD.
- ALL SYSTEMS INCLUDING BUT NOT LIMITED TO LIGHTING, POWER, COMMUNICATIONS, TRAIN CONTROLS, AND SECURITY SHALL REMAIN OPERATIONAL DURING REVENUE SERVICE HOURS.
- ALL PHASING IS EXTREMELY TIME SENSITIVE. THE CONTRACTOR WILL VERIFY THAT HE HAS COORDINATED WITH ALL SUBS AND HAS ALL MATERIALS ON SITE TO COMPLETE THE WORK. DETAILED CRITICAL PATH METHOD (CPM) SCHEDULES ARE REQUIRED, AS WELL AS COORDINATION DRAWINGS. IF ALL OF THESE REQUIREMENTS HAVE NOT BEEN MET, PHASE WORKS WILL NOT BE PERMITTED TO PROCEED.
- CRANE OPERATION OVER THE TRACKS REQUIRES ADVANCE CLEARANCE WITH WMATA OBTAINED THROUGH THE ENGINEER.
- REMOVE DEBRIS FROM DEMOLITION DAILY KEEP TRACK AREA CLEAR OF DEBRIS AT ALL TIMES. THE CONTRACTOR SHALL TAKE NECESSARY STEPS TO PREVENT THE REMOVED MATERIAL FROM ENTERING THE EXISTING DRAINAGE FACILITIES. THE CONTRACTOR SHALL REMOVE THE DEBRIS RESULTING FROM DEMOLITION WORK TO A LOCATION OUTSIDE THE AUTHORITY'S RIGHT-OF-WAY PRIOR TO RESUMING FULL RAIL OPERATION OR TO PRE-APPROVED STAGING AREAS. ALL REMOVED MATERIALS AND DEBRIS TO BE DISPOSED OF PROPERLY AT NO ADDITIONAL COST TO THE OWNER

#### STAGING NOTES

- THE CONTRACTOR SHALL SUBMIT THE CONSTRUCTION SEQUENCE TO THE AUTHORITY'S REPRESENTATIVE (A.R.) FOR REVIEW PRIOR TO COMMENCING ANY DEMOLITION OR CONSTRUCTION ACTIVITIES. SUBMITTAL SHALL INCLUDE, BUT IS NOT LIMITED TO THE SEQUENCE OF SLAB REMOVAL AND INSTALLATION INCLUDING DETAILED DESIGN OF TEMPORARY SHORING.
- TEMPORARY BARRICADES FOR THE PROTECTION OF PASSENGERS SHALL BE PROVIDED AT ALL TIMES WHEN THE STATION IS OPEN TO PUBLIC.
- CONSTRUCT TEMPORARY PARTITIONS SEPARATING PHASES AT A MIN OF 2x4s @ 24" O.C. AND 5%" PLYWOOD. ALL LUMBER IS TO BE FIRE-RATED.
- EXTEND ALL PARTITIONS TO UNDERSIDE OF CEILING ON PLATFORM LEVEL. BRACE PARTITIONS TO FLOORS WITH ANGLED 2x4s—ANCHOR TO FLOOR SECURELY.
- CONSTRUCT PARTITIONS 8'-0" HIGH ON PLATFORM LEVEL, ANCHOR TO FLOOR AS INDICATED IN NOTE 2. IT IS THE RESPONSIBILITY OF THE CONTRACTOR TO DESIGN INSTALL AND MAINTAIN THIS WOODEN PARTITION WALL SYSTEM. PLYWOOD SURFACES THAT MAY BE IN CONTACT WITH THE PUBLIC SHOULD BE SMOOTH AND FREE OF SHARP EDGES.
- LOCATE ACCESS DOORS WHERE NEEDED FOR CONSTRUCTION ACTIVITIES. CONTRACTOR TO DETERMINE LOCATIONS. A.R. TO APPROVE.
- THE CONTRACTOR MAY EXTEND THE LENGTH OF THE WORK ZONE WITH WMATA'S APPROVAL, BUT MUST MAINTAIN MIN. 7'-0" FROM EDGE OF PLATFORM.
- THE CONTRACTOR SHALL PROVIDE TEMPORARY DECKING IF PAVER WORK IS NOT COMPLETED IN ORDER TO MAINTAIN PEDESTRIAN TRAFFIC AS DIRECTED DURING REVENUE SERVICE.

NUMBER

7/16/14

DATE

7/22/14 DATE

7/28/14

DESIGNED PROJECT TEAM

DRAWN CLR

APPROVED JP

CHECKED RES, DO

REFERENCE DRAWINGS

DESCRIPTION

#### **STAGING NOTES (Cont.)**

- 9. PROVIDE TEMPORARY WARNING SIGNAGE IN ACCORDANCE WITH WMATA REQUIREMENTS.
- 10. PROVIDE TEMPORARY LIGHTING IN WORK ZONES INCLUDING STORAGE AREAS IN ACCORDANCE WITH WMATA DESIGN CRITERIA, VERSION 9. INSTALL TEMPORARY EDGE LIGHTING DURING REPLACEMENT OF THE CANTILEVER SLAB.
- 11. CONSTRUCTION WORK AND STORAGE AREAS MUST BE APPROVED BY WMATA.
- 12. CONTRACTOR MAY USE AN AREA OF UP TO 15' BY 75' AS A STAGING AREA ON THE PLATFORM THAT IS SECURED IN AN EIGHT-FOOT HIGH ENCLOSURE. LOCATION AND ENCLOSURE STRUCTURE SUBJECT TO REVIEW AND APPROVAL BY THE AR.

#### SEQUENCE OF CONSTRUCTION

ZONES 1A, 1B, 2A, 2B

- . SET-UP STAGING AREA AND CRANE, INCLUDING UTILITY PROTECTION, GRADING, AND
- RELOCATE UNDER PLATFORM UTILITIES AS REQUIRED.
- 3. DEMOLISH EXISTING GRANITE EDGES AND GLASS LENSES. DEMOLISH TILE, SETTING BED, AND WATERPROOFING DOWN TO STRUCTURAL SLAB. STORE GRANITE FOR REUSE AT
- LOCATION AS DIRECTED BY AR 4. SAWCUT EDGE OF CONCRETE PLATFORM IN ACCORDANCE WITH STRUCTURAL DRAWINGS AND SPECIFICATIONS.
- 5. INSTALL TEMPORARY PROTECTION AS REQUIRED.

REVISIONS

DESCRIPTION

DATE BY

6. INSTALL TOPPING SLAB, WATERPROOFING, GRANITE, AND PAVERS.

#### ZONES 3A, 3B, 4A, 4B

- SAME AS ITEM 1 ABOVE
- DEMOLISH PAVERS, SETTING BED, AND WATERPROOFING DOWN TO STRUCTURAL SLAB. 3. INSTALL WATERPROOF TOPPING SLAB, MEMBRANE, AND PAVERS. SET ELEVATIONS FOR TOP OF PAVERS IN ACCORDANCE WITH INFORMATION PROVIDED ON PLATFORM PLANS.

#### **GENERAL NOTES:**

- 1. ALL DIMENSIONS ARE NOMINAL UNLESS OTHERWISE NOTED. VERIFY ALL DIMENSIONS IN THE FIELD.
- 2. VERIFY AND PROPERLY DOCUMENT ALL EXISTING FIELD CONDITIONS.
- 3. ALL WORK IS DESIGNED AND SHALL BE CONSTRUCTED IN ACCORDANCE WITH WMATA DESIGN CRITERIA, VERSION 9.
- 4. DO NOT SCALE DRAWINGS FOR PURPOSES OF CONSTRUCTION.
- 5. ANY DEVIATION FROM, OR IN FIELD ALTERATION TO THESE DRAWINGS, AND SPECIFICATIONS IS STRICTLY PROHIBITED WITHOUT PRIOR APPROVAL OF AUTHORITY'S REPRESENTATIVE (A.R.). ANY SUCH ALTERATIONS SHALL BE CORRECTED AT ONCE, WITH NO EXPENSE TO THE OWNER.
- 6. THE CONTRACTOR SHALL BE RESPONSIBLE FOR COORDINATING THE WORK OF ALL TRADES REGARDLESS OF DISCREPANCIES IN THE CONTRACT DOCUMENTS. NO ADDITIONAL COSTS WILL BE PAID BY THE OWNER TO RECTIFY WORK TO BE RELOCATED DUE TO LACK OF JOBSITE COORDINATION.
- 7. DEMOLITION, CUTTING, AND PATCHING OF ANY MATERIALS OR FIXTURES REQUIRED TO CONSTRUCT THE PROJECT IS HEREIN MADE A PART OF THESE CONTRACT DOCUMENTS.
- 8. THE CONTRACTOR SHALL SECURE AND PAY FOR ALL PERMITS.
- 9. ALL WORK INDICATED OR SHOWN GRAPHICALLY AS "EXISTING TO REMAIN" WILL BE THE CONTRACTOR'S RESPONSIBILITY TO PROTECT AND WORK AROUND WITHOUT DISTURBING. IF DAMAGED, THE CONTRACTOR WILL REPLACE OR REPAIR AT THE AUTHORITY'S DIRECTION AT NO ADDITIONAL COST TO THE OWNER.

"PROFESSIONAL CERTIFICATION. I HEREBY CERTIFY THAT THESE DOCUMENTS WERE PREPARED OR APPROVED BY ME, AND THAT I AM A DULY LICENSED PROFESSIONAL ARCHITECT UNDER THE LAWS OF THE STATE OF MARYLAND, LICENSE NO. 5231-A. EXPIRATION DATE: 05-18-2015."

AL REGISTRA 5231-A

APPROVED

WASHINGTON METROPOLITAN AREA TRANSIT AUTHORITY

DEPARTMENT OF TRANSIT INFRASTRUCTURE AND ENGINEERING SERVICES OFFICE OF INFRASTRUCTURE RENEWAL PROGRAM A Gannett Fleming/Parsons JOINT VENTURE **GROSVENOR - PART 4** 

STAGING PLAN

M1272 - 141A11-G-001 AS SHOWN


RED LINE REHAB.-FRIENDSHIP HEIGHTS TO

FINAL

FQ15093

Brad Mason, P.E.

PROJECT MANAGER

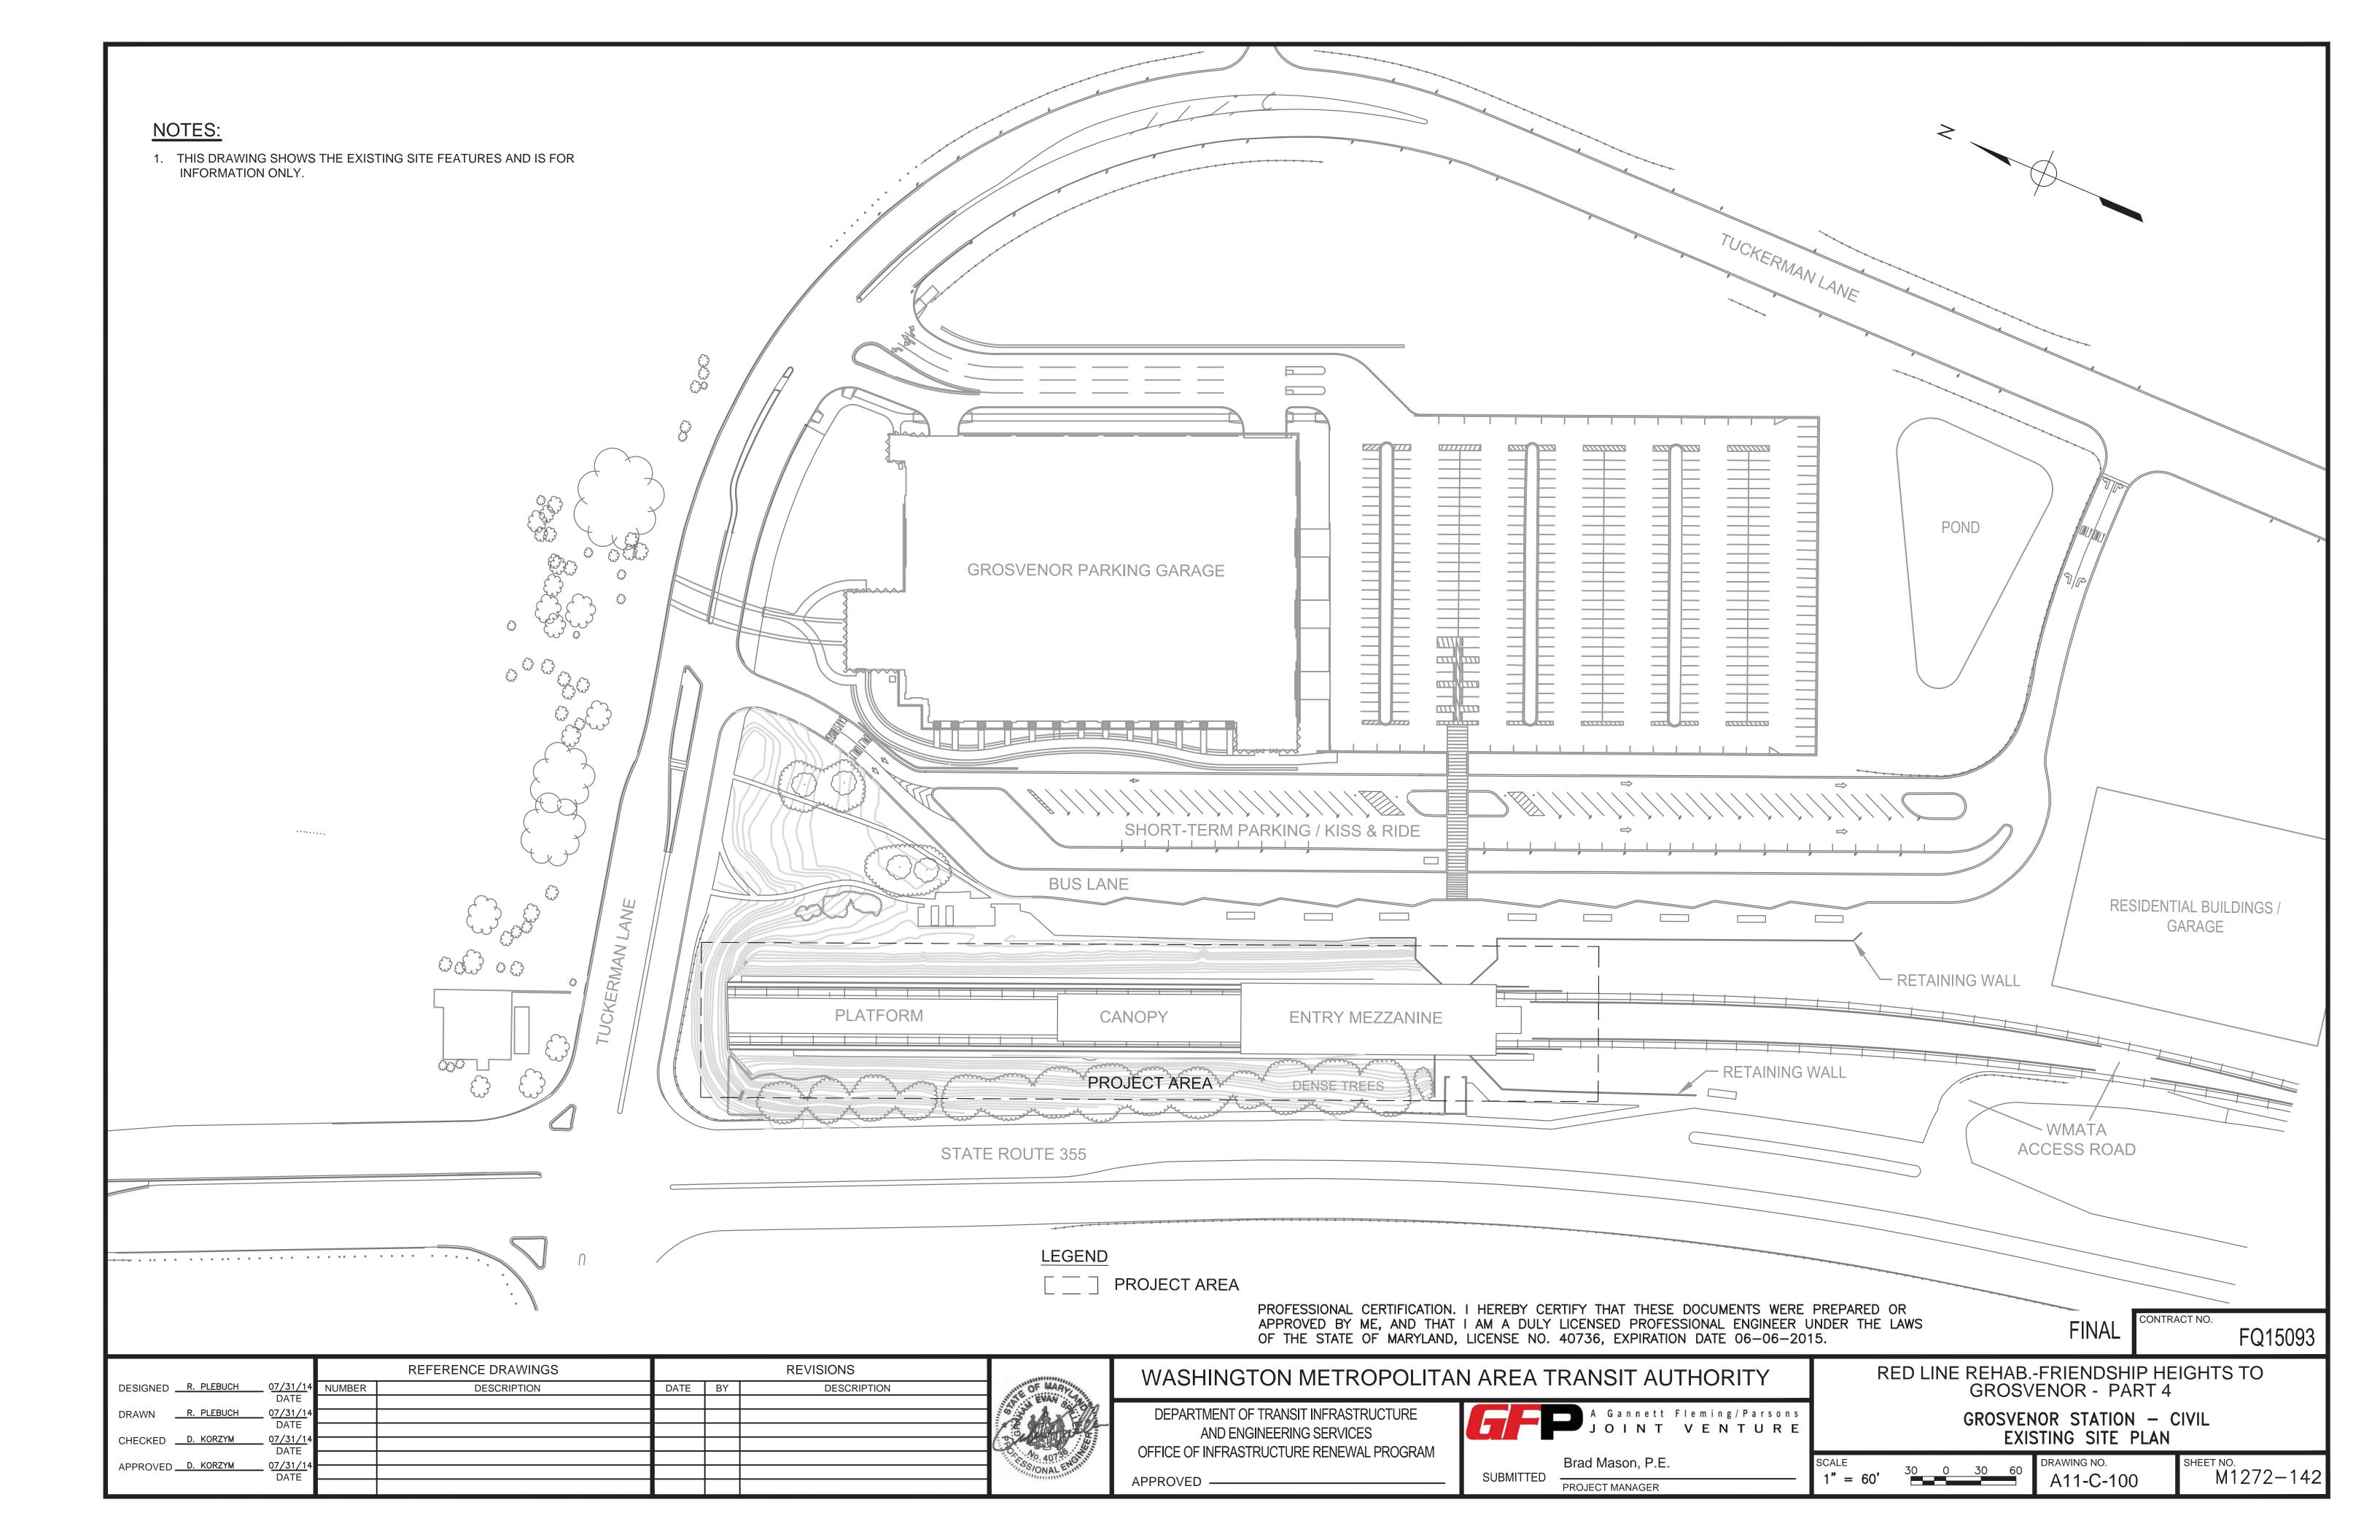

#### **LEGEND** ARCHITECTURAL ABBREVIATIONS **GENERAL NOTES:** ABOVE FINISH FLOOR NTS NOT TO SCALE 1. ALL DIMENSIONS ARE NOMINAL UNLESS OTHERWISE NOTED. **SYMBOLS BUILDING MATERIALS** OC AGGR AGGREGATE ON CENTER VERIFY ALL DIMENSIONS IN THE FIELD. OFF ALUMINUM OFFICE 2. VERIFY AND PROPERLY DOCUMENT ALL EXISTING FIELD CONDITIONS. A.R. AUTHORITY REPRESENTATIVE P/L PROPERTY LINE CMU ARCH PASS ARCHITECTURAL PASSENGER 3. ALL WORK IS DESIGNED AND SHALL BE CONSTRUCTED IN PEB KEY NOTE ASSY **ASSEMBLY** PRE-ENGINEERED BUILDING CONCRETE ACCORDANCE WITH WMATA DESIGN CRITERIA, VERSION 9. BD BOARD PL PLATE BLDG BUILDING PLYWD PLYWOOD STEEL SPOT ELEVATION OF 4. DO NOT SCALE DRAWINGS FOR PURPOSES OF CONSTRUCTION. BLKG BLOCKING PNL PANEL TOP OF PAVER SPOT ELEVATION BP 5. ANY DEVIATION FROM. OR IN FIELD ALTERATION TO THESE DRAWINGS. PNT PAINT ALUMINUM BASE PLATE )TS281.94**~** - SPOT ELEVATION OF AND SPECIFICATIONS IS STRICTLY PROHIBITED WITHOUT PRIOR CJ PORC PORCELAIN CONTROL JOINT TOPPING SLAB PLYWOOD APPROVAL OF AUTHORITY'S REPRESENTATIVE (A.R.). ANY SUCH CL CENTERLINE PREFAB PREFABRICATED ALTERATIONS SHALL BE CORRECTED AT ONCE, WITH NO EXPENSE TO CMU PROJ PROJECT CONCRETE MASONRY UNIT THE OWNER. CO PTN CLEANOUT PARTITION COL COLUMN RADIUS 6. THE CONTRACTOR SHALL BE RESPONSIBLE FOR COORDINATING THE $\times \times \times$ COLUMN LINE INDICATOR CONCRETE PAVERS RD CONC CONCRETE ROOF DRAIN WORK OF ALL TRADES REGARDLESS OF DISCREPANCIES IN THE REINF CONTRACT DOCUMENTS. NO ADDITIONAL COSTS WILL BE PAID BY THE REINFORCE CONSTR CONSTRUCTION SETTING BED OWNER TO RECTIFY WORK TO BE RELOCATED DUE TO LACK OF REQD REQUIRED CONT CONTINUOUS JOBSITE COORDINATION. REV CONTR REVISION CONTRACTOR TOPPING SLAB REG REGISTER COMM COMMUNICATION 7. DEMOLITION, CUTTING, AND PATCHING OF ANY MATERIALS OR RFG GRANITE ROOFING DEPTH FIXTURES REQUIRED TO CONSTRUCT THE PROJECT IS HEREIN MADE A DEPT DEPARTMENT RMROOM PART OF THESE CONTRACT DOCUMENTS. XX DET SOUTH DETAIL X###/ DETAIL INDICATOR 8. THE CONTRACTOR SHALL SECURE AND PAY FOR ALL PERMITS. DIA SCHED DIAMETER SCHEDULE DIM SEC DIMENSION SECTION 9. ALL WORK INDICATED OR SHOWN GRAPHICALLY AS "EXISTING TO DWG SF DRAWING SQUARE FOOT REMAIN" WILL BE THE CONTRACTOR'S RESPONSIBILITY TO PROTECT VIEW INDICATOR SHT EAST SHEET AND WORK AROUND WITHOUT DISTURBING. IF DAMAGED, THE -(E=ELEVATION) SPEC EACH SPECIFICATION CONTRACTOR WILL REPLACE OR REPAIR AT THE AUTHORITY'S ELEVATION EL/ELEV SQ ELEVATION SQUARE DIRECTION AT NO ADDITIONAL COST TO THE OWNER. ELEVATION—VIEW INDICATOR -INDICATOR SS ELEC ELECTRICAL STAINLESS STEEL **ELEVATION** STL ELEV ELEVATOR STEEL $\sqrt{-X}$ - NO. STOR EQ STORAGE EQUAL EQUIP STRUCT **EQUIPMENT** STRUCTURE/STRUCTURAL WHERE DWG. ETR SYS EXISTING TO REMAIN SYSTEM - ORIGINATED EJ EXPANSION JOINT TEL TELEPHONE ΕX TOP TOP OF PLATFORM EXISTING DETAIL @ EXIST TOTS EXISTING TOP OF TOPPING SLAB EXT DRAWING TITLE EXTERIOR TYP TYPICAL X### / Not To Scale FIN UNO FINISH UNLESS NOTED OTHERWISE FLASHING VIF VERIFY IN FIELD FLEX WEST FLEXIBLE FLG FLANGE WIDE FLR **FLOOR** WITH XX FOOT WITHOUT SECTION INDICATOR GOVT GOVERNMENT WATERPROOFING GR GRADE GROUND HIGH HEXAGON PATTERN PRECAST **HEIGHT** PAVER CUSTOM COLOR TO HEATING, VENTILATING, & AIR CONDITIONING MATCH WMATA APPROVED THAT IS SAMPLE INSUL INSULATION INTR INTERIOR JST JOIST /4//9/ DAMAGED GRANITE EDGE **JOINT** LENGTH LIGHT MAINTENANCE PYLONS MASONRY MAXMAXIMUM MECH MECHANICAL MEZZ MEZZANINE MFR MANUFACTURER EXISTING DOORS MGR MANAGER MANHOLE MINIMUM MINUTES CONTROL JOINT MISCELLANEOUS MET METAL MTL METAL EXPANSION JOINT NORTH NOT APPLICABLE NOT IN CONTRACT "PROFESSIONAL CERTIFICATION. I HEREBY CERTIFY THAT THESE DOCUMENTS WERE PREPARED OR APPROVED FINAL BY ME, AND THAT I AM A DULY LICENSED PROFESSIONAL ARCHITECT UNDER THE LAWS OF THE STATE OF NUMBER FQ15093 MARYLAND, LICENSE NO. 5231-A, EXPIRATION DATE: 05-18-2015." REFERENCE DRAWINGS REVISIONS RED LINE REHAB.-FRIENDSHIP HEIGHTS TO WASHINGTON METROPOLITAN AREA TRANSIT AUTHORITY DESIGNED JRS DATE BY DESCRIPTION NUMBER DESCRIPTION GROSVENOR - PART 4 5231-A A Gannett Fleming/Parsons DRAWN AD/CLR 7/16/1 DEPARTMENT OF TRANSIT INFRASTRUCTURE DATE JOINT VENTURE AND ENGINEERING SERVICES ABBREVIATIONS, LEGENDS, AND SYMBOLS 7/22/14 CHECKED RES DATE OFFICE OF INFRASTRUCTURE RENEWAL PROGRAM

APPROVED

7/28/14

APPROVED JP


Brad Mason, P.E.


PROJECT MANAGER

AS SHOWN

A11-A-001

M1272 - 143

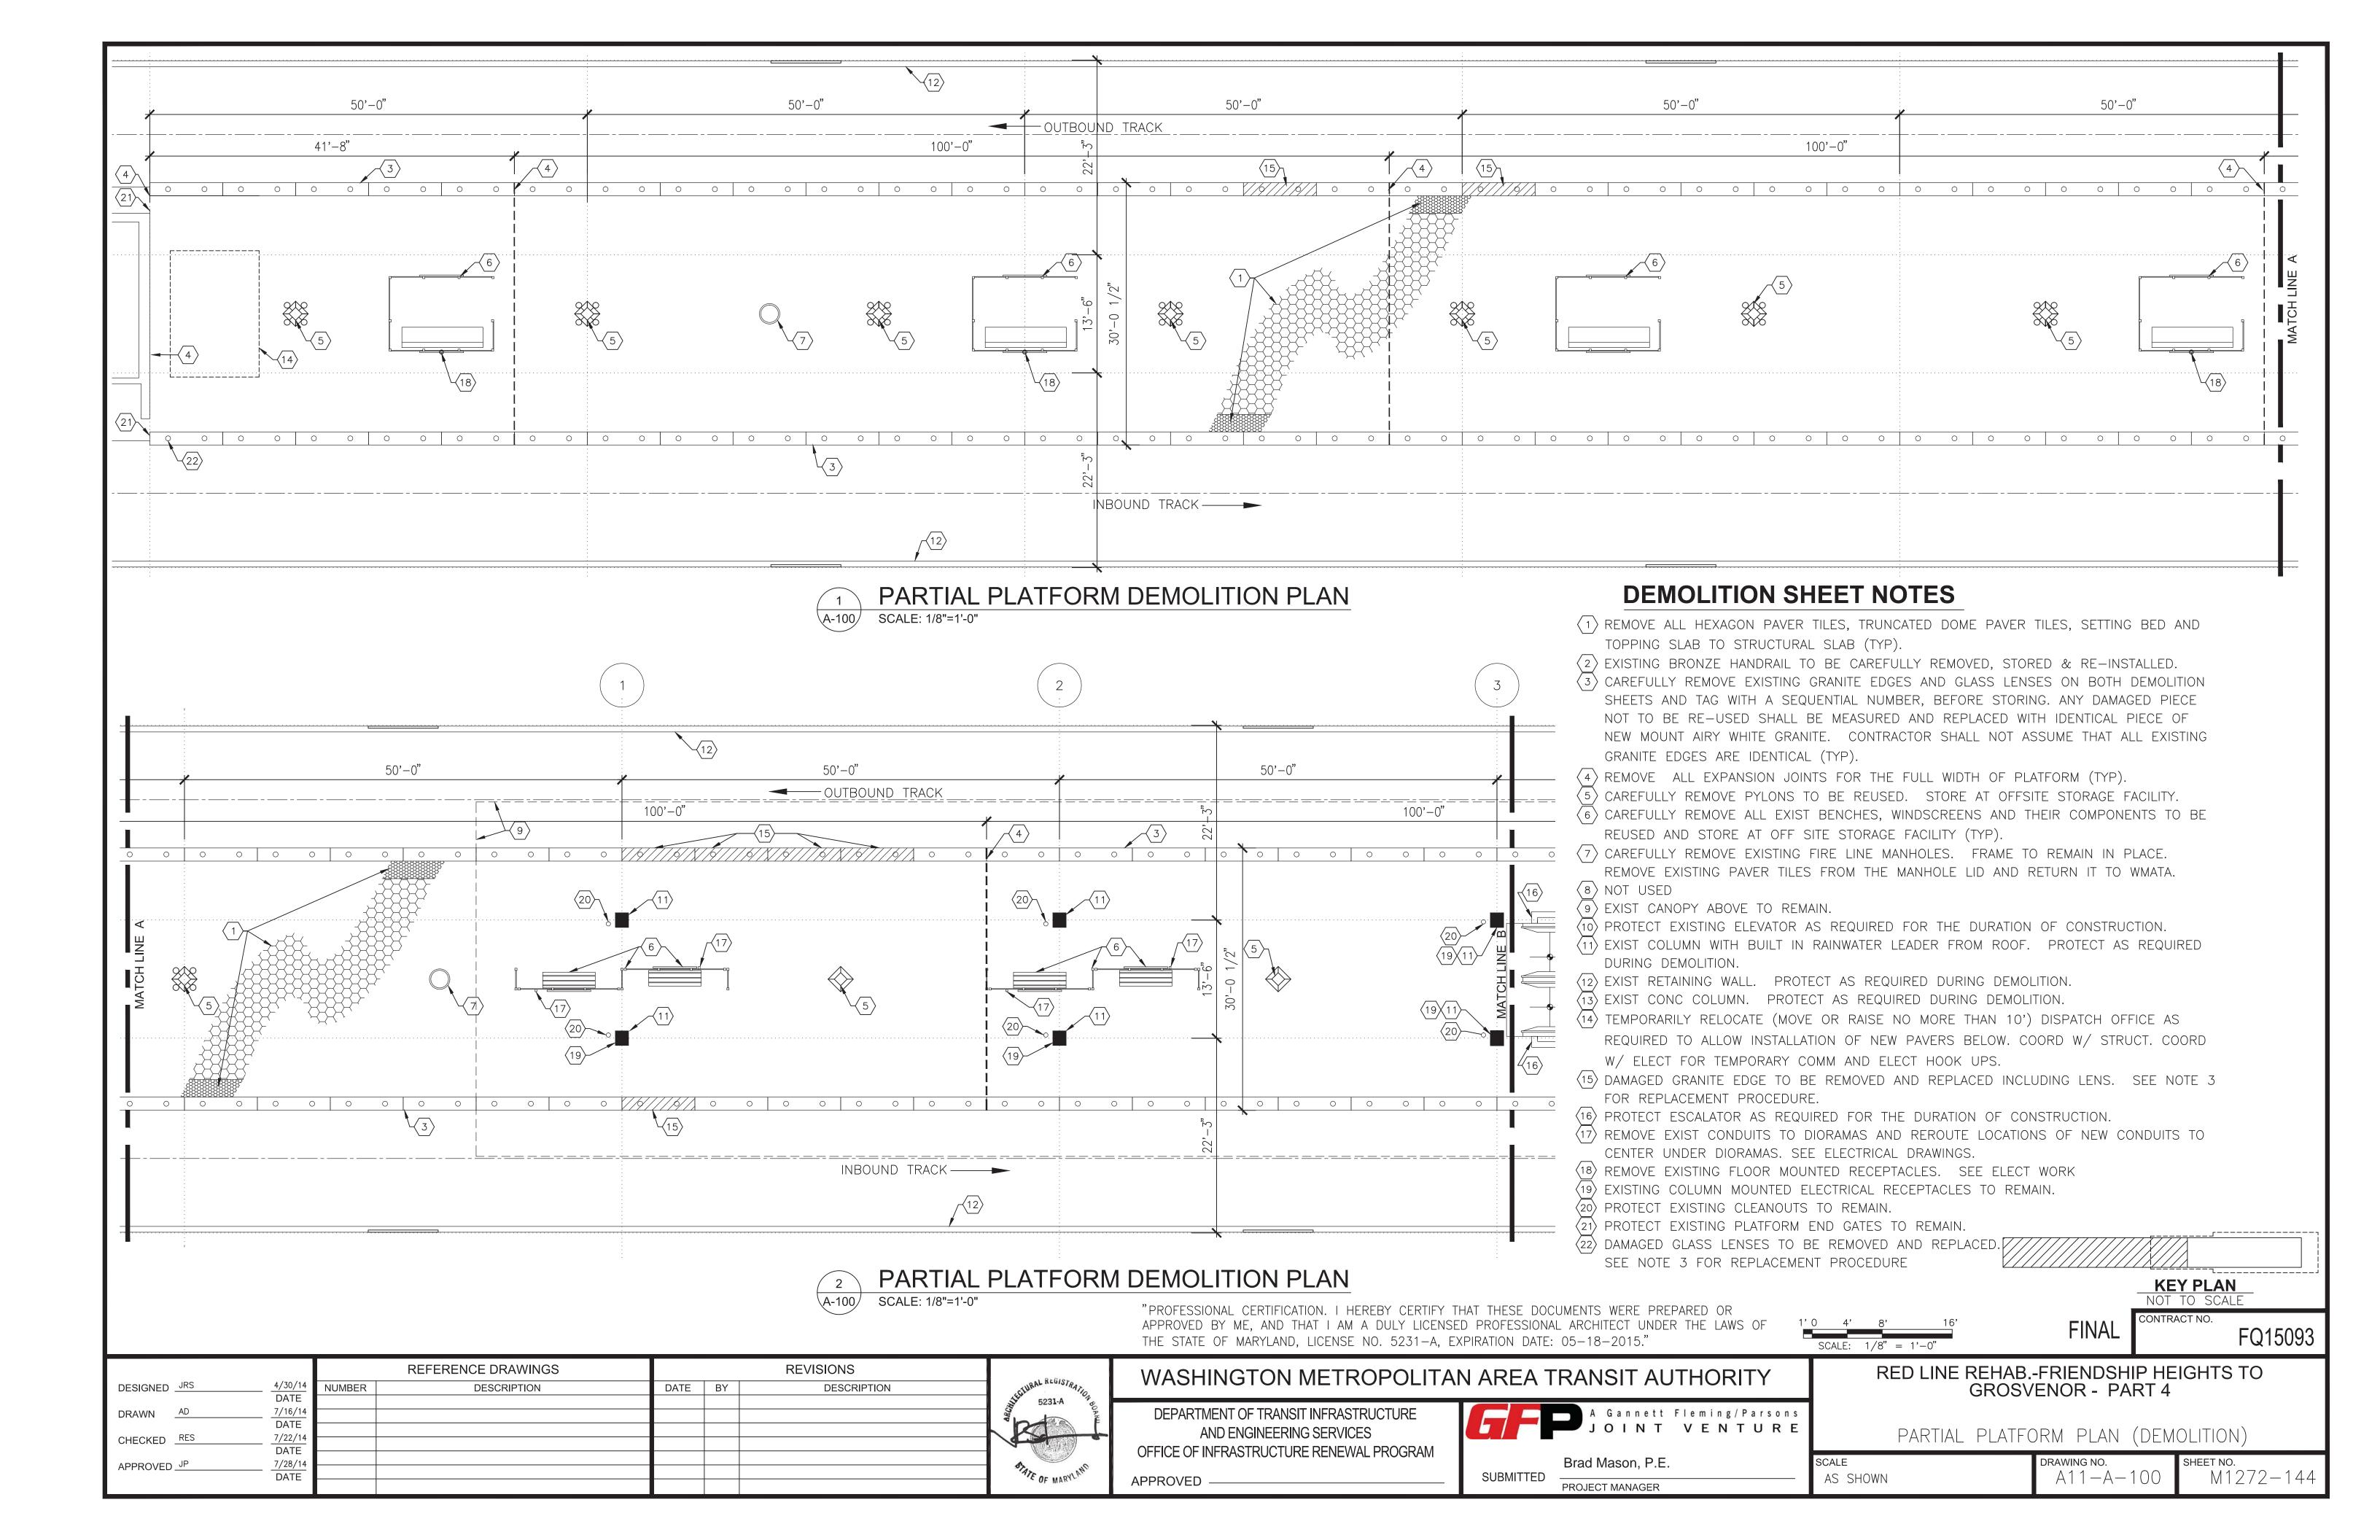

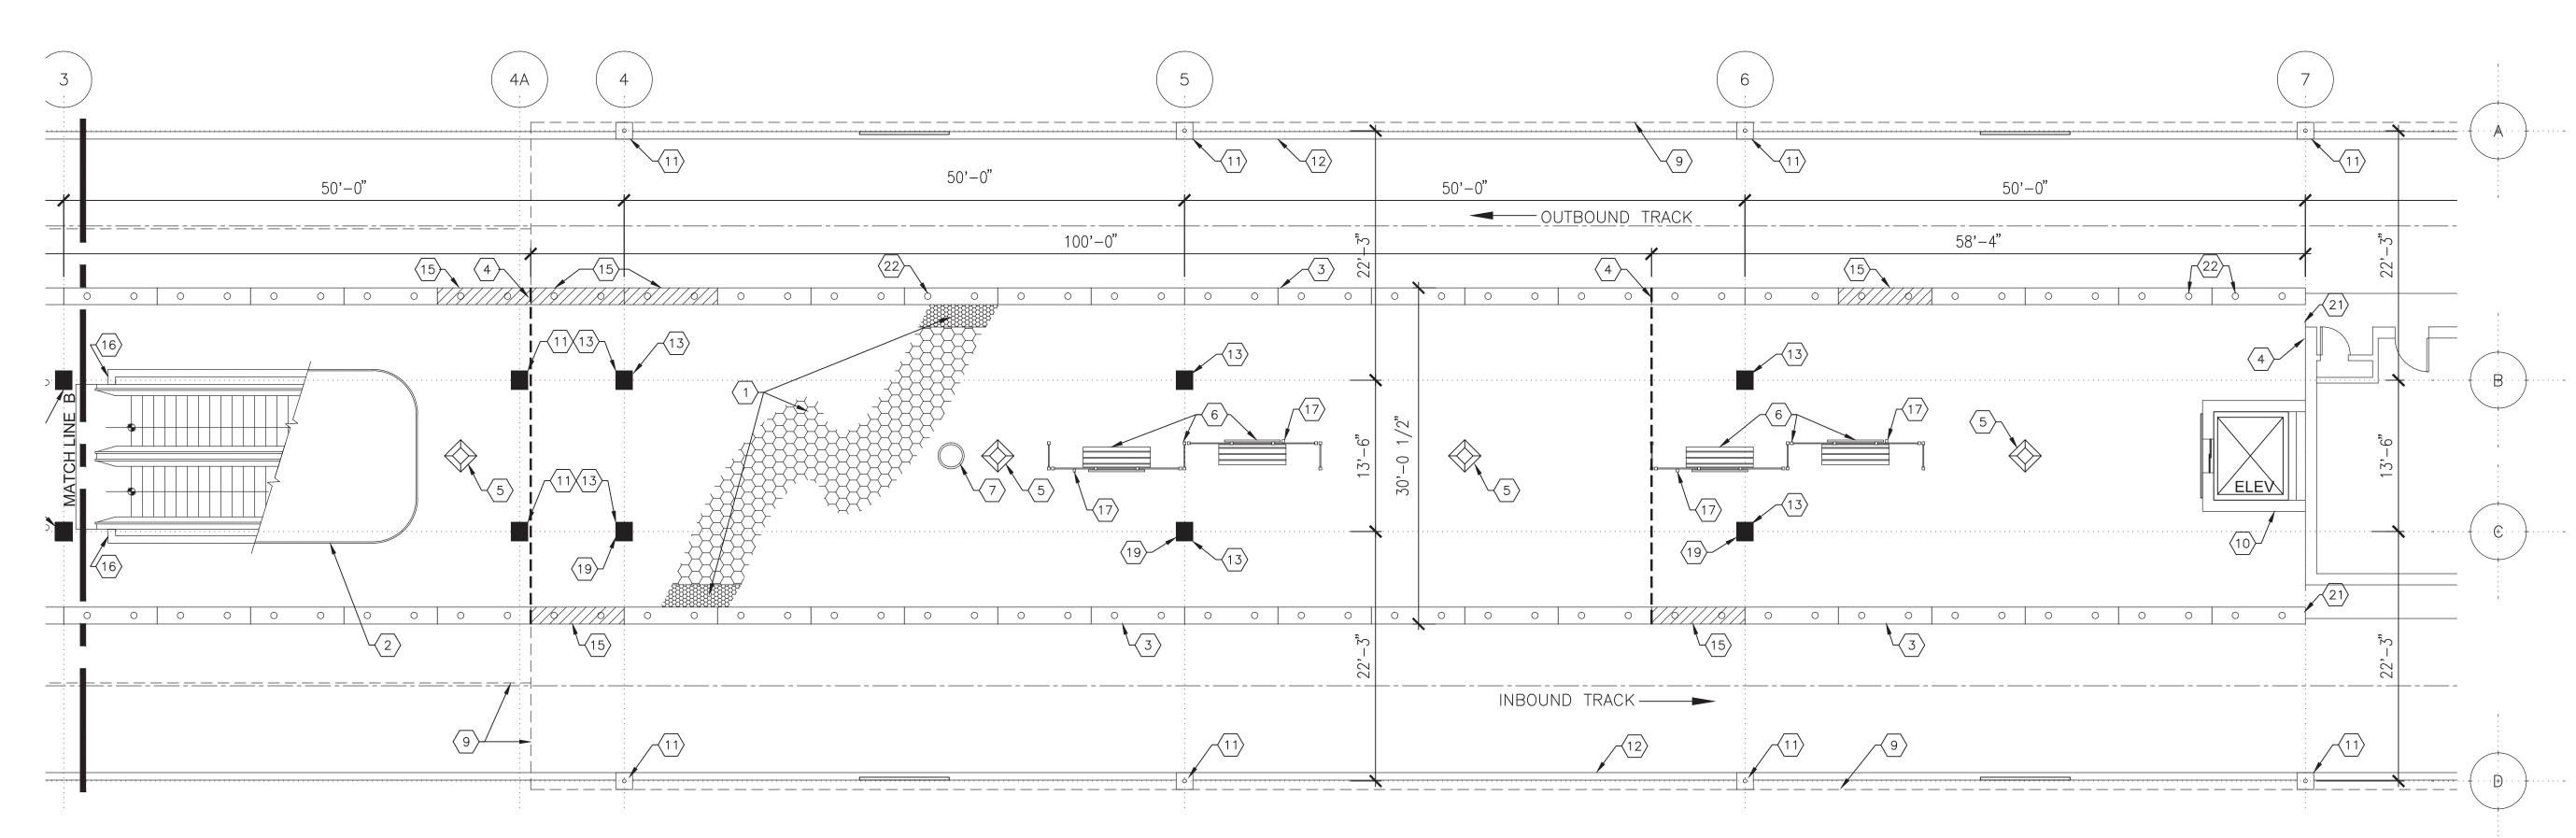

#### **GENERAL DEMOLITION NOTES**

- 1. VERIFY EXISTING FIELD CONDITIONS.
- 2. PRIOR TO DEMOLITION, VERIFY MATERIALS AND EQUIPMENT TO BE SALVAGED. STORE WHERE DIRECTED BY A.R.
- 3. VERIFY AND MARK ALL UNDER SLAB UTILITIES PRIOR TO THE START OF WORK. CONTRACTOR SHALL COORDINATE LOCATIONS OF ALL UTILITIES IN PLENUM AREA BELOW PLATFORM AND VERIFY THAT ALL WORK IS COORDINATED.
- 4. REMOVE ALL RUBBISH AND DEMOLITION DEBRIS FROM THE SITE AND DISPOSE OF IN A LAWFUL MANNER.
- 5. COORDINATE GENERAL CONSTRUCTION DEMOLITION WITH THE STRUCTURAL AND ELECTRICAL DEMOLITION WORK.
- 6. REPAIR ALL EXISTING STRUCTURES, UTILITIES, AND EQUIPMENT, SCHEDULED TO REMAIN, WHICH ARE DAMAGED DURING DEMOLITION OPERATIONS. ALL WORK SCHEDULED TO BE DEMOLISHED, SHALL BE REMOVED COMPLETELY INCLUDING ALL FASTENERS, ATTACHMENTS, ACCESSORIES, AND ANY RELATED WORK.
- 7. DEMOLITION INCLUDES ALL ITEMS WHETHER OR NOT SHOWN ON THE DRAWINGS, THAT ARE REQUIRED TO BE REMOVED IN ORDER TO INSTALL THE NEW WORK SHOWN ON DRAWINGS A-102 A-507 AND OTHER PORTIONS OF THE CONTRACT DOCUMENTS.
- 8. ALL SURFACES TO REMAIN SHALL BE REFINISHED TO REPAIR ALL HOLES, SCRATCHES, DENTS, MARS, PITTING, ADHESIVE, BAD JOINTS, DEFECTIVE CMU, ETC, AS CAUSED BY DEMOLITION AND CONSTRUCTION ACTIVITY. TO BE ACCEPTABLE IN EVERY WAY TO RECEIVE NEW FINISHES.

# PARTIAL PLATFORM DEMOLITION PLAN

# A-101 SCALE: 1/8"=1'-0"

#### **DEMOLITION SHEET NOTES**

- 1) REMOVE ALL HEXAGON PAVER TILES, TRUNCATED DOME PAVER TILES, SETTING BED AND TOPPING SLAB TO STRUCTURAL SLAB (TYP).
- (2) EXISTING BRONZE HANDRAIL TO BE CAREFULLY REMOVED, STORED & RE-INSTALLED.
- CAREFULLY REMOVE EXISTING GRANITE EDGES AND GLASS LENSES ON BOTH DEMOLITION SHEETS AND TAG WITH A SEQUENTIAL NUMBER, BEFORE STORING. ANY DAMAGED PIECE NOT TO BE RE-USED SHALL BE MEASURED AND REPLACED WITH IDENTICAL PIECE OF NEW MOUNT AIRY WHITE GRANITE. CONTRACTOR SHALL NOT ASSUME THAT ALL EXISTING GRANITE EDGES ARE IDENTICAL (TYP).
- (4) REMOVE ALL EXPANSION JOINTS FOR THE FULL WIDTH OF PLATFORM (TYP).
- $\overline{\langle 5 \rangle}$  carefully remove pylons to be reused. Store at offsite storage facility.
- 6 CAREFULLY REMOVE ALL EXIST BENCHES, WINDSCREENS AND THEIR COMPONENTS TO BE REUSED AND STORE AT OFF SITE STORAGE FACILITY (TYP).
- 7 CAREFULLY REMOVE EXISTING FIRE LINE MANHOLES. FRAME TO REMAIN IN PLACE.
  REMOVE EXISTING PAVER TILES FROM THE MANHOLE LID AND RETURN IT TO WMATA.
- 8 NOT USED
- 9 EXIST CANOPY ABOVE TO REMAIN.
- (10) PROTECT EXISTING ELEVATOR AS REQUIRED FOR THE DURATION OF CONSTRUCTION.
- EXIST COLUMN WITH BUILT IN RAINWATER LEADER FROM ROOF. PROTECT AS REQUIRED DURING DEMOLITION.
- (12) EXIST RETAINING WALL. PROTECT AS REQUIRED DURING DEMOLITION.

APPROVED

- (13) EXIST CONC COLUMN. PROTECT AS REQUIRED DURING DEMOLITION.
- TEMPORARILY RELOCATE (MOVE OR RAISE NO MORE THAN 10') DISPATCH OFFICE AS REQUIRED TO ALLOW INSTALLATION OF NEW PAVERS BELOW. COORD W/ STRUCT. COORD W/ ELECT FOR TEMPORARY COMM AND ELECT HOOK UPS.
- DAMAGED GRANITE EDGE TO BE REMOVED AND REPLACED INCLUDING LENS. SEE NOTE 3 FOR REPLACEMENT PROCEDURE.

"PROFESSIONAL CERTIFICATION. I HEREBY CERTIFY THAT THESE DOCUMENTS WERE PREPARED OR APPROVED BY ME, AND THAT I AM A DULY LICENSED PROFESSIONAL ARCHITECT UNDER THE LAWS OF THE STATE OF MARYLAND, LICENSE NO. 5231-A, EXPIRATION DATE: 05-18-2015."


(16) PROTECT ESCALATOR AS REQUIRED FOR THE DURATION OF CONSTRUCTION.

- REMOVE EXIST CONDUITS TO DIORAMAS AND REROUTE LOCATIONS OF NEW CONDUITS TO CENTER UNDER DIORAMAS. SEE ELECTRICAL DRAWINGS.
- (18) REMOVE EXISTING FLOOR MOUNTED RECEPTACLES. SEE ELECT WORK
- $\langle 19 \rangle$  EXISTING COLUMN MOUNTED ELECTRICAL RECEPTACLES TO REMAIN.

AS SHOWN

- (20) PROTECT EXISTING CLEANOUTS TO REMAIN.
- $\overline{\langle 21 \rangle}$  protect existing platform end gates to remain.
- DAMAGED GLASS LENSES TO BE REMOVED AND REPLACED.

  SEE NOTE 3 FOR REPLACEMENT PROCEDURE

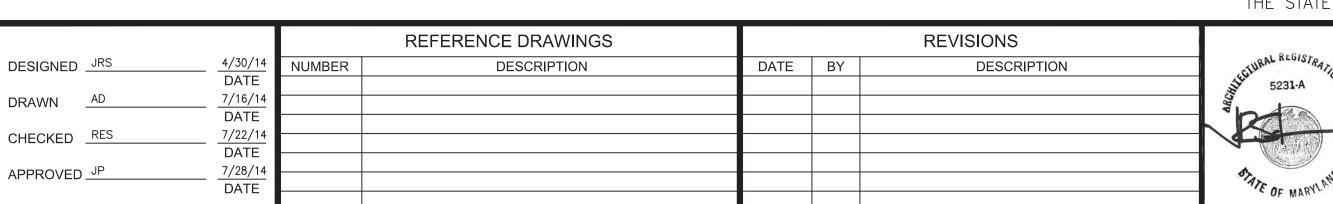

# WASHINGTON METROPOLITAN AREA TRANSIT AUTHORITY

DEPARTMENT OF TRANSIT INFRASTRUCTURE AND ENGINEERING SERVICES OFFICE OF INFRASTRUCTURE RENEWAL PROGRAM



PROJECT MANAGER

KEY PLAN
NOT TO SCALE

O 4' 8' 16'
SCALE: 1/8" = 1'-0"


RED LINE REHAB.-FRIENDSHIP HEIGHTS TO


GROSVENOR - PART 4

PARTIAL PLATFORM PLAN (DEMOLITION)

SCALE DRAWING NO. SHEET NO.

DRAWING NO. SHEET NO. M1272-145

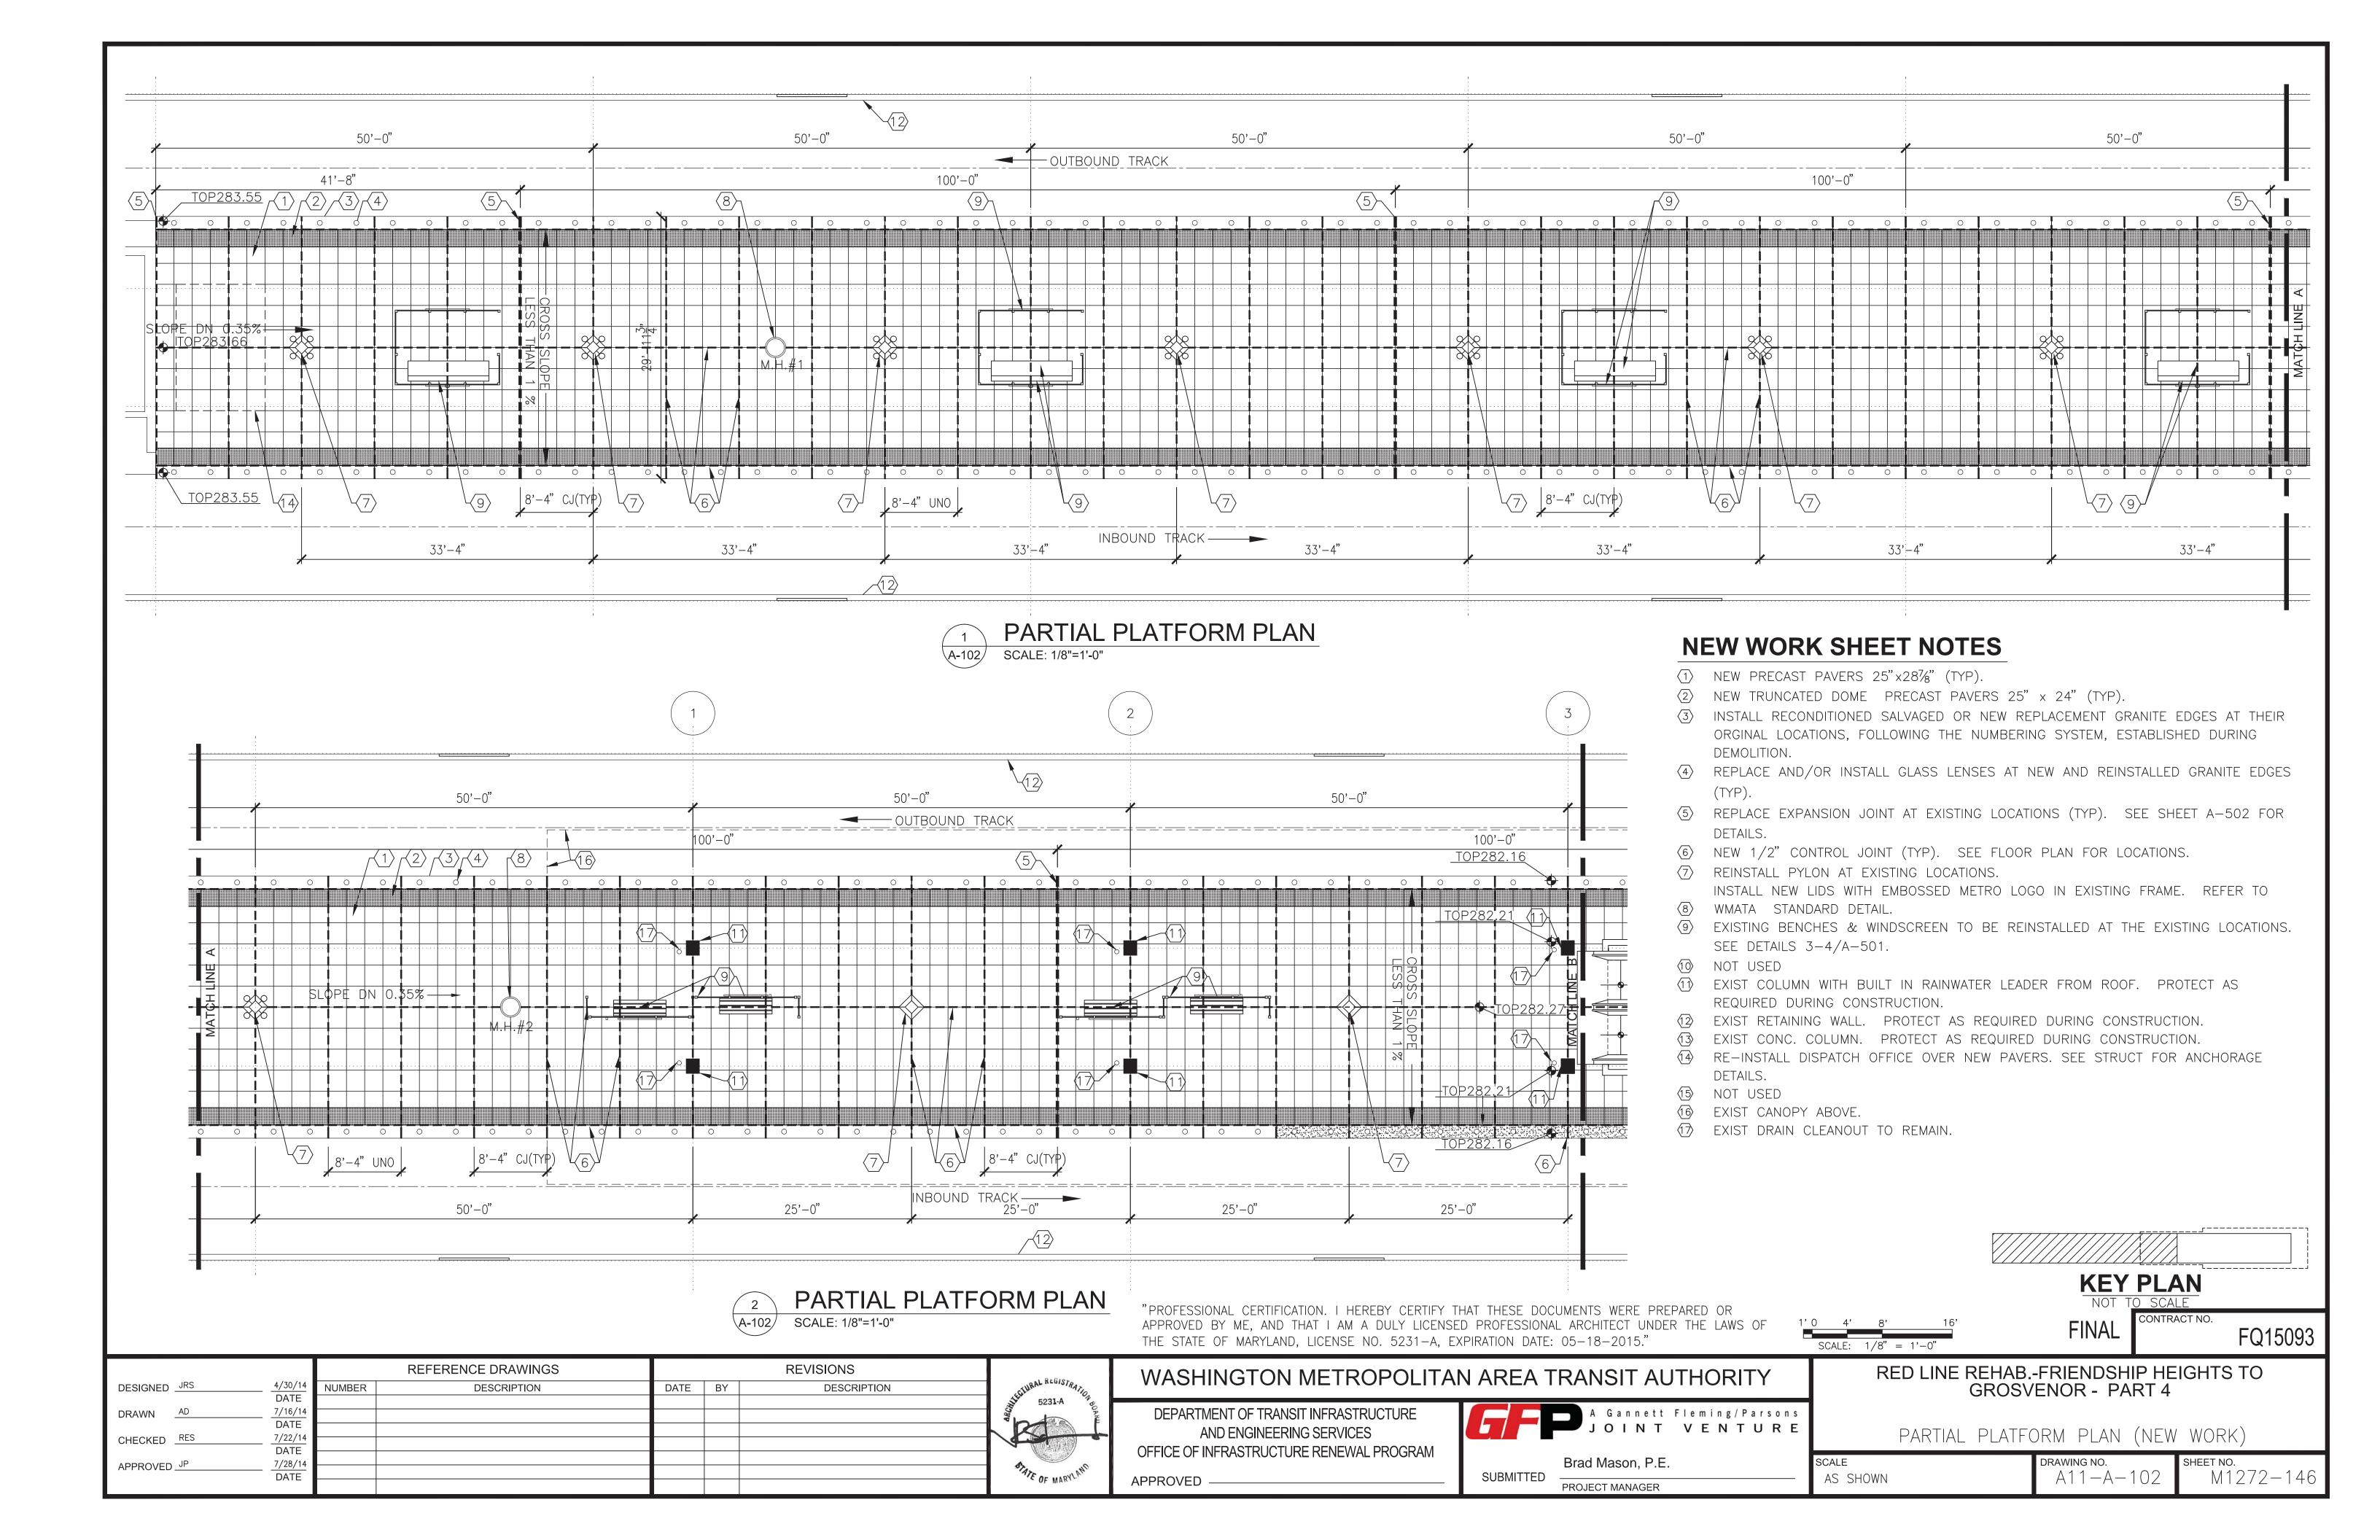

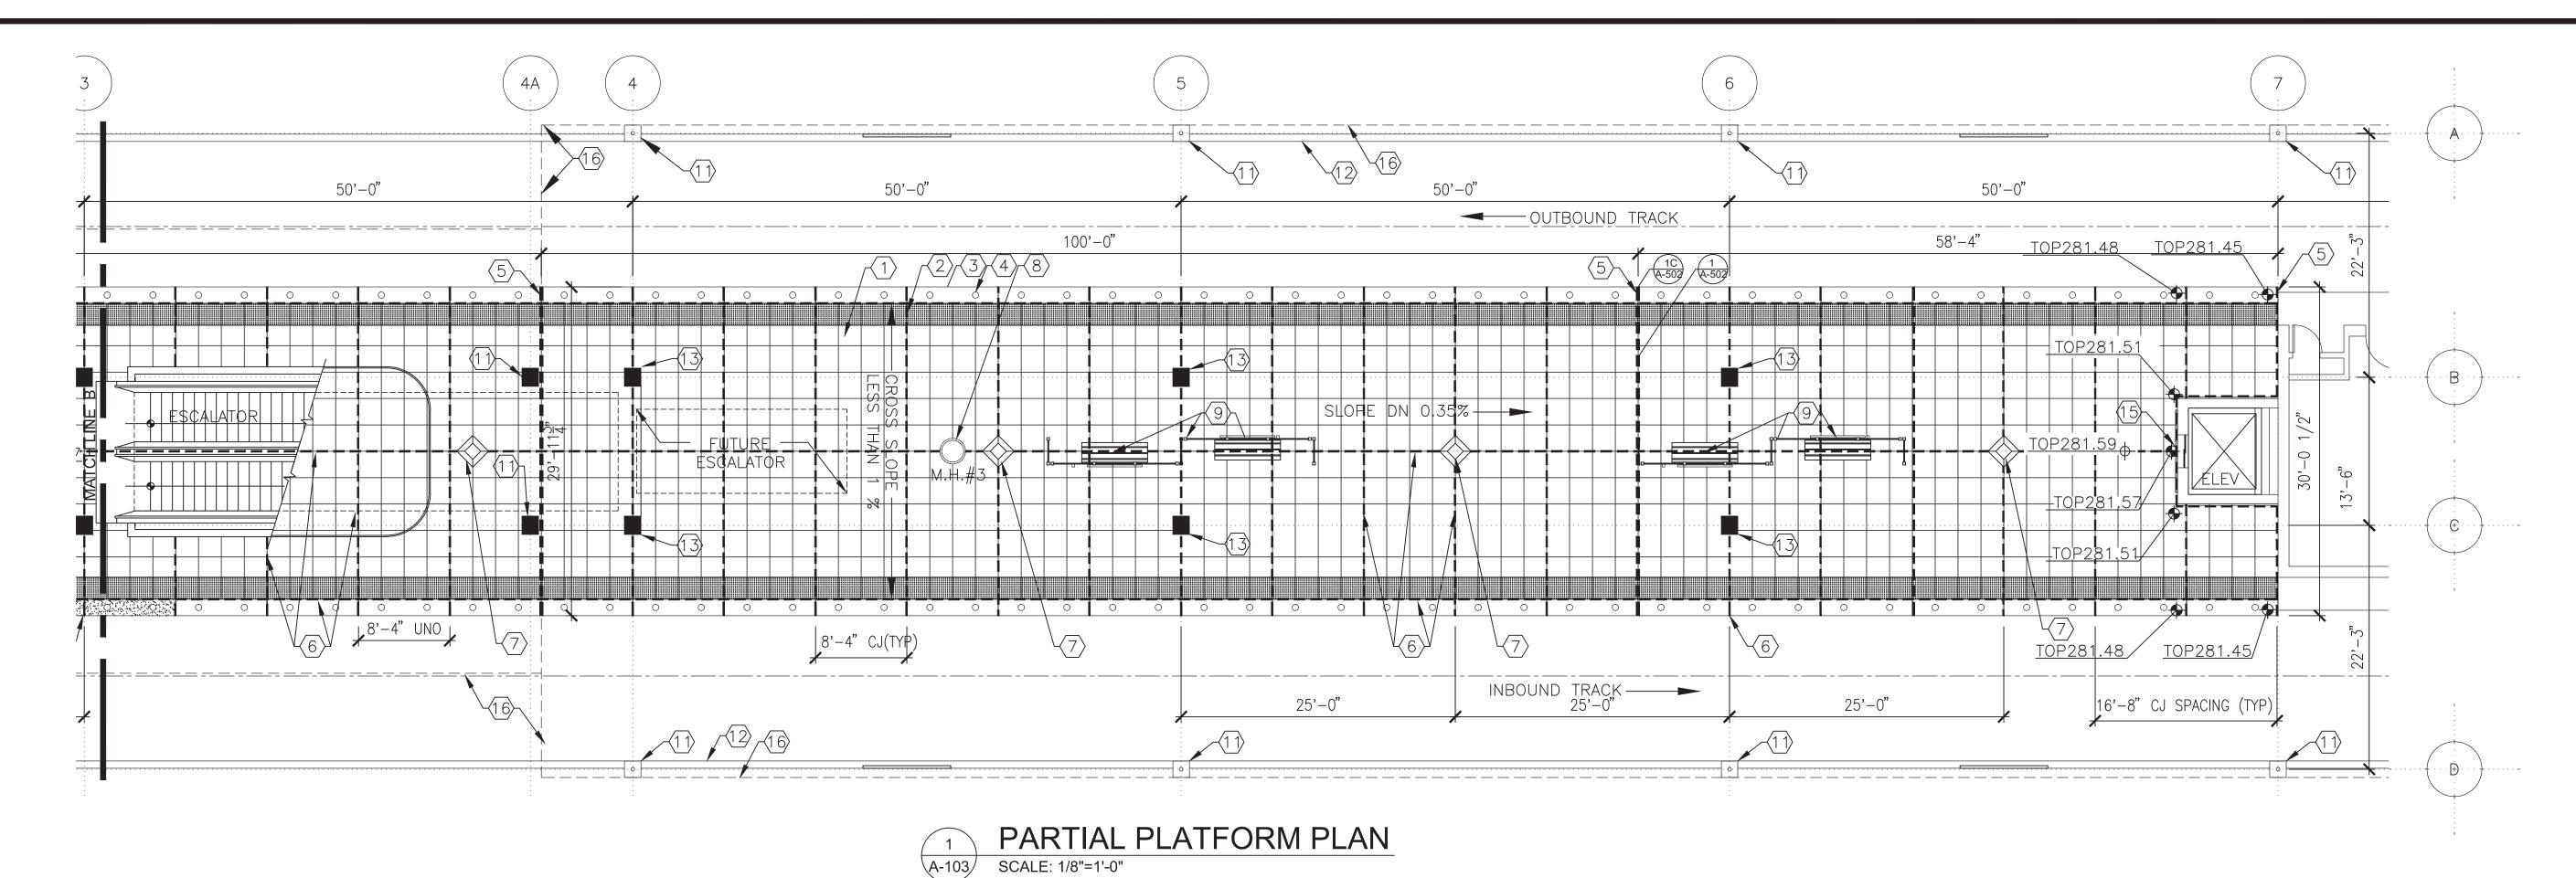

#### **GENERAL NOTES**


- 1. VERIFY ALL DIMENSIONS IN THE FIELD.
- 2. VERIFY ALL FIELD CONDITIONS.
- 3. ALL DIMENSIONS ARE NOMINAL UNLESS NOTED OTHERWISE.
- 4. ALL WORK WILL BE COMPLETED IN ACCORDANCE WITH THE LATEST VERSIONS OF I.B.C. AND LIFE SAFETY CODES. ALL WORK IS DESIGNED AND SHALL BE CONSTRUCTED IN ACCORDANCE WITH WMATA DESIGN CRITERIA, VERSION 9.
- 5. DO NOT SCALE DRAWINGS FOR PURPOSES OF CONSTRUCTION.
- 6. ANY DEVIATION FROM, OR IN FIELD ALTERATION TO THESE DRAWINGS, AND SPECIFICATIONS IS STRICTLY PROHIBITED WITHOUT PRIOR APPROVAL OF A.R. ANY SUCH ALTERATIONS SHALL BE CORRECTED AT ONCE, WITH NO EXPENSE TO THE OWNER.
- 7. THE CONTRACTOR SHALL BE RESPONSIBLE FOR COORDINATING THE WORK OF ALL TRADES REGARDLESS OF DISCREPANCIES IN THE CONTRACT DOCUMENTS. NO ADDITIONAL COSTS WILL BE PAID BY THE OWNER TO RECTIFY WORK TO BE RELOCATED DUE TO LACK OF JOBSITE COORDINATION.
- 8. DEMOLITION, CUTTING, AND PATCHING OF ANY MATERIALS OR FIXTURES REQUIRED TO CONSTRUCT THE PROJECT IS HEREIN MADE A PART OF THESE DOCUMENTS.
- 9. THE CONTRACTOR SHALL SECURE AND PAY FOR ALL PERMITS AS REQUIRED.
- 10. THE IMAGES ON THE CONSTRUCTION DOCUMENT FLOOR PLANS REFLECT THE INFORMATION FROM THE ORIGINAL CONSTRUCTION DOCUMENTS FOR THE PROJECT. IT IS NOT AN INDICATION OF NEW WORK. IT IS SHOWN IN GRAY LINE COLOR. THE NEW WORK AND REQUIRED DEMOLITION OR REMOVALS ARE SHOWN IN BLACK LINE COLOR. IF THE DIFFERENCE IS NOT OBVIOUS, REPORT TO THE A.R. IMMEDIATELY.
- 11. ALL WORK INDICATED OR SHOWN GRAPHICALLY AS "EXISTING TO REMAIN" WILL BE THE CONTRACTOR'S RESPONSIBILITY TO PROTECT AND WORK AROUND WITHOUT DISTURBING. IF DAMAGED, THE CONTRACTOR WILL REPLACE AT NO ADDITIONAL COST TO THE OWNER.
- 12. FIREPROOF ALL NEW STRUCTURAL STEEL, INCLUDING, BUT NOT LIMITED TO COLUMNS, BEAMS, METAL DECK, AND MISCELLANEOUS METALS - SEE SPECIFICATION SECTION 07.81.00.
- 13. CUTTING AND REMOVING OF GRANITE TILE EDGES WILL BE UNDERTAKEN CAREFULLY.

## **NEW WORK SHEET NOTES**

- 1 NEW PRECAST PAVERS 25"x28%" (TYP).
- (2) NEW TRUNCATED DOME PRECAST PAVERS 25" x 24" (TYP).
- INSTALL RECONDITIONED SALVAGED OR NEW REPLACEMENT GRANITE EDGES AT THEIR ORGINAL LOCATIONS, FOLLOWING THE NUMBERING SYSTEM, ESTABLISHED DURING
- (4) REPLACE AND/OR INSTALL GLASS LENSES AT NEW AND REINSTALLED GRANITE EDGES
- (5) REPLACE EXPANSION JOINT AT EXISTING LOCATIONS (TYP). SEE SHEET A-502 FOR DETAILS.
- (6) NEW 1/2" CONTROL JOINT (TYP). SEE FLOOR PLAN FOR LOCATIONS.
- (7) REINSTALL PYLON AT EXISTING LOCATIONS.
- INSTALL NEW LIDS WITH EMBOSSED METRO LOGO IN EXISTING FRAME. REFER TO

WMATA STANDARD DETAIL.

- (9) EXISTING BENCHES & WINDSCREEN TO BE REINSTALLED AT THE EXISTING LOCATIONS. SEE DETAILS 3-4/A-501.
- (10) NOT USED
- (1) EXIST COLUMN WITH BUILT IN RAINWATER LEADER FROM ROOF. PROTECT AS REQUIRED DURING CONSTRUCTION.
- (12) EXIST RETAINING WALL. PROTECT AS REQUIRED DURING CONSTRUCTION.
- (13) EXIST CONC. COLUMN. PROTECT AS REQUIRED DURING CONSTRUCTION.
- (14) RE-INSTALL DISPATCH OFFICE OVER NEW PAVERS. SEE STRUCT FOR ANCHORAGE DETAILS.
- (15) NOT USED
- (16) EXIST CANOPY ABOVE.
- (7) EXIST DRAIN CLEANOUT TO REMAIN.

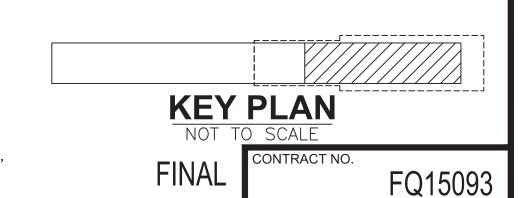

"PROFESSIONAL CERTIFICATION. I HEREBY CERTIFY THAT THESE DOCUMENTS WERE PREPARED OR APPROVED BY ME, AND THAT I AM A DULY LICENSED PROFESSIONAL ARCHITECT UNDER THE LAWS OF THE STATE OF MARYLAND, LICENSE NO. 5231-A, EXPIRATION DATE: 05-18-2015."

WASHINGTON METROPOLITAN AREA TRANSIT AUTHORITY

DEPARTMENT OF TRANSIT INFRASTRUCTURE AND ENGINEERING SERVICES OFFICE OF INFRASTRUCTURE RENEWAL PROGRAM

APPROVED




PROJECT MANAGER


RED LINE REHAB.-FRIENDSHIP HEIGHTS TO GROSVENOR - PART 4


SCALE: 1/8" = 1'-0"

PARTIAL PLATFORM PLAN (NEW WORK)

SCALE A11 - A - 103M1272 - 147AS SHOWN

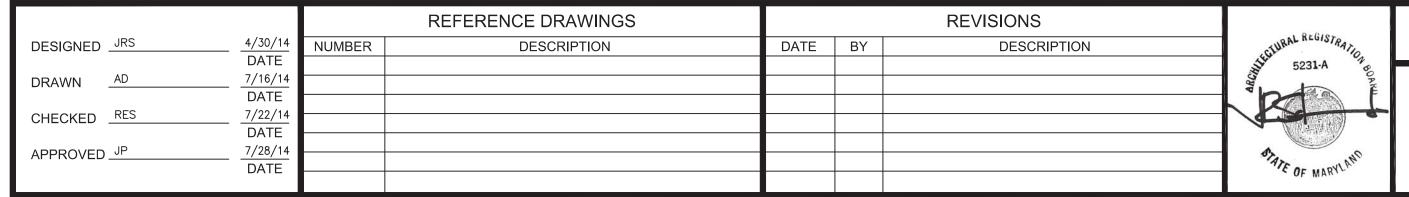

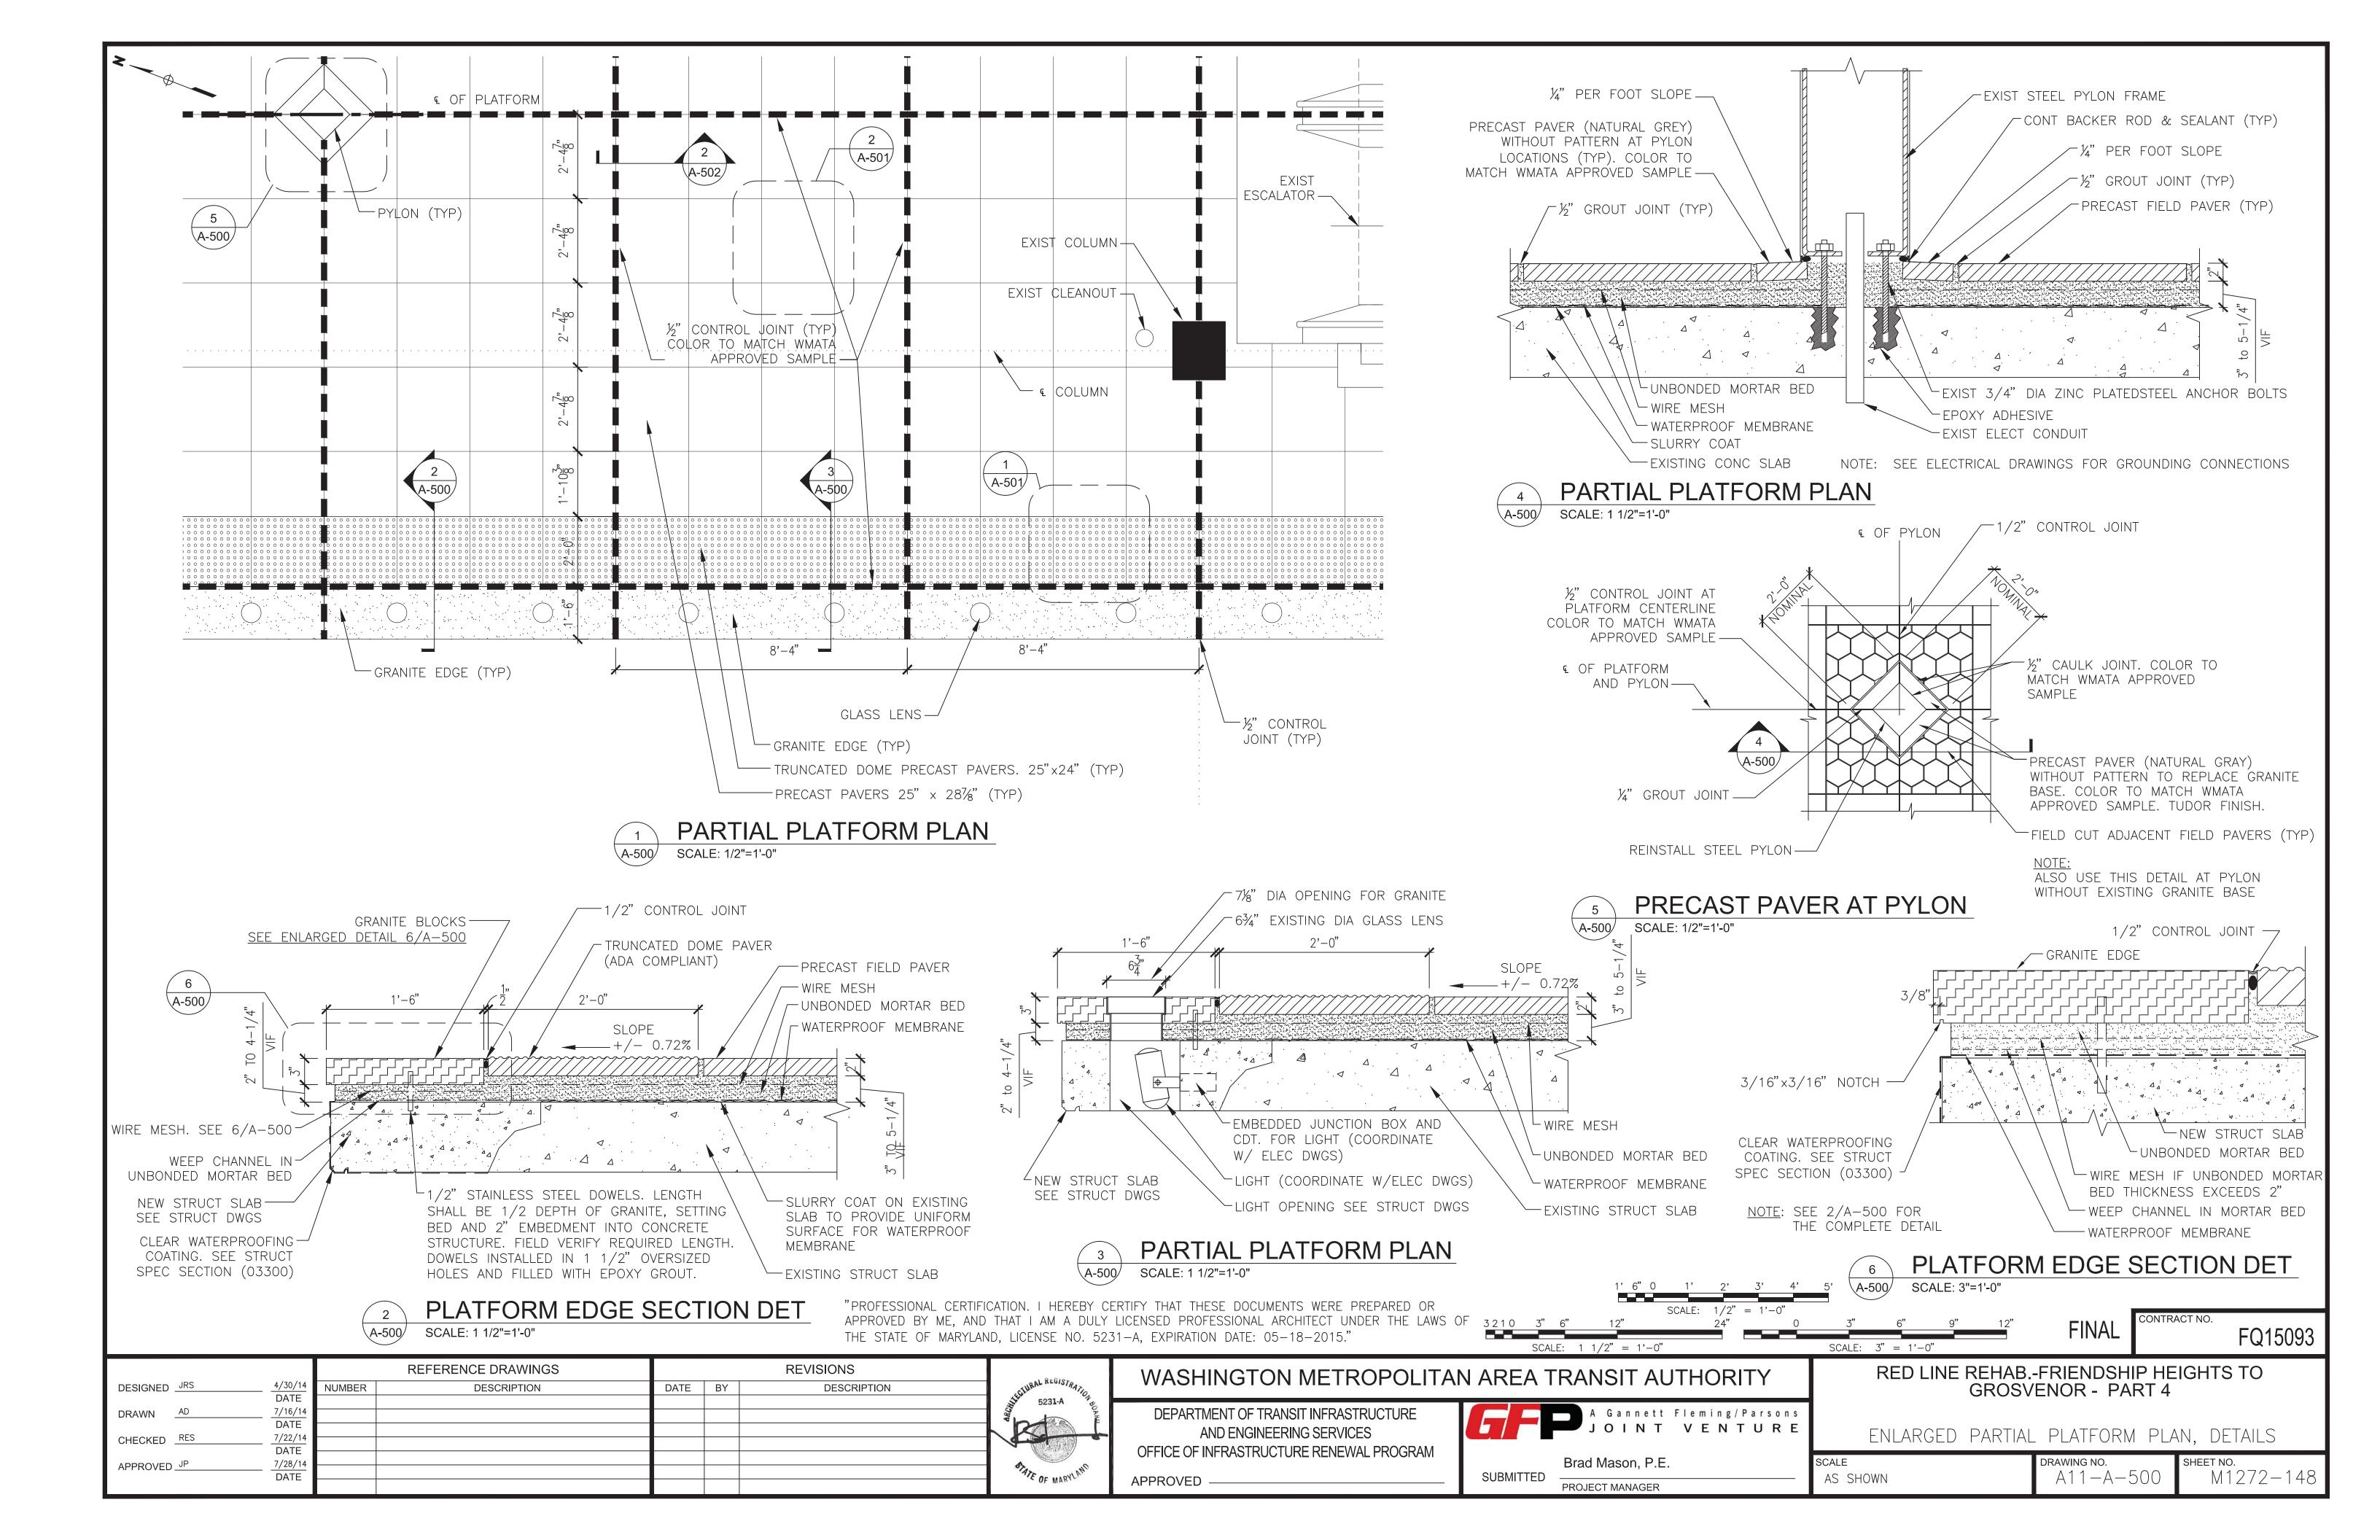


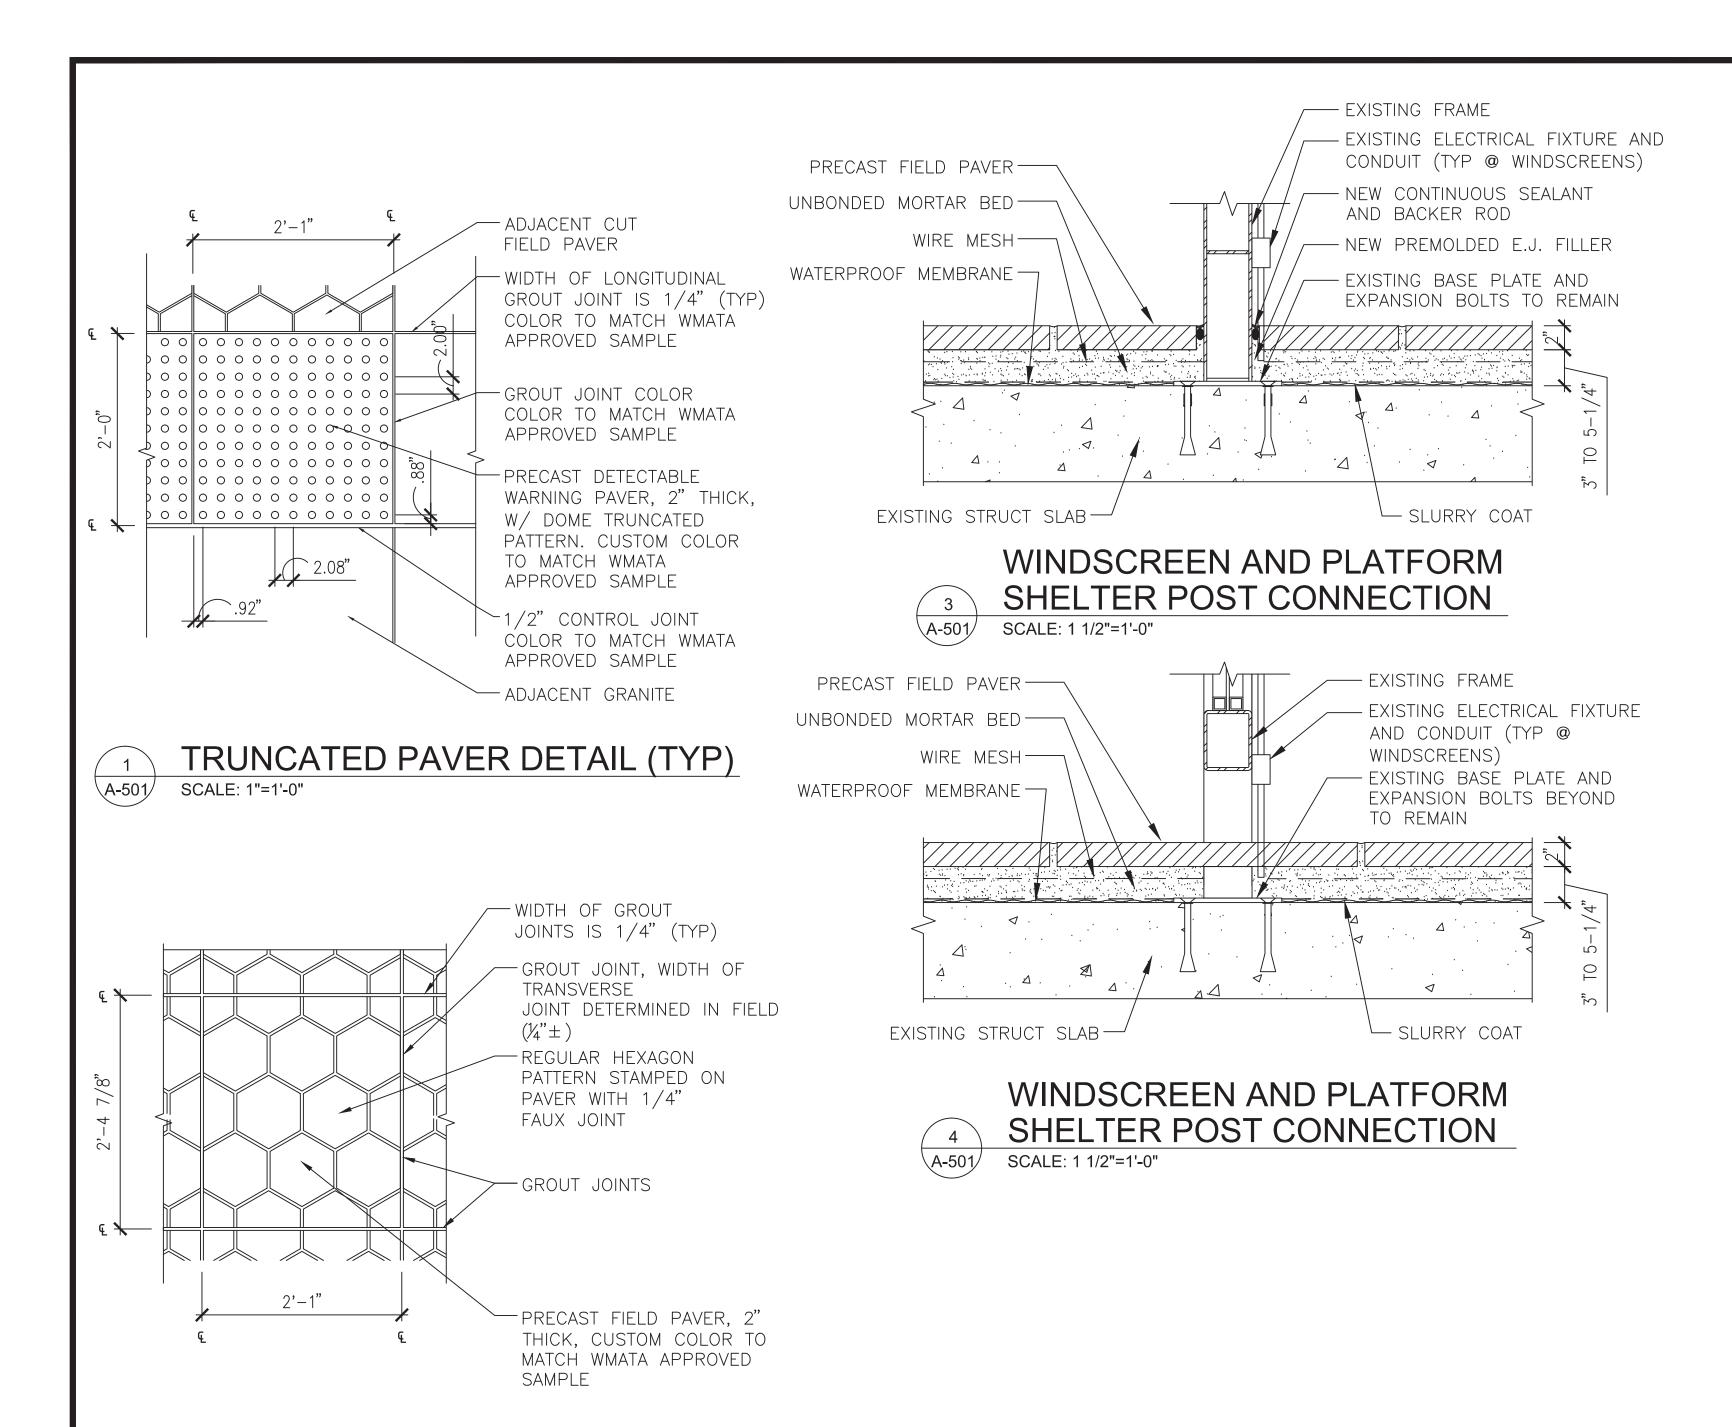

2 TYPICAL PAVER DETAIL

SCALE: 1"=1'-0"

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FINAL

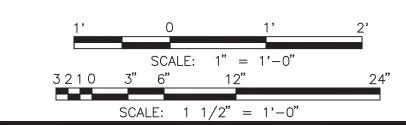FQ15093

DESIGNED JRS 4/30/14 DATE

CHECKED RES 7/22/14 DATE

APPROVED JP 7/28/14 DATE

DESCRIPTION DATE BY DESCRIPTION

DATE BY DESCRIPTION

DATE BY DESCRIPTION

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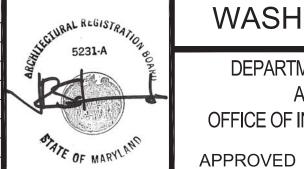
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# WASHINGTON METROPOLITAN AREA TRANSIT AUTHORITY

DEPARTMENT OF TRANSIT INFRASTRUCTURE
AND ENGINEERING SERVICES
OFFICE OF INFRASTRUCTURE RENEWAL PROGRAM

A Gannett Fleming/Parsons
JOINT VENTURE

RED LINE REHAB.-FRIENDSHIP HEIGHTS TO GROSVENOR - PART 4


ENLARGED PARTIAL PLATFORM PLAN, DETAILS


Brad Mason, P.E.

PROJECT MANAGER

SCALE DRAWING NO. A11-A-501

M1272-149

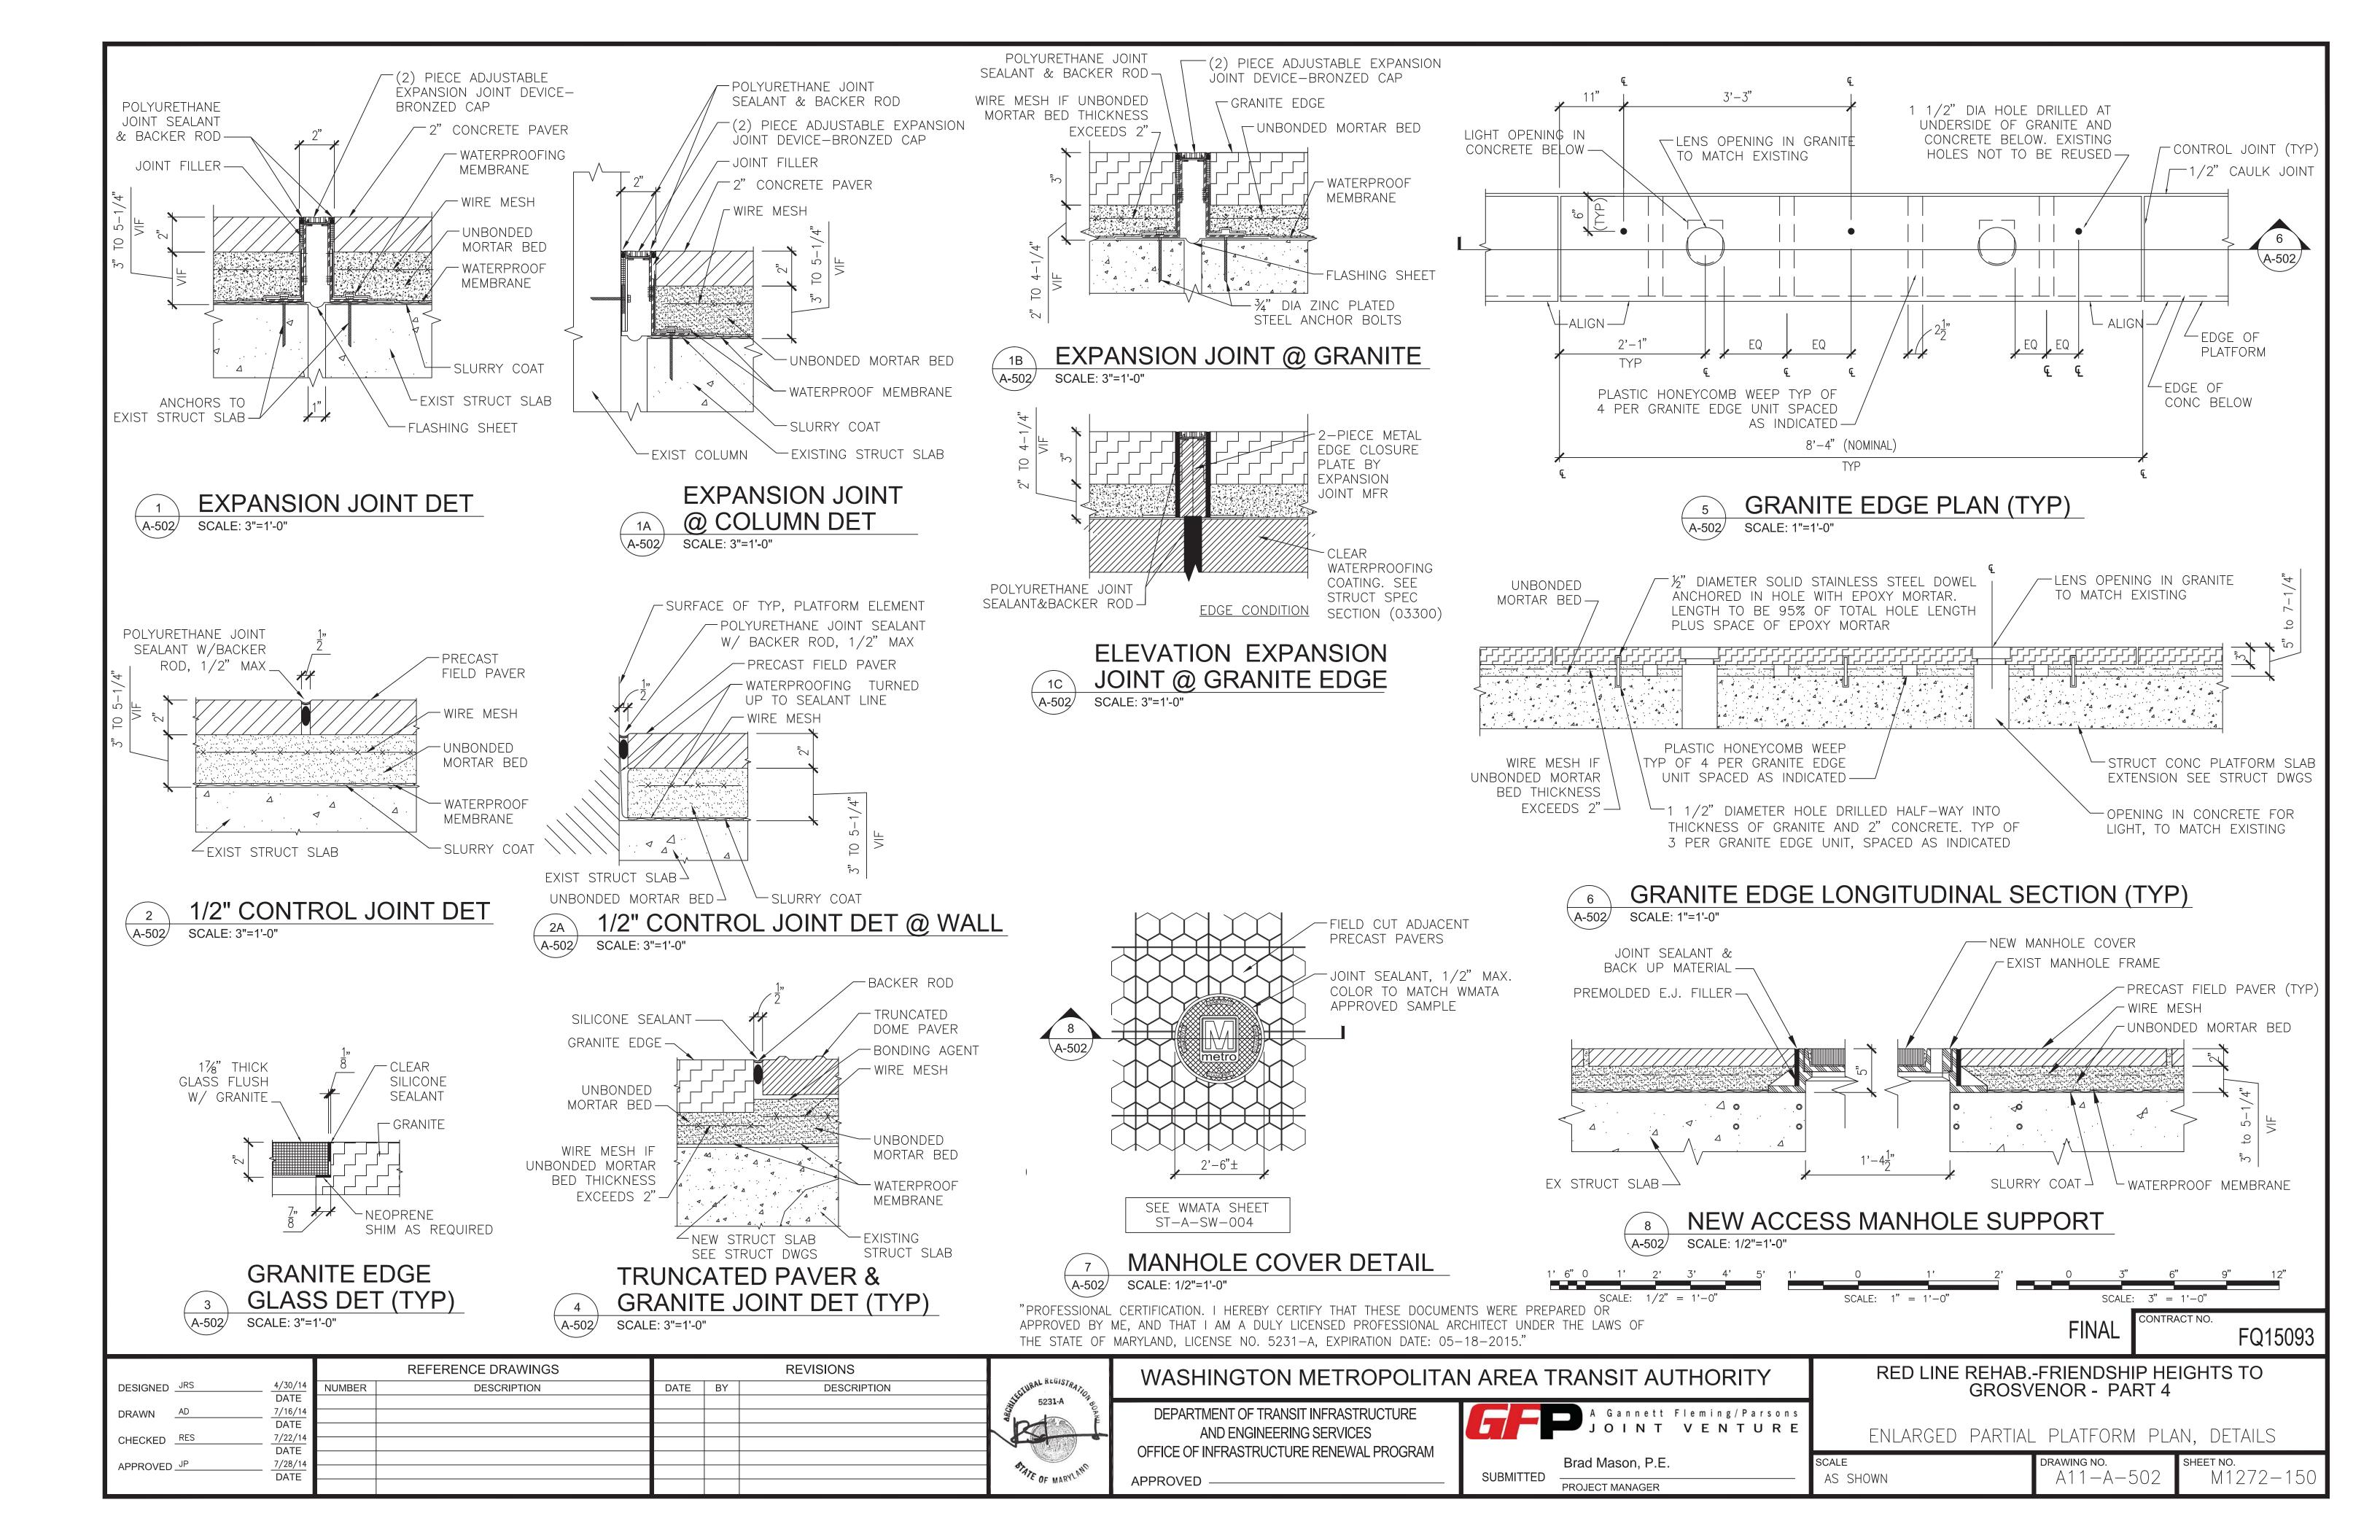


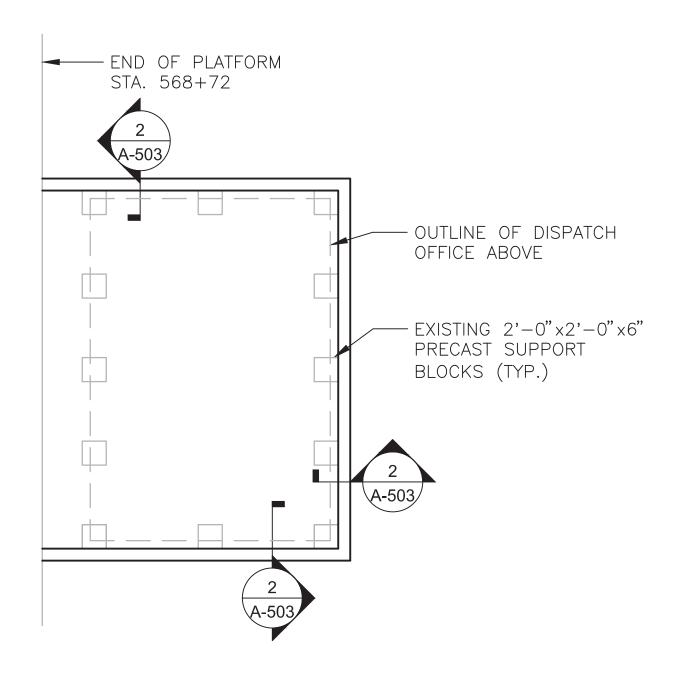



#### NOTES:

- 1. THE CONTRACTOR SHALL IDENTIFY THE LOCATIONS OF EXISTING REINFORCING STEEL AND OTHER EMBEDDED ITEMS IN THE PLATFORM PRIOR TO DRILLING HOLES TO INSTALL NEW CURB.
- 2. DISPATCH OFFICE TO REMAIN IN PLACE DURING WORK.
- 3. TOP OF CURB TO MATCH ELEVATION OF TOP OF NEW PAVERS.

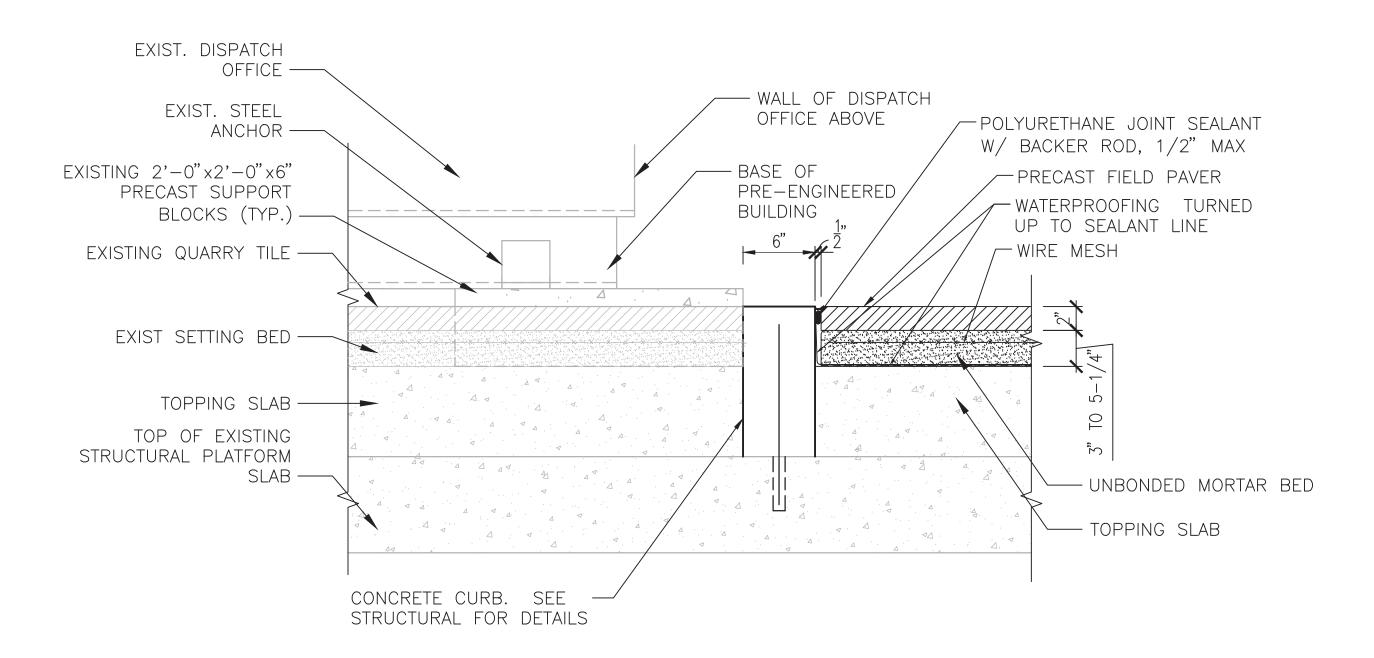



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REFERENCE DRAWINGS REVISIONS WRAL REGISTRA DESIGNED JRS DATE BY DESCRIPTION NUMBER DESCRIPTION 5231-A 7/16/14 DATE DRAWN AD 7/22/14 DATE CHECKED RES 7/28/14 DATE APPROVED JP

WASHINGTON METROPOLITAN AREA TRANSIT AUTHORITY DEPARTMENT OF TRANSIT INFRASTRUCTURE AND ENGINEERING SERVICES OFFICE OF INFRASTRUCTURE RENEWAL PROGRAM Brad Mason, P.E. APPROVED -

A Gannett Fleming/Parsons
JOINT VENTURE

PROJECT MANAGER

RED LINE REHAB.-FRIENDSHIP HEIGHTS TO GROSVENOR - PART 4

FQ15093

CONCRETE CURB DETAIL AT DISPATCHER'S OFFICE

M1272 - 151A11 - A - 503AS SHOWN

SCALE:  $1 \frac{1}{2} = 1'-0''$ FINAL

#### I - GENERAL

- 1. GENERAL NOTES ARE TO BE READ IN CONJUNCTION WITH THE TECHNICAL PROVISIONS, SPECIAL PROVISIONS AND THESE DRAWINGS.
- 2. ALL DIMENSIONS OF EXISTING STRUCTURES ARE NOMINAL UNLESS OTHERWISE NOTED. CONTRACTOR IS RESPONSIBLE FOR VERIFYING ALL LOCATIONS, DIMENSIONS AND ELEVATIONS OF EXISTING STRUCTURES, UTILITIES, ETC. ANY DISCREPANCIES ARISING BETWEEN EXISTING CONDITIONS AND DETAILS SHOWN ON CONTRACT PLANS SHALL BE REPORTED TO THE AUTHORITY'S REPRESENTATIVE (A.R.) FOR RESOLUTION.
- 3. VERIFY AND PROPERLY DOCUMENT ALL EXISTING FIELD CONDITIONS.
- 4. ALL WORK IS DESIGNED AND SHALL BE CONSTRUCTED IN ACCORDANCE WITH WMATA MANUAL OF DESIGN CRITERIA FOR MAINTENANCE AND CONTINUED OPERATION OF FACILITIES AND SYSTEMS, RELEASE 9. MAY 2008.
- 5. ALL PLAN DIMENSIONS SHALL BE MEASURED IN TRUE HORIZONTAL PLANE AND ALL VERTICAL DIMENSIONS SHALL BE MEASURED IN TRUE VERTICAL PLANE EXCEPT AS OTHERWISE NOTED.
- 6. THE CONTRACTOR SHALL COORDINATE AND VERIFY THE LOCATIONS AND SIZES OF ALL REQUIRED OPENINGS WITH ARCHITECTURAL, MECHANICAL AND ELECTRICAL PLANS AND SPECIFICATIONS AND/OR OF ALL ELECTRICAL AND MECHANICAL UTILITIES TO BE DETACHED FROM AND ATTACHED TO THE STRUCTURE.
- 7. ANY DEVIATION FROM, OR IN FIELD ALTERATION TO THESE DRAWINGS, AND SPECIFICATIONS IS STRICTLY PROHIBITED WITHOUT PRIOR APPROVAL OF AUTHORITY'S REPRESENTATIVE (A.R.). ANY SUCH ALTERATIONS SHALL BE CORRECTED AT ONCE, WITH NO EXPENSE TO THE OWNER.
- 8. THE CONTRACTOR SHALL BE RESPONSIBLE FOR COORDINATING THE WORK OF ALL TRADES REGARDLESS OF DISCREPANCIES IN THE CONTRACT DOCUMENTS. NO ADDITIONAL COSTS WILL BE PAID BY THE OWNER TO RECTIFY WORK TO BE RELOCATED DUE TO LACK OF JOBSITE COORDINATION.
- 9. EMBEDDED ITEMS REQUIRED FOR WORK OF THE VARIOUS TRADES ARE NOT SHOWN IN THE STRUCTURAL DRAWINGS. THE CONTRACTOR SHALL REFER TO DRAWINGS OF VARIOUS TRADES FOR ALL INSERT, ANCHOR BOLTS, CONDUITS, PIPES AND ANY OTHER NON-STRUCTURAL ITEMS. WORK SHALL BE COORDINATED WITH THE VARIOUS TRADES TO AVOID CONFLICT OR INTERFERENCE WITH REINFORCING STEEL OR STRUCTURAL STEEL MEMBERS. IF THERE IS A DISCREPANCY BETWEEN DRAWINGS IT IS THE CONTRACTOR'S RESPONSIBILITY TO NOTIFY THE A.R. PRIOR TO PERFORMING WORK.
- 10. NOTES, TYPICAL DETAILS AND SCHEDULES APPLY TO ALL STRUCTURAL WORK UNLESS OTHERWISE NOTED. FOR CONDITIONS NOT SPECIFICALLY SHOWN, PROVIDE DETAILS OF A SIMILAR NATURE, VERIFY APPLICABILITY BY SUBMITTING SHOP DRAWINGS FOR REVIEW.
- 11. DO NOT SCALE DRAWINGS TO OBTAIN DIMENSIONAL INFORMATION.
- 12. DO NOT CUT OR ALTER ANY EXISTING STRUCTURAL MEMBER WITHOUT WRITTEN AUTHORIZATION OF THE A.R. UNLESS OTHERWISE SHOWN IN DRAWINGS.
- 13. AT ALL TIMES THE CONTRACTOR SHALL BE SOLELY RESPONSIBLE FOR THE CONDITIONS OF THE JOBSITE INCLUDING SAFETY OF PERSONS AND PROPERTY. THE A.R. PRESENCE OR REVIEW OF WORK DOES NOT INCLUDE THE ADEQUACY OF THE CONTRACTOR'S MEANS OR METHODS OF CONSTRUCTION.
- 14. SHORING, BRACING AND PROTECTION OF EXISTING AND ADJACENT STRUCTURES DURING CONSTRUCTION IS THE SOLE RESPONSIBILITY OF THE CONTRACTOR. PROTECT AND MAINTAIN THE INTEGRITY OF ADJACENT STRUCTURES.
- 15. DRAWINGS HAVE BEEN PREPARED BASED ON AVAILABLE KNOWLEDGE OF EXISTING CONDITIONS. PRIOR TO PREPARATION OF SHOP DRAWINGS. CONTRACTOR SHALL VERIFY AND/OR DETERMINE SIZE, LOCATION, CONFIGURATION, ETC. OF EXISTING STRUCTURE AT EVERY LOCATION WHERE NEW WORK IS TO ABUT, ATTACH, CLEAR, ETC. WITH EXISTING WORKS. NOTIFY A.R. IN WRITING OF ANY AND ALL CONDITIONS WHICH DIFFER FROM THOSE SHOWN ON DRAWINGS.
- 16. DIMENSIONS INDICATED THROUGHOUT THE DRAWING SET ARE BASED ON WASHINGTON METROPOLITAN AREA TRANSIT AUTHORITY (WMATA) ISSUED RECORD DRAWINGS. THOSE DIMENSIONS TO BE VERIFIED IN FIELD. ANY VARIATION TO DIMENSIONS INDICATED SHOULD BE PROVIDED TO THE A.R.

# STRUCTURAL GENERAL NOTES

- 17. DEMOLITION, CUTTING, AND PATCHING OF ANY MATERIALS OR FIXTURES REQUIRED TO CONSTRUCT THE PROJECT IS HEREIN MADE A PART OF THESE CONTRACT DOCUMENTS.
- 18. THE CONTRACTOR SHALL SECURE AND PAY FOR ALL PERMITS.
- 19. ALL WORK INDICATED OR SHOWN GRAPHICALLY AS "EXISTING TO REMAIN" WILL BE THE CONTRACTOR'S RESPONSIBILITY TO PROTECT AND WORK AROUND WITHOUT DISTURBING. IF DAMAGED, THE CONTRACTOR WILL REPLACE OR REPAIR AT THE AUTHORITY'S DIRECTION AT NO ADDITIONAL COST TO THE OWNER.
- 20. WHEN ANCHORING, SHOOTING, DRILLING, CHIPPING, OR CORING INTO CONCRETE, THE AREA SHALL BE X-RAYED, FERRO SCANNED, OR SCANNED USING GROUND PENETRATION RADAR (GPR) PRIOR TO START OF WORK. DO NOT CUT OR NICK EXISTING REINFORCING.

#### II -DESIGN CRITERIA

- A. DESIGN CODES AND SPECIFICATIONS:
  - 1. WMATA MANUAL OF DESIGN CRITERIA RELEASE 9, 2008.
- 2. 2012 INTERNATIONAL BUILDING CODE.
- 3. REINFORCED CONCRETE SLABS: ACI 318-11, BUILDING CODE REQUIREMENTS FOR STRUCTURAL CONCRETE AND COMMENTARY.
- 4. STRUCTURAL STEEL: AISC. STEEL CONSTRUCTION MANUAL. NINTH EDITION.
- B. DESIGN LOADS
  - 1. DEAD LOADS, SHALL BE ACTUAL CALCULATED WEIGHT OF MATERIAL AND PERMANENTLY AFFIXED
  - 2. LIVE LOADS FOR PLATFORM: UNIFORM 150 PSF
- C. MATERIALS
  - CAST-IN-PLACE, f'c=5000 PSI 1. CONCRETE:
  - 2. REINFORCING STEEL: ASTM A615, GRADE 60, fv=60 KSI

#### **III - REINFORCING STEEL**

- 1. ALL REINFORCING STEEL SHALL BE EPOXY COATED.
- 2. REINFORCEMENT DETAILS SHALL CONFORM TO THE REQUIREMENTS OF ACI DETAILING MANUAL 2004.
- 3. ALL DIMENSIONS TO REINFORCING ARE TO CENTERLINE OF BAR UNLESS OTHERWISE NOTED.
- 4. CONCRETE PROTECTION FOR MAIN REINFORCEMENT SHALL BE AS FOLLOWS UNLESS OTHERWISE NOTED:

APPROVED

TOP BARS: 1" CLEAR TO MATCH W/ EXISTING REBAR

SIDE BARS: 2" CLEAR COVER BOTTOM BARS: 1½" CLEAR COVER

#### IV - CONSTRUCTION

- 1. ALL SURFACES SHOWN VERTICAL ARE TO BE CONSTRUCTED TRULY VERTICAL, EXCEPT AS NOTED OTHERWISE.
- 2. ALL EXPOSED EDGES SHALL BE CHAMFERED  $\frac{3}{4}$ "x  $\frac{3}{4}$ ". UNLESS OTHERWISE NOTED.
- 3. THE CONTRACTOR SHALL SUBMIT THE CONSTRUCTION SEQUENCE TO THE A.R. FOR REVIEW PRIOR TO COMMENCING ANY DEMOLITION OR CONSTRUCTION ACTIVITIES. SUBMITTAL SHALL INCLUDE, BUT NOT LIMITED TO THE SEQUENCE OF SLAB REMOVAL AND INSTALLATION INCLUDING DETAILED DESIGN OF TEMPORARY SHORING.
- 4. ALL NON-KEYED CONSTRUCTION JOINTS SHALL BE ROUGHENED IN ACCORDANCE WITH ACI 318-11. AND BONDED WITH AN APPROVED BONDING AGENT.
- 5. THE CONTRACTOR SHALL IDENTIFY THE LOCATIONS OF EXISTING REINFORCING STEEL AND OTHER EMBEDDED ITEMS IN THE PLATFORM PRIOR TO DRILLING HOLES TO GROUT IN NEW REINFORCING.
- 6. TYPICAL REPAIR DETAILS FOR CRACKS AND SPALLING IN STRUCTURAL PLATFORM SLAB ARE PROVIDED. CONTRACTOR SHALL COORDINATE THE EXTENT AND REPAIR REQUIRED WITH THE A.R. PRIOR TO STARTING REPAIR WORK.
- 7. ALL UTILITIES SUCH AS PIPING, CABLES, CONDUITS AND ARCHITECTURAL ELEMENTS SHALL BE TEMPORARILY RELOCATED OR PROTECTED TO PREVENT THE NEED FOR REMEDIAL WORK PRIOR TO RESUMING RAIL OPERATIONS.
- 8. THE CONTRACTOR SHALL TAKE NECESSARY STEPS TO PREVENT THE REMOVED MATERIAL FROM ENTERING THE EXISTING DRAINAGE FACILITIES.
- 9. THE CONTRACTOR SHALL REMOVE THE DEBRIS RESULTING FROM DEMOLITION WORK TO A LOCATION OUTSIDE THE AUTHORITY'S RIGHT-OF-WAY PRIOR TO RESUMING FULL RAIL OPERATION OR TO PRE-APPROVED STAGING AREAS. ALL REMOVED MATERIALS AND DEBRIS TO BE DISPOSED OF PROPERLY AT NO ADDITIONAL COST TO THE OWNER.
- 10. THE CONTRACTOR SHALL PROVIDE TEMPORARY DECKING IF PAVER WORK WILL NOT BE COMPLETED PRIOR TO PEDESTRIAN TRAFFIC ACCESS TO THE PLATFORM. CONTRACTOR SHALL SUBMIT DETAILS AND MATERIALS OF THE TEMPORARY DECKING TO A.R. PRIOR TO USE FOR REVIEW AND APPROVAL

#### **ABBREVIATIONS**

A.R. AUTHORITY'S REPRESENTATIVE ARCHITECTURAL ARCH. BOTT. BOTTOM CENTERLINE C/C CENTER TO CENTER CLR. CLEAR COL. COLUMN CONC. CONCRETE CONT. CONTINUOUS DET. DETAIL DRAWING DWG. EXIST. EXISTING FXP. EXPANSION FIN. FINISH FLOOR FLR. GALV. GALVANIZED JOINT JT. MAX. MAXIMUM MEZZ. MEZZANINE MIN. MINIMUM OPP. OPPOSITE PROP. PROPOSED REINF. REINFORCING SIM. SIMILAR STATION STA. STRUC. STRUCTURAL TOP OF RAIL T/R TYPICAL TYP. U.O.N. UNLESS OTHERWISE NOTED

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FQ15093

REFERENCE DRAWINGS REVISIONS DESIGNED MP NUMBER DESCRIPTION DATE BY DESCRIPTION 1/23/15 DRAWN LN 1/23/15 CHECKED DB DATE 1/23/15 APPROVED DB

# WASHINGTON METROPOLITAN AREA TRANSIT AUTHORITY

SUBMITTED

DEPARTMENT OF TRANSIT INFRASTRUCTURE AND ENGINEERING SERVICES OFFICE OF INFRASTRUCTURE RENEWAL PROGRAM



Brad Mason, P.E.

PROJECT MANAGER


GROSVENOR STATION - STRUCTURAL GENERAL NOTES AND ABBREVIATIONS


RED LINE REHAB.-FRIENDSHIP HEIGHTS TO


**GROSVENOR - PART 4** 


DRAWING NO. AS SHOWN

M1272-152 A11-S-001

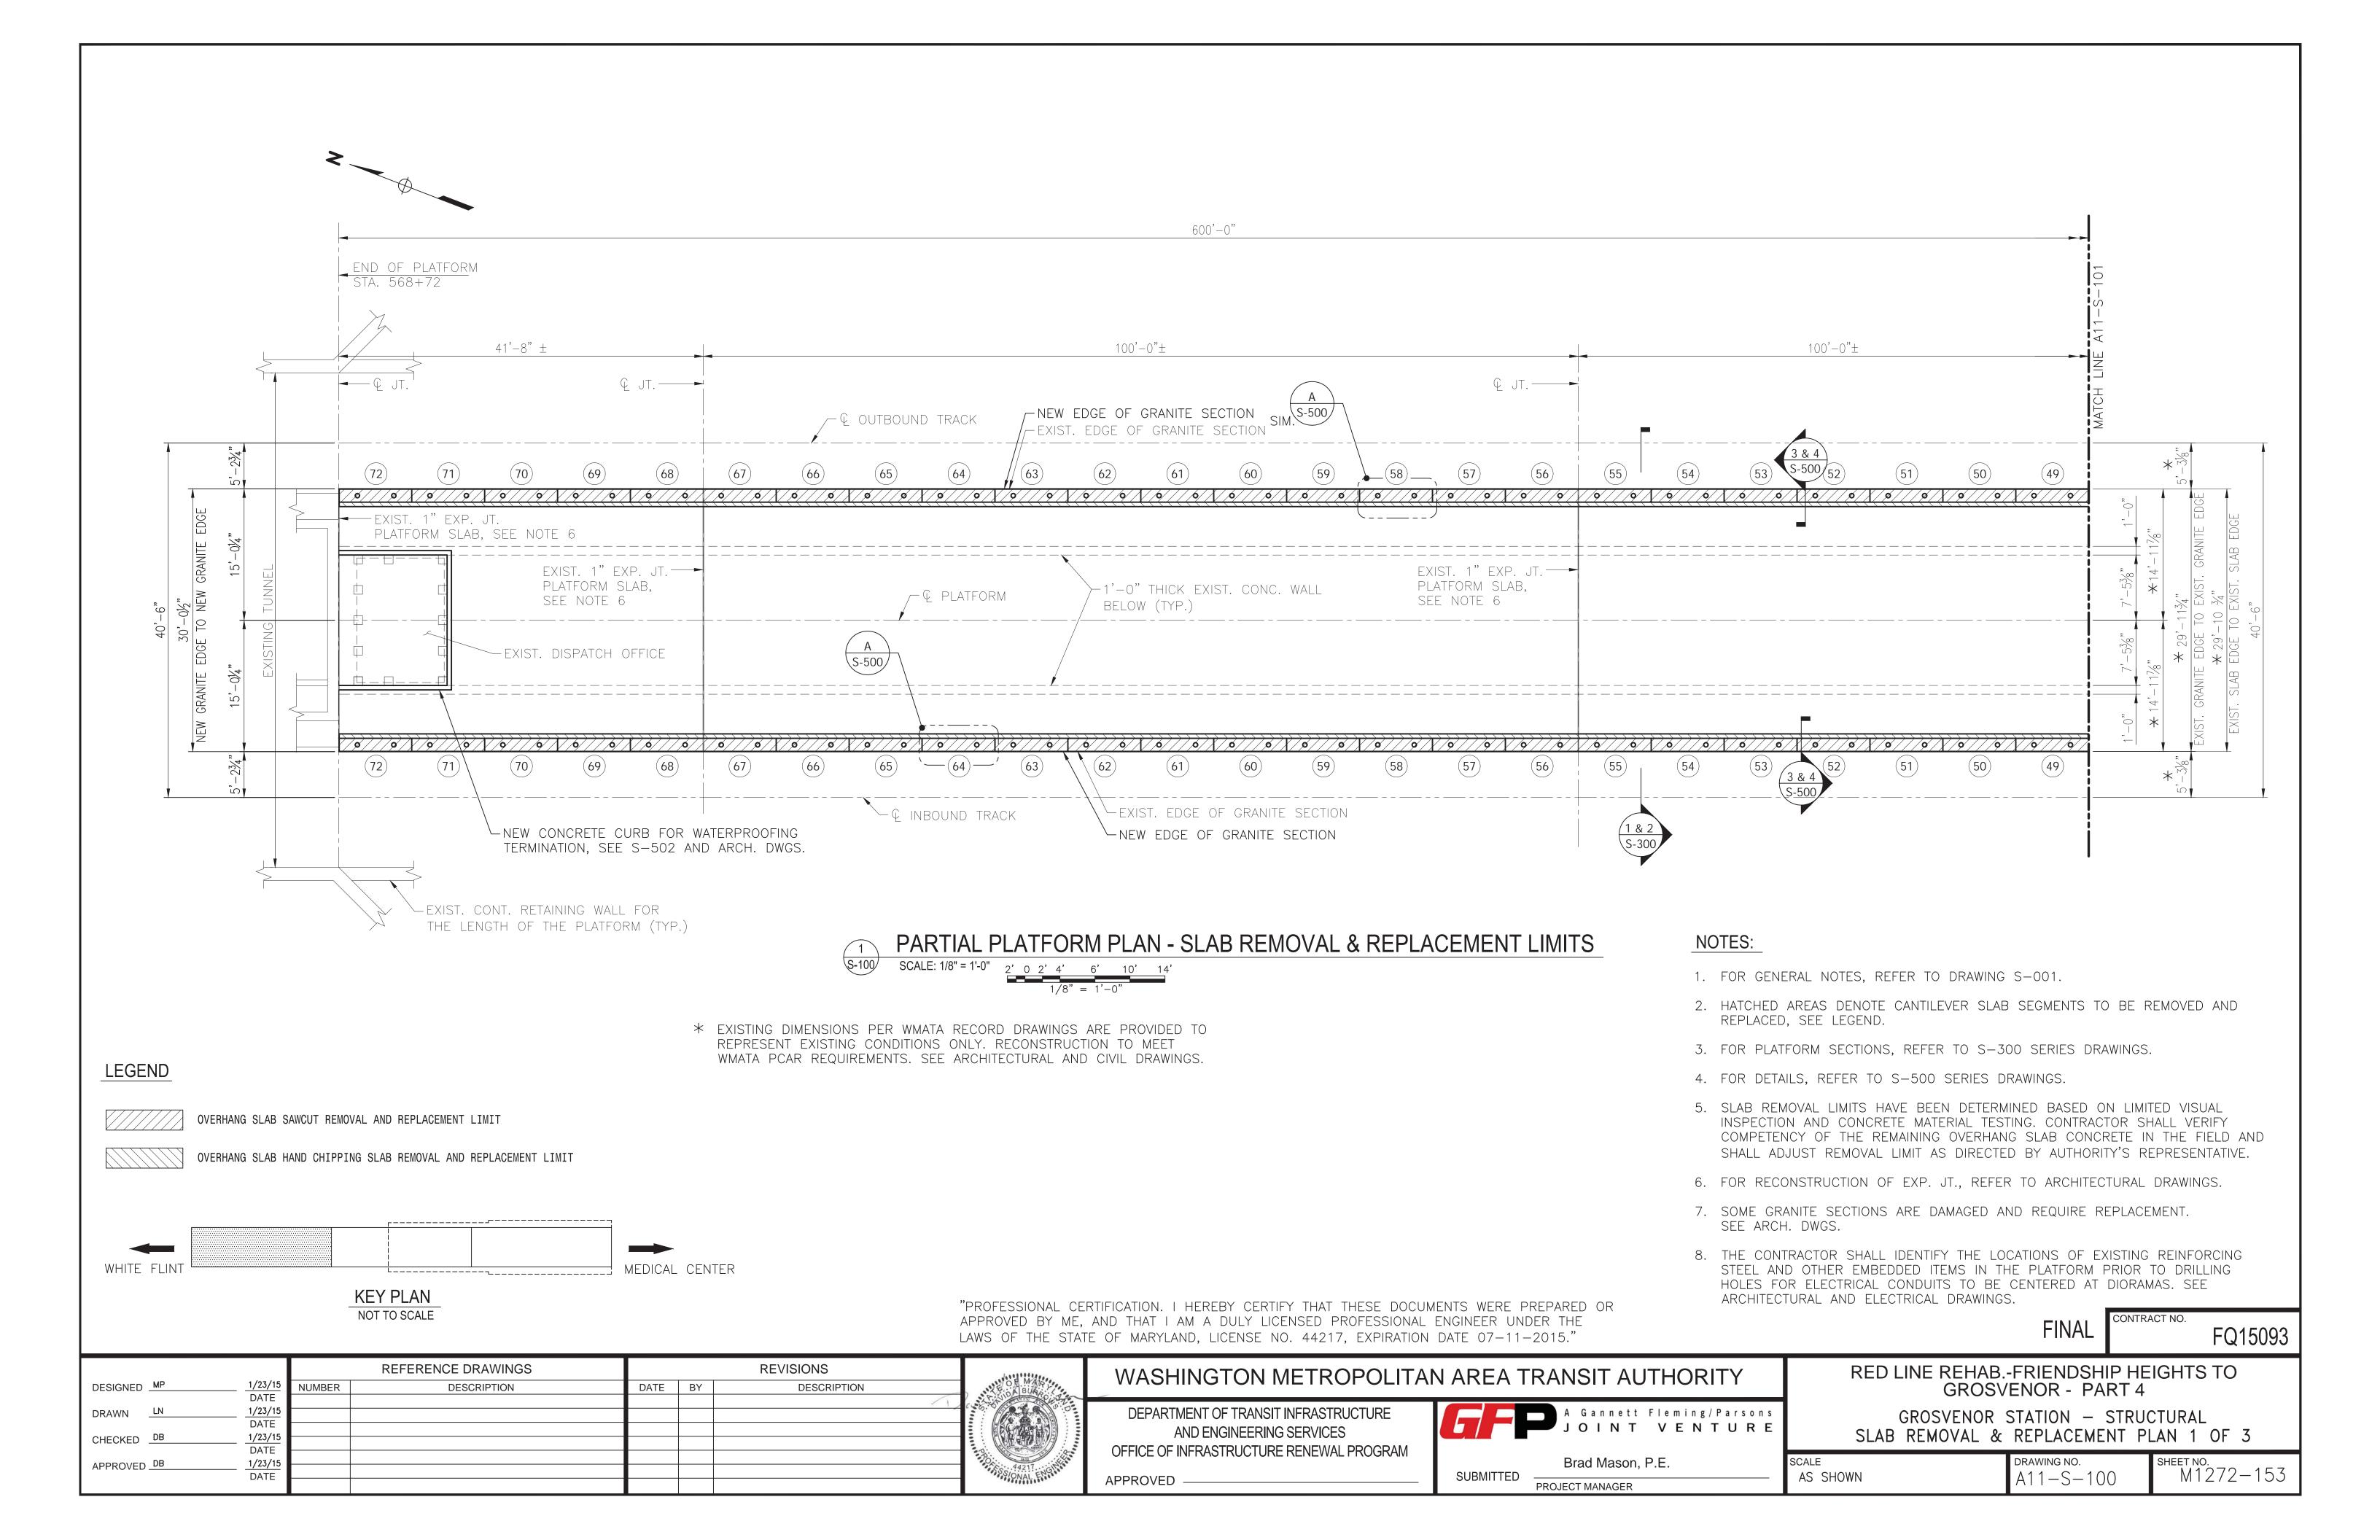

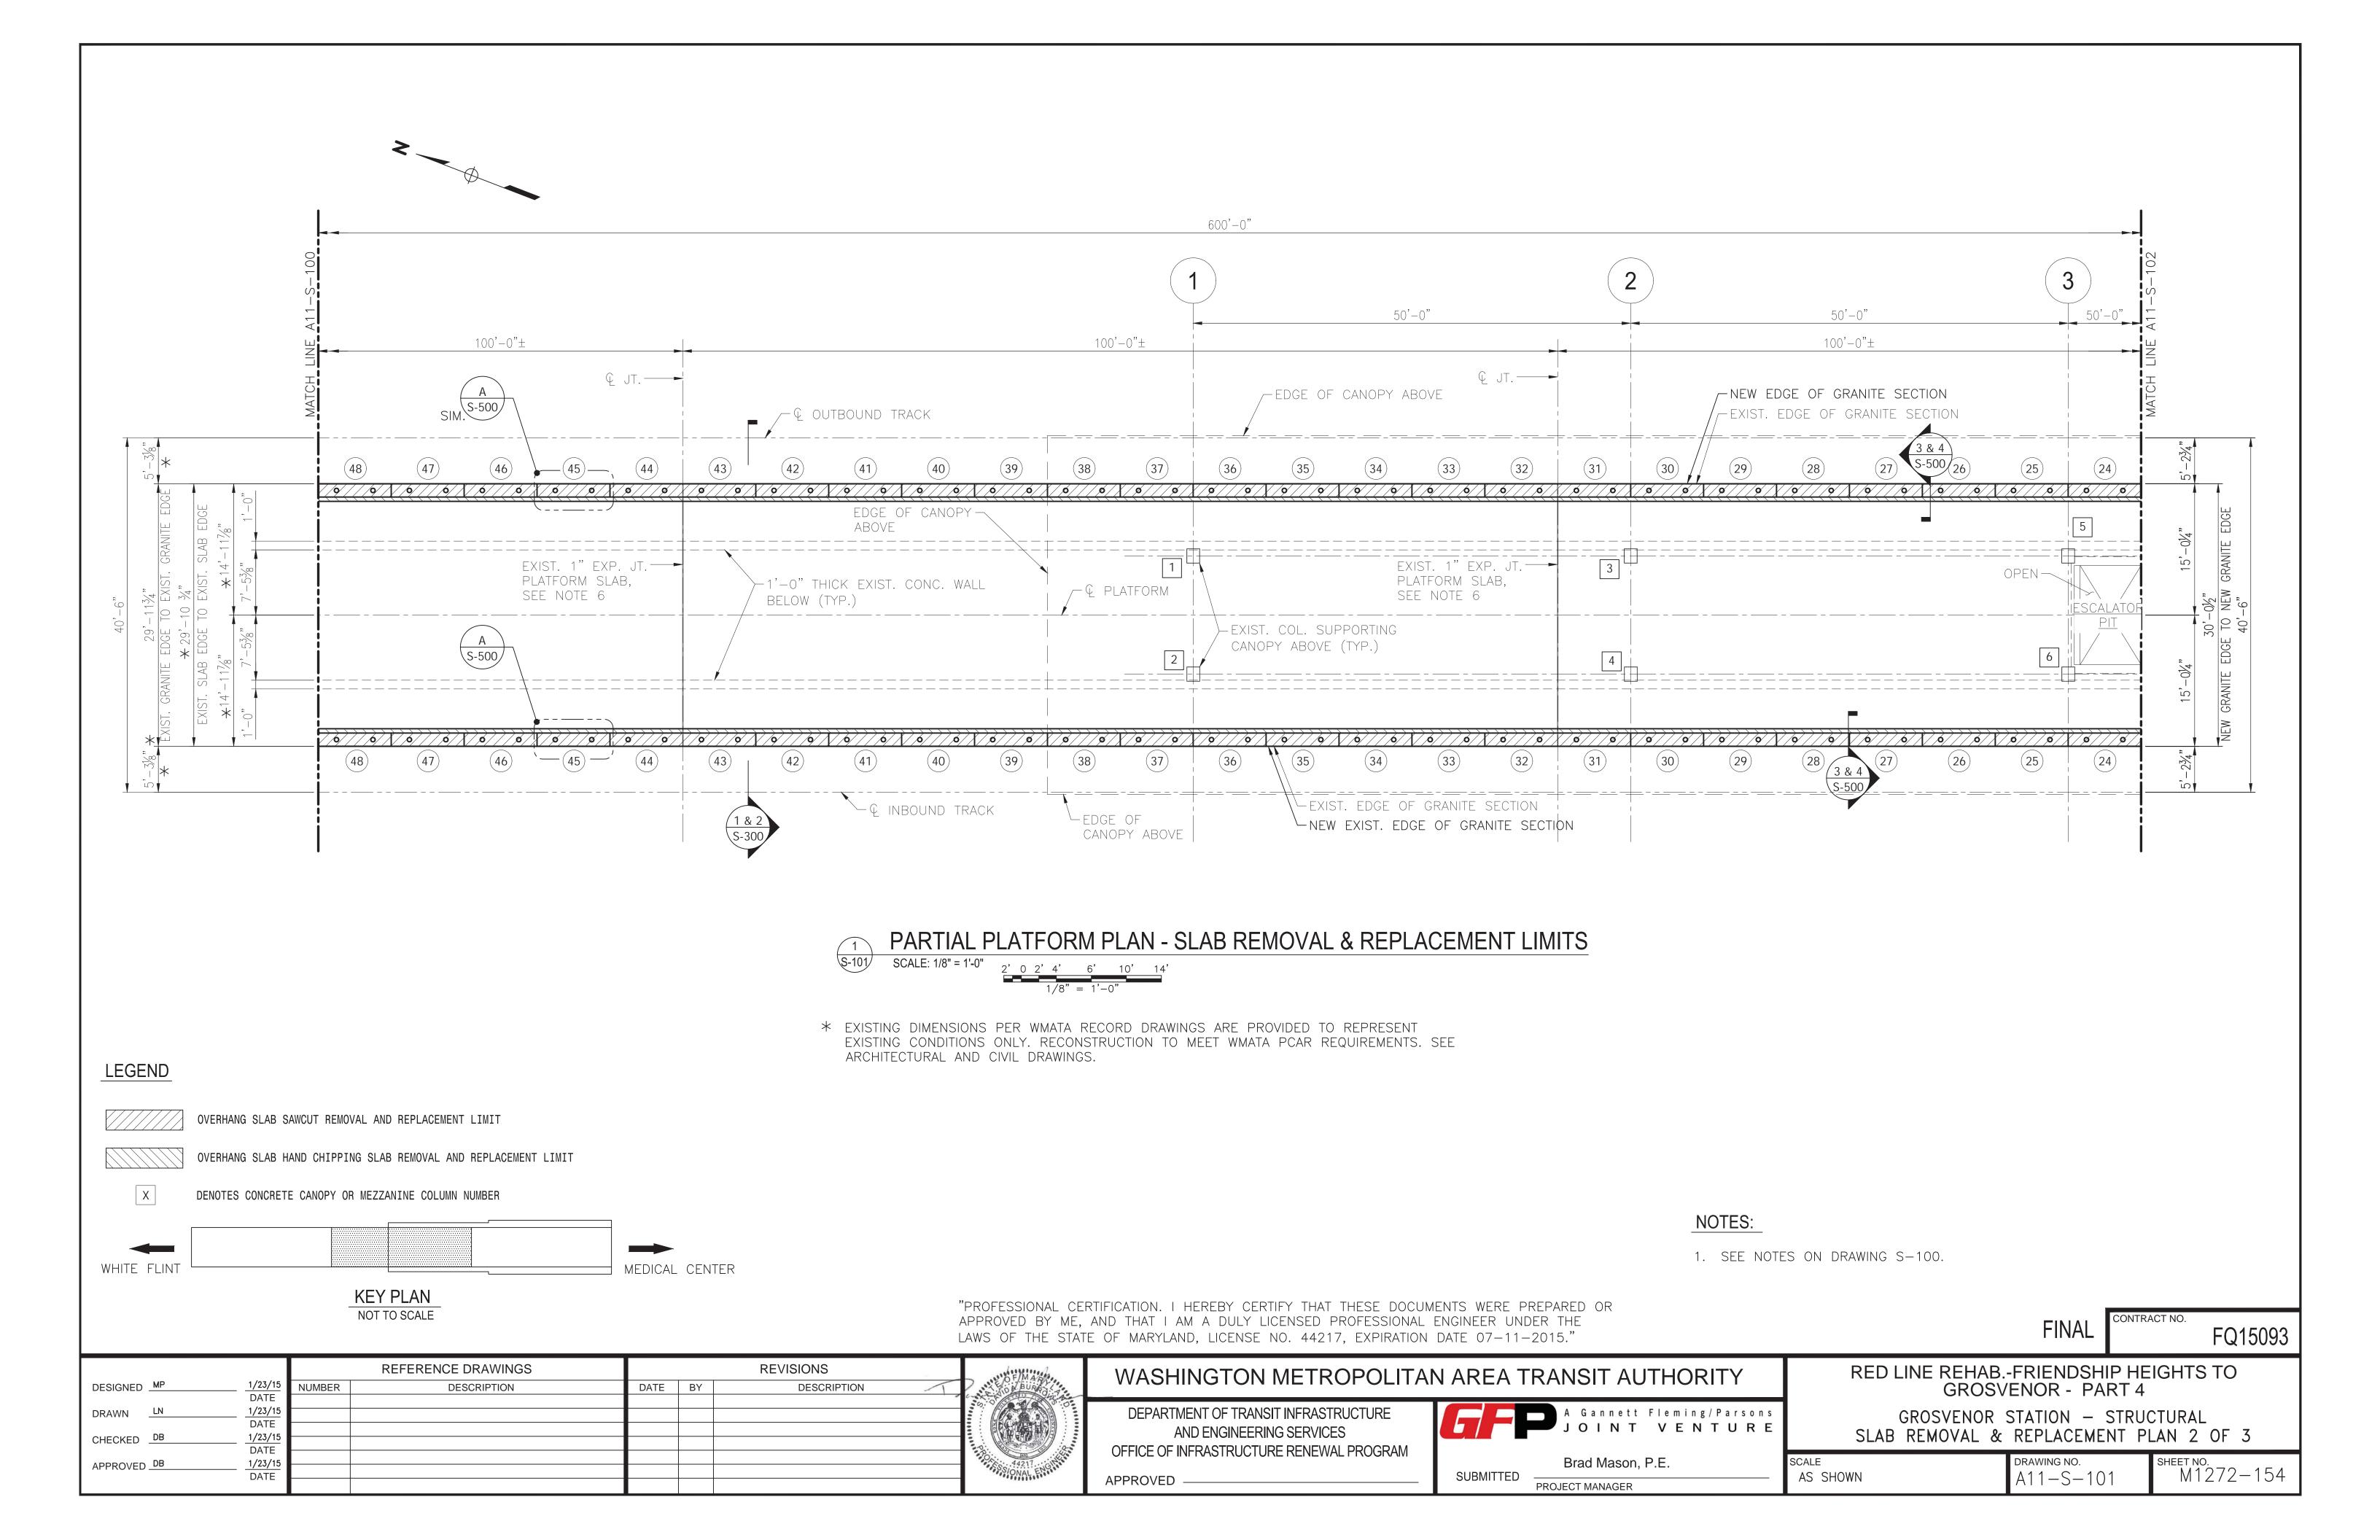

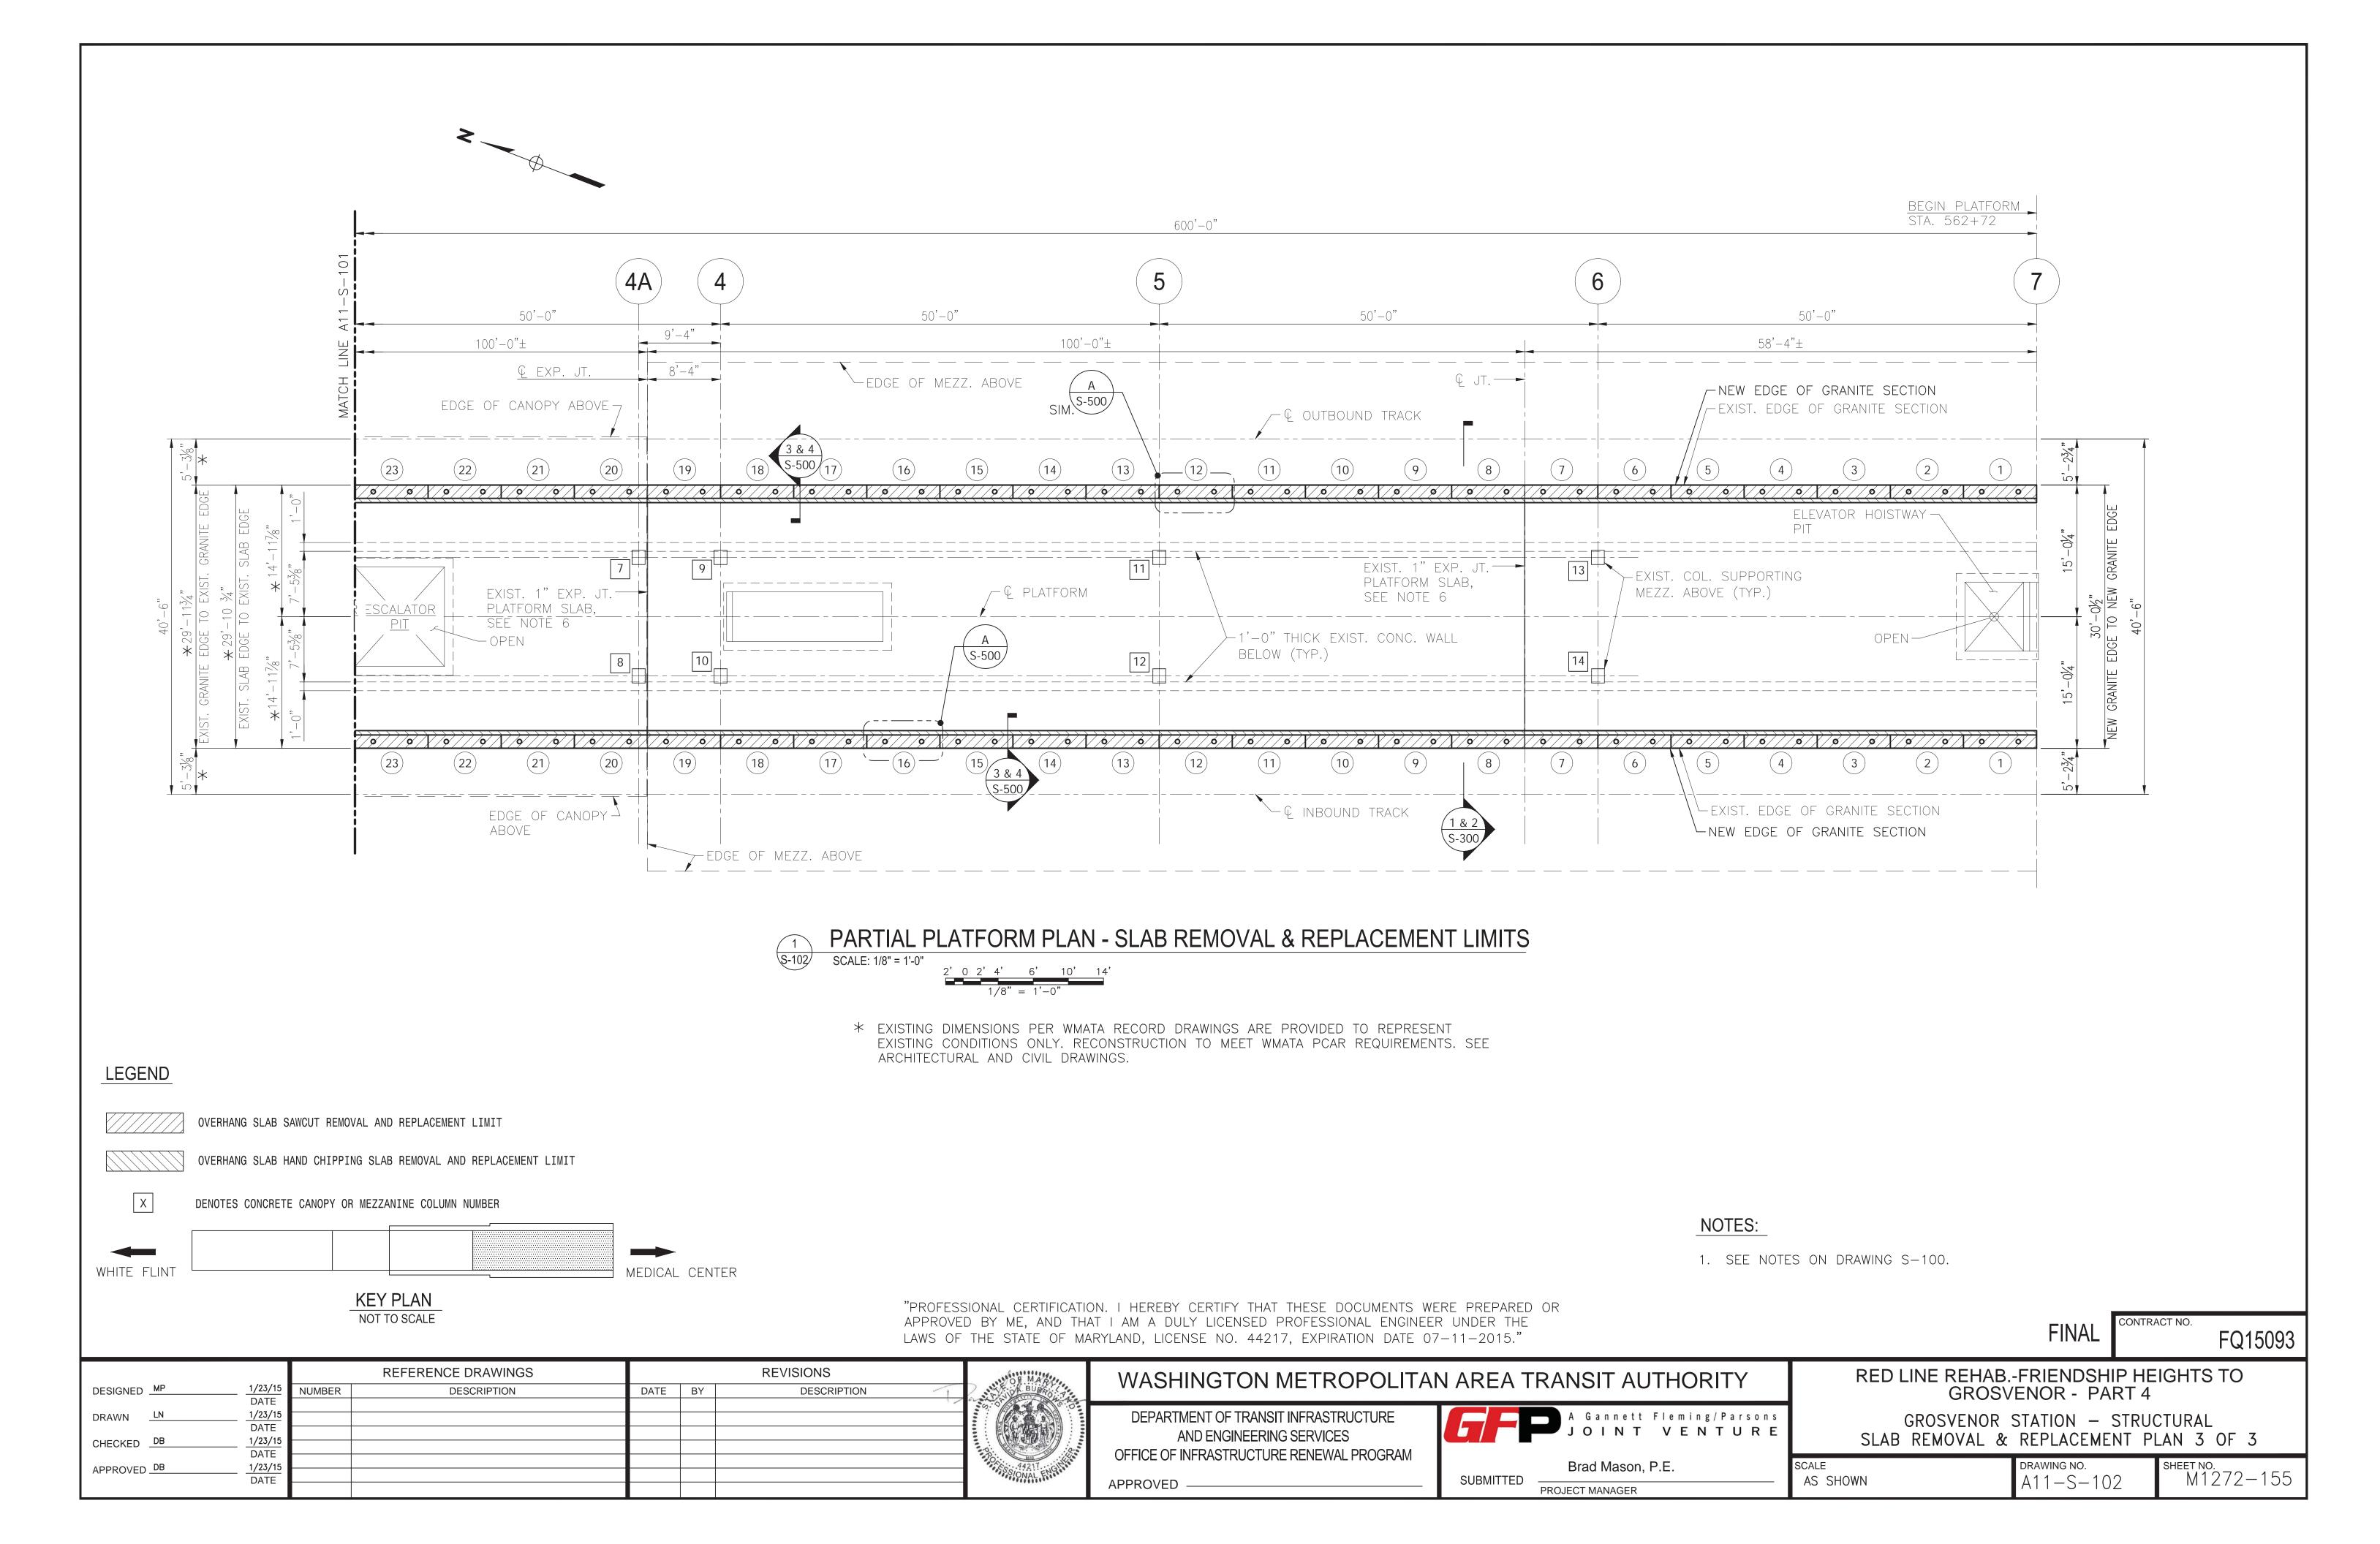

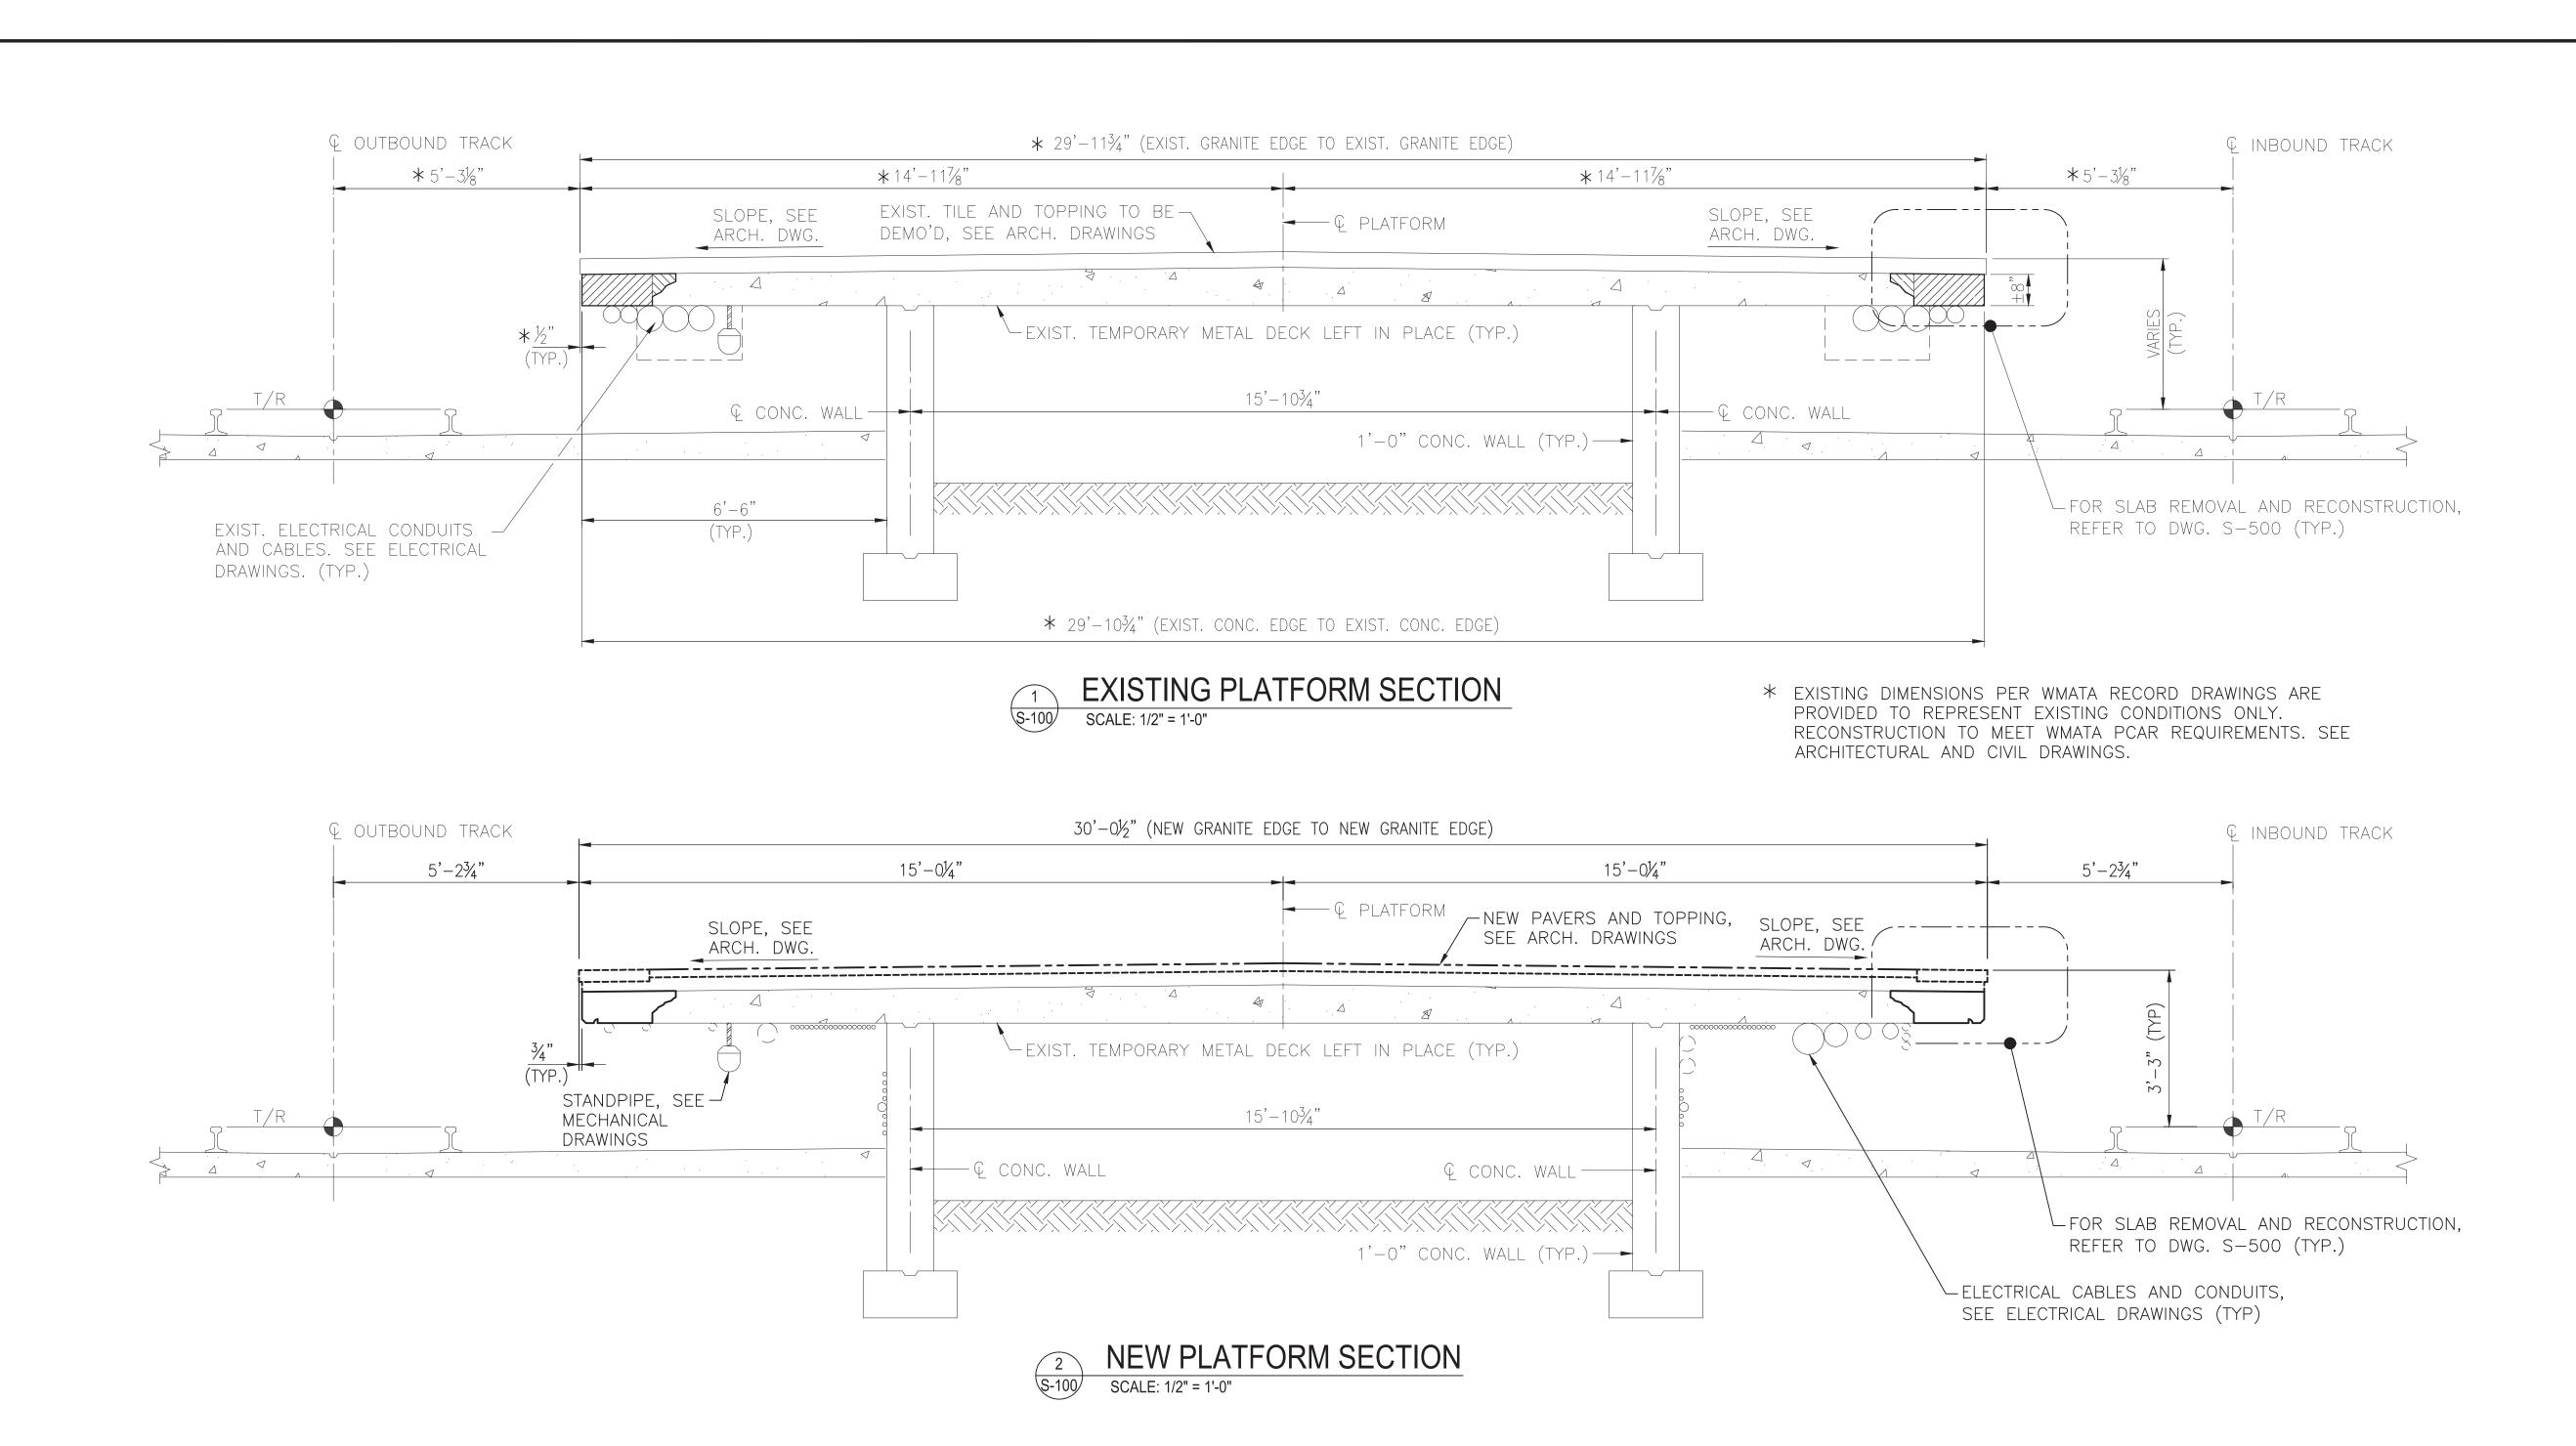

#### NOTES:

- 1. FOR GENERAL NOTES, REFER TO DRAWING S-001.
- 2. FOR DETAILS, REFER TO S-500 SERIES DRAWINGS.

#### **LEGEND**

OVERHANG SLAB SAWCUT REMOVAL AND REPLACEMENT LIMIT

OVERHANG SLAB HAND CHIPPING SLAB REMOVAL AND REPLACEMENT LIMIT

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FINAL

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## WASHINGTON METROPOLITAN AREA TRANSIT AUTHORITY

DEPARTMENT OF TRANSIT INFRASTRUCTURE
AND ENGINEERING SERVICES
OFFICE OF INFRASTRUCTURE RENEWAL PROGRAM

APPROVED

| A Gannett Fleming/Parsons JOINT VENTURE |          |
|---|----------|
| Brad Mason, P.E.                        | SCA<br>^ |


PROJECT MANAGER

RED LINE REHAB.-FRIENDSHIP HEIGHTS TO GROSVENOR - PART 4


GROSVENOR STATION — STRUCTURAL PLATFORM SECTIONS

SCALE DRAWING NO.
AS SHOWN A11-S-300

SHEET NO. M1272—156

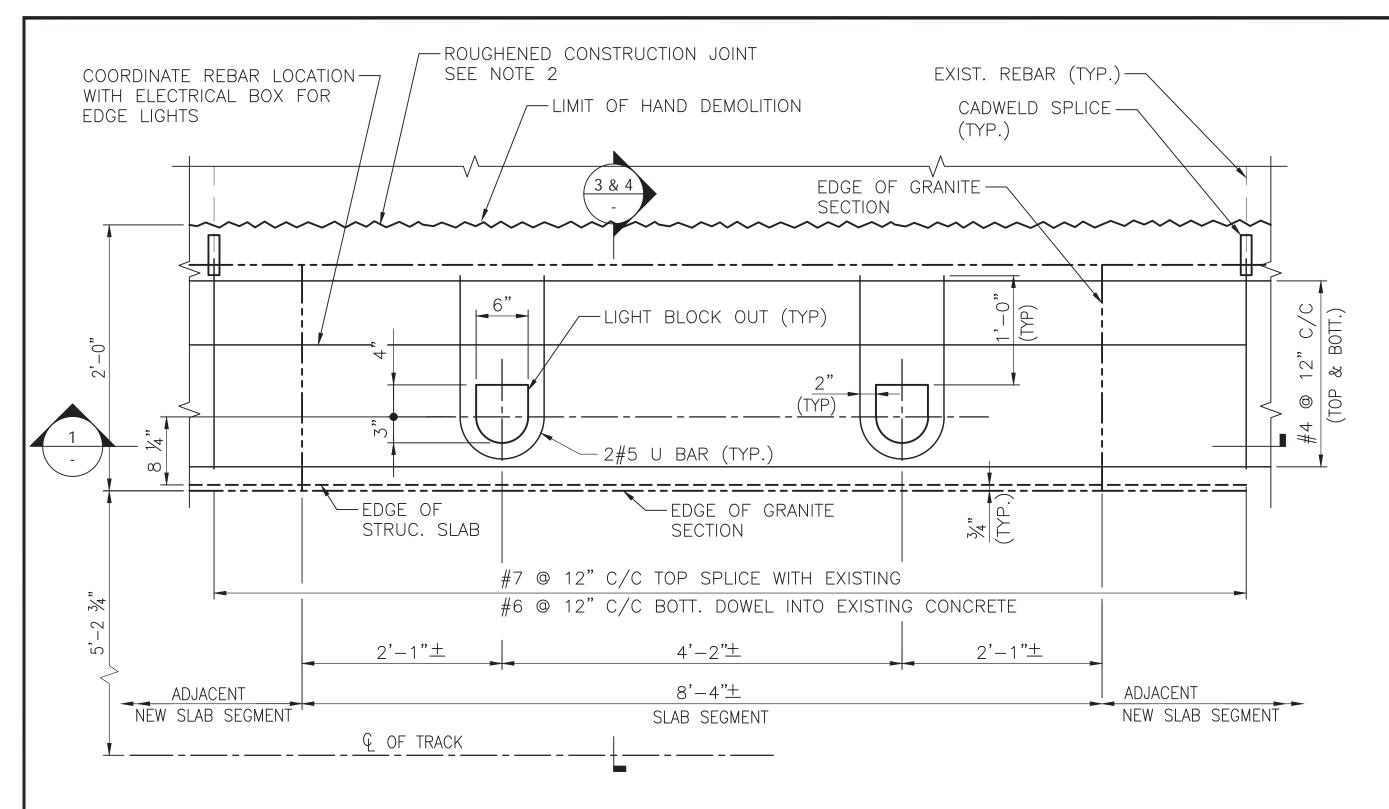

#### PARTIAL PLAN - SLAB SEGMENT S-100 SCALE: 1" = 1'-0"

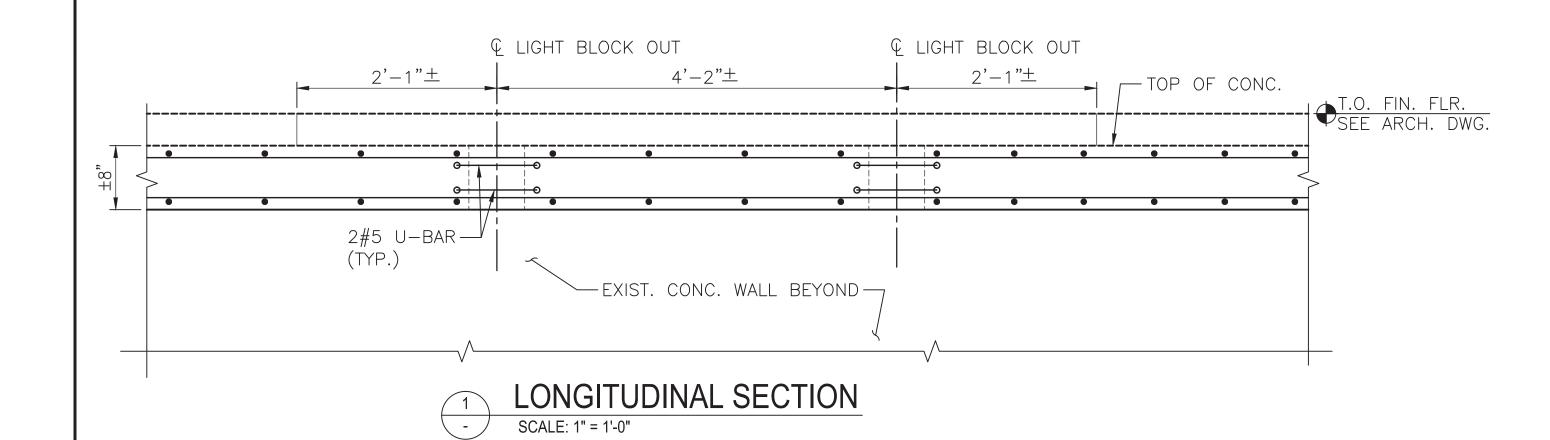

#### PLAN NOTES:

- 1. LONGITUDINAL REBAR SHALL BE CONTINUOUS THROUGH ADJACENT SLAB SEGMENTS. LAP REBAR AS REQUIRED WITH A MINIMUM 1'-8" LAP LENGTH, UNLESS OTHERWISE NOTED.
- 2. THE INTERFACE BETWEEN CONSTRUCTION JOINTS SHALL BE ROUGHENED TO A FULL AMPLITUDE OF 4" AS PER ACI 318-11 AND SHALL BE BONDED WITH APPROVED BONDING AGENT. REFER ALSO TO CONC. SPECIFICATIONS.
- 3. VERIFY LOCATIONS OF EXISTING LIGHT BLOCK-OUTS IN FIELD PRIOR TO DEMOLITION. SPACING OF LIGHT BLOCK OUTS MAY BE ADJUSTED IN FIELD IF REQUIRED.

## SECTION NOTES:

- 1. TOP & BOTTOM OF NEW SLAB SECTION SHALL MATCH EXISTING
- 2. ADJUST LOCATIONS OF THE LIGHT OPENINGS AS REQUIRED TO MATCH HOLES IN SALVAGED GRANITE SECTIONS.
- 3. PROVIDE 34" MIN. COVER TO CADWELD SPLICE. FIELD BEND EXIST. REBARS AS REQUIRED TO MAINTAIN MIN. 34" CLEAR COVER.
- 4. THE EXTENT OF HAND DEMOLITION SHALL BE DETERMINED IN THE FIELD BUT SHALL NOT BE LESS THAN 3" BELOW TOP OF EXISTING CONCRETE SLAB.
- 5. FOR CROSS SLOPE AND LONGITUDINAL SLOPES OF THE ARCH. FINISH, REFER TO ARCH. DWG.
- 6. CONTRACTOR SHALL IDENTIFY THE LOCATIONS OF EXISTING REINFORCING STEEL AND OTHER EMBEDDED ITEMS IN THE PLATFORM PRIOR TO DRILLING HOLES TO GROUT IN NEW REINFORCING STEEL. DO NOT DAMAGE EXISTING REINFORCEMENT.

# — EXIST. CONC. WALL

## DRAWING NOTES:

1. FOR LIMIT OF PLATFORM SLAB REPLACEMENT, SEE PLANS IN S-100 TO S-102.

FOR OVERALL ARCH. FIN. DEMO & -

#4@12" O.C.

1'-6"

EXIST. CONC. WALL

DWL (TYP.)

RECONSTRUCTION, REFER TO ARCH.

#7@12" O.C.—

SLAB REMOVAL

#7@12" O.C.

FOR OVERALL ARCH. FIN. DEMO & -

#4@12" O.C.-

1'-6" DWL (TYP.)

RECONSTRUCTION, REFER TO ARCH.

SCALE: 1 1/2" = 1'-0"

— 1" CLR. SLOPE

—1½" CLR.

E.W. E.F.

TOP OF EXIST. CONC. SLAB

──1" CLR.

└──1½" CLR.

#4@12" O.C.—

#4 @12" O.C.—

E.W. E.F.

TOP OF FIN. FLR.

SLOPE


#4 @12" O.C.

2. FOR GENERAL NOTES, REFER DWG. S-001.

SCALE: 1 1/2" = 1'-0"

3. ALL REBAR IN PROPOSED SLAB RECONSTRUCTION AREA SHALL BE EPOXY COATED, U.O.N.

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RED LINE REHAB.-FRIENDSHIP HEIGHTS TO

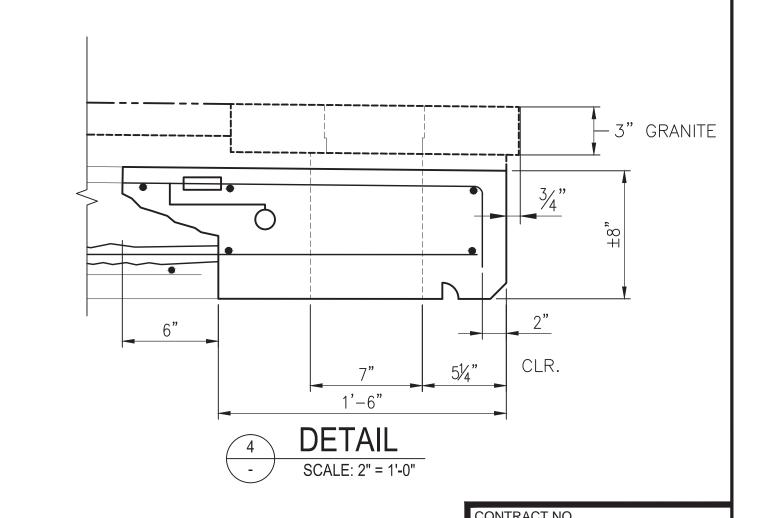GROSVENOR - PART 4

DRIP EDGE -

SLAB RECONSTRUCTION

REFERENCE DRAWINGS REVISIONS DESIGNED MP DESCRIPTION NUMBER DATE BY DESCRIPTION DRAWN LN 1/23/15 CHECKED DB DATE 1/23/15 APPROVED DB DATE



DEPARTMENT OF TRANSIT INFRASTRUCTURE AND ENGINEERING SERVICES OFFICE OF INFRASTRUCTURE RENEWAL PROGRAM

**APPROVED** 



GROSVENOR STATION - STRUCTURAL SLAB REPAIR DETAILS

A11-S-500 AS SHOWN

REMOVE & SALVAGE EXIST. GRANITE -

1'-6"

SAW CUT A WIDTH OF 1'-6" STRUCT. SLAB

INCLUDING EXIST. REBAR

- CADWELD SPLICE

—#4@12"O.C.

--- SACRIFICIAL ANODE ON

-NEW CONCRETE SLAB, SEE ALSO DETAIL 4

5'-2 <u>¾" TO</u>

€ TRACK,

2'-0" O.C. SEE

SPECIFICATION

DESIGN T/R

SECTION, SEE ARCH. DWG. (TYP.)

#4@12" O.C. — #6@12" O.C. —

REFER TO ELECTRICAL DWG.

FOR UNDERHUNG CONDUIT RELOCATION, -

ROUGHENED CONST. JT.

→ 4" MAX. •

m = (SEE NOTE 4)1

1'-2"

LIGHT FIXTURE OPENING -

BEYOND (TYP.)

MATCH THE SIZE & SPACING

OF THE EXIST. REBAR

REBAR SIZE & SPACING TO -

W/ BONDING AGENT

#6@12" O.C.—

EMBED REBAR INTO EXIST. SLAB-

USING NON-SHRINK GROUT

CAREFULLY SAWCUT, DO NOT CUT OR


DAMAGE EXISTING REINFORCING, AND CHIP CONC. SLAB BY HAND SUFFICIENT

TO INSTALL CADWELD SPLICE


M1272-157

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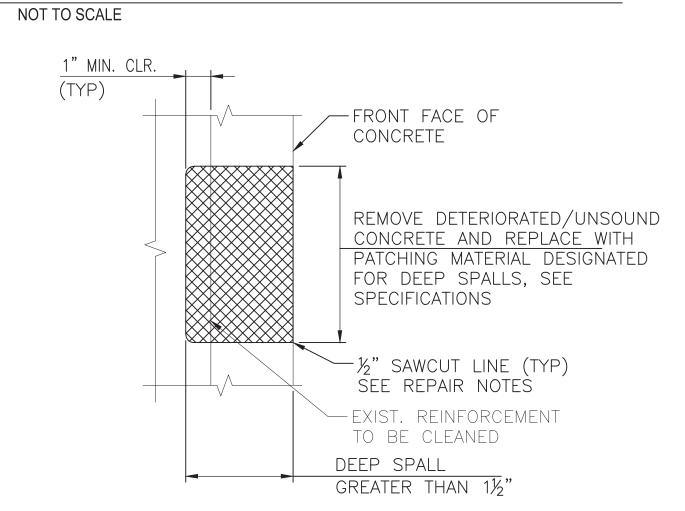
Brad Mason, P.E. SUBMITTED PROJECT MANAGER

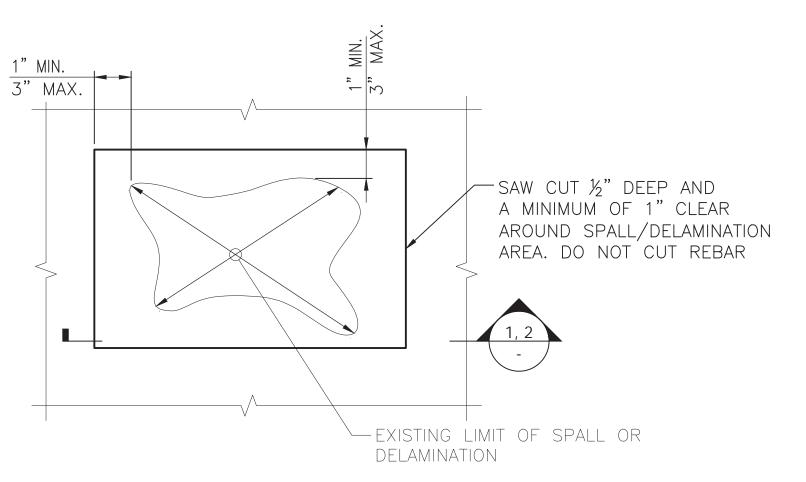

## TYPE 3 & TYPE 4 SPALL REPAIR - PLAN OR ELEVATION (HORIZONTAL, VERTICAL, OR OVERHEAD SURFACE OF CONCRETE)

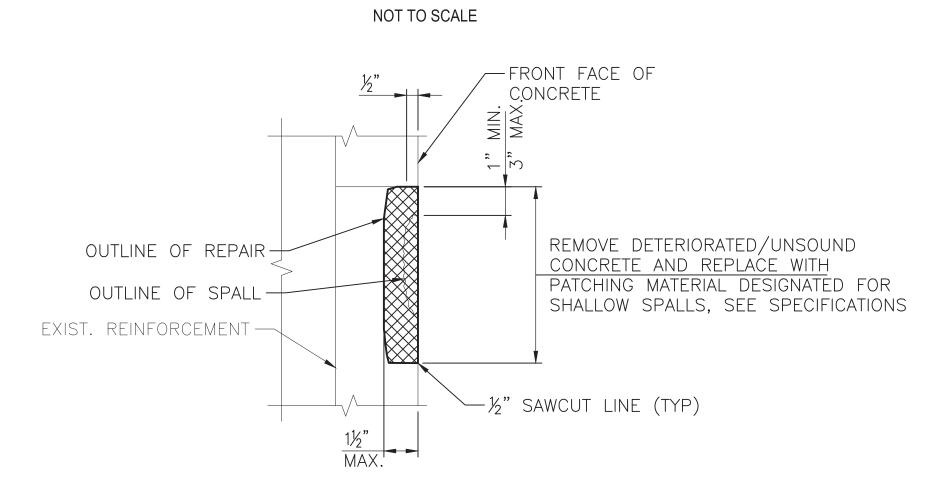

## SECTION - TYPE 3 SHALLOW SPALL REPAIR









CONCRETE SPALL REPAIR DETAIL

#### **CONCRETE REPAIR NOTES:**

- 1. THE A.R. AND THE CONTRACTOR SHALL JOINTLY INSPECT EACH ITEM TO BE REPAIRED. THE LOCATION AND EXTENT OF EACH TYPE OF REPAIR SHALL BE DETERMINED BY THE A.R. PRIOR TO THE START OF REPAIR WORK.
- 2. CONCRETE REPAIRS SHALL BE COMPLETED IN THE FOLLOWING ORDER: SPALL REPAIRS, CRACK REPAIR BY EPOXY INJECTION, CRACK SURFACE ROUT AND SEAL.
- 3. ALL EXISTING DIMENSIONS SHOWN ARE APPROXIMATE AND SHALL BE FIELD VERIFIED BY THE CONTRACTOR.
- 4. FOLLOW MANUFACTURERS RECOMMENDATIONS FOR INSTALLATION OF GROUT MATERIAL.
- 5. SEE SPECIFICATION SECTION 03720 REPAIR OF EXISTING CONCRETE.

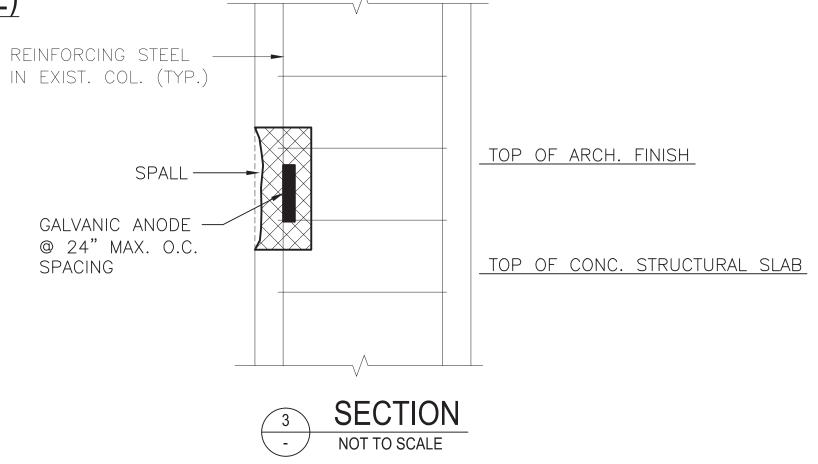


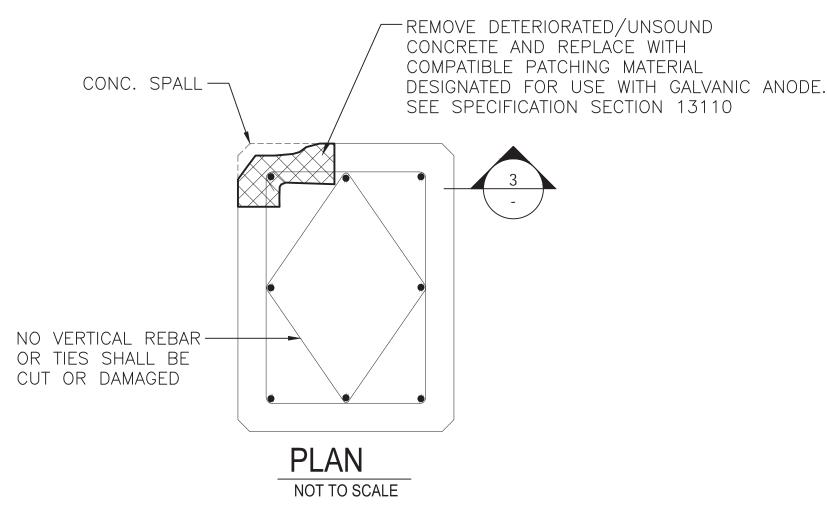

## COLUMN BASE REPAIR DETAIL

COLUMN BASES TO BE REPAIRED INCLUDE CONCRETE CANOPY COLUMN NUMBERS 2, 5, AND 6. REPAIR LOCATIONS REPRESENT CONDITIONS AT TIME OF NON-DESTRUCTIVE INSPECTION BASED ON LIMITED VISUAL SURVEY OF VISIBLE PORTIONS OF CONCRETE CANOPY BASES. SEE NOTES THIS SHEET.


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#### CRACK STEP A

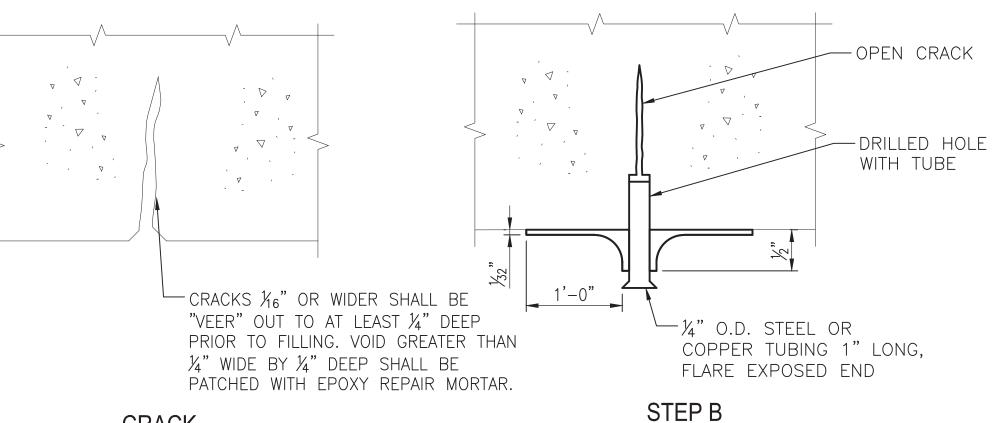CLEAN OUT CRACK WITH HAND TOOLS. HIGH PRESSURE AIR BLAST AND VACUUM CLEAN SURFACE.

DRILL HOLES FOR PORTS TO A WIDTH AND DEPTH SUFFICIENT TO ASSURE A SNUG FIT OF THE PORT. VACUUM OUT DEBRIS. INSERT PORT AND SEAL SURFACE OF CRACK WITH EPOXY SURFACE SEALANT. SEAL SHALL EXTEND ABOVE CONCRETE SURFACE A MINIMUM OF  $\frac{1}{3}$ 2" AND EXTEND A MINIMUM OF 1" TO EITHER SIDE OF CRACK. ALLOW A MINIMUM OF 6 HOURS CURING TIME BEFORE INITIATING INJECTION PROCESS.



INJECT LOW VISCOSITY INJECTION EPOXY GROUT AS DETAILED IN CONCRETE SPECIFICATION SECTION. ALLOW MINIMUM OF 6 HOURS CURING TIME. REMOVE EPOXY SURFACE SEALANT AND SEALER TO THE SATISFACTION OF THE A.R.

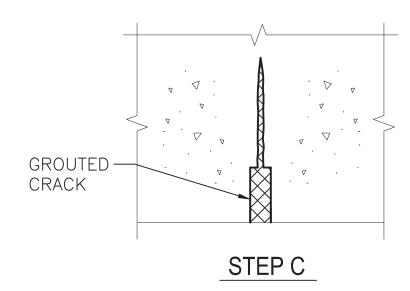- 1. PUMP EPOXY INTO FIRST PORT UNTIL EPOXY IS EVIDENT AT THE ADJACENT PORT.
- 2. ADVANCE HAND PUMP TO THE NEXT LOCATION AND INJECT EPOXY.
- 3. CONTINUE PROCESS UNTIL CRACK HAS BEEN COMPLETELY FILLED.
- 4. CUT OFF GROUT TUBE FLUSH WITH CONCRETE FACE.
- 5. PATCH OVER GROUT TUBE.
- 6. GRIND EPOXY SURFACE SEALANT SMOOTH TO SURFACE OF SLAB.
- 7. ROUT AND SEAL CRACK.

## TYPE 7 REPAIR CRACK EPOXY INJECTION

"PROFESSIONAL CERTIFICATION. I HEREBY CERTIFY THAT THESE DOCUMENTS WERE PREPARED OR APPROVED BY ME, AND THAT I AM A DULY LICENSED PROFESSIONAL ENGINEER UNDER THE LAWS OF THE STATE OF MARYLAND, LICENSE NO. 44217, EXPIRATION DATE 07-11-2015."

FQ15093

REFERENCE DRAWINGS REVISIONS DESIGNED MP NUMBER DESCRIPTION DATE BY **DESCRIPTION** 1/23/1 DRAWN LN 1/23/15 DATE CHECKED DB 1/23/15 APPROVED DB DATE



## WASHINGTON METROPOLITAN AREA TRANSIT AUTHORITY

DEPARTMENT OF TRANSIT INFRASTRUCTURE AND ENGINEERING SERVICES OFFICE OF INFRASTRUCTURE RENEWAL PROGRAM




PROJECT MANAGER

Brad Mason, P.E.

RED LINE REHAB.-FRIENDSHIP HEIGHTS TO **GROSVENOR - PART 4** 

GROSVENOR STATION - STRUCTURAL TYPICAL CONCRETE REPAIR DETAILS 1 OF 2


SCALE M1272-158 A11-S-501 AS SHOWN

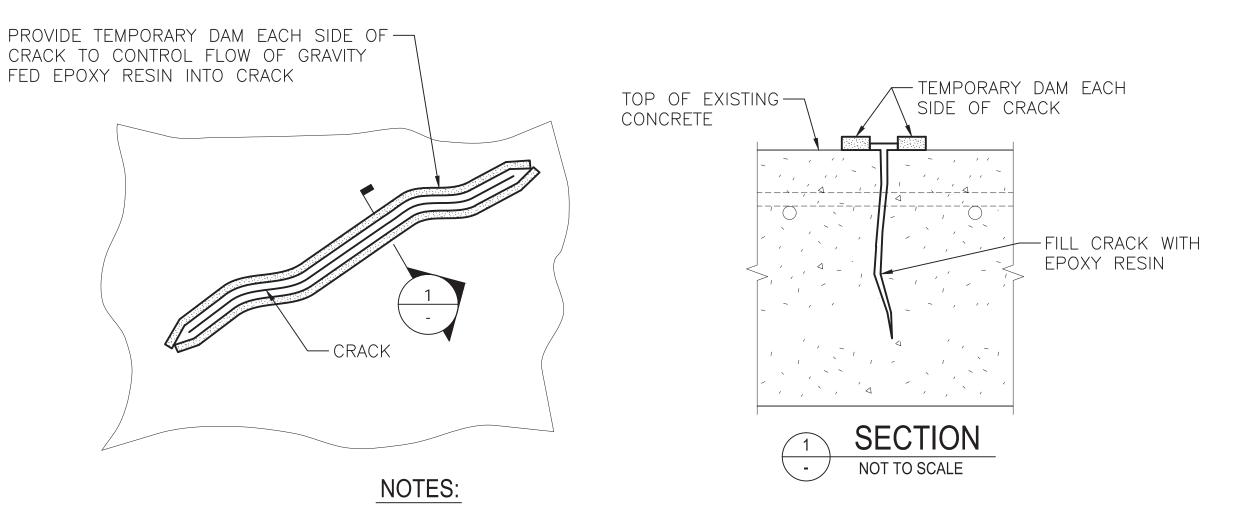

- 1. REFER TO S-501 FOR CONCRETE REPAIR NOTES.
- 2. SEAL UNDERSIDE OF SLAB PER DETAIL C ON S-501 PRIOR TO FILLING IF CRACKS REFLECT THROUGH STRUCTURAL SLAB.

## TYPE 8 REPAIR GRAVITY FED CRACK

NOT TO SCALE

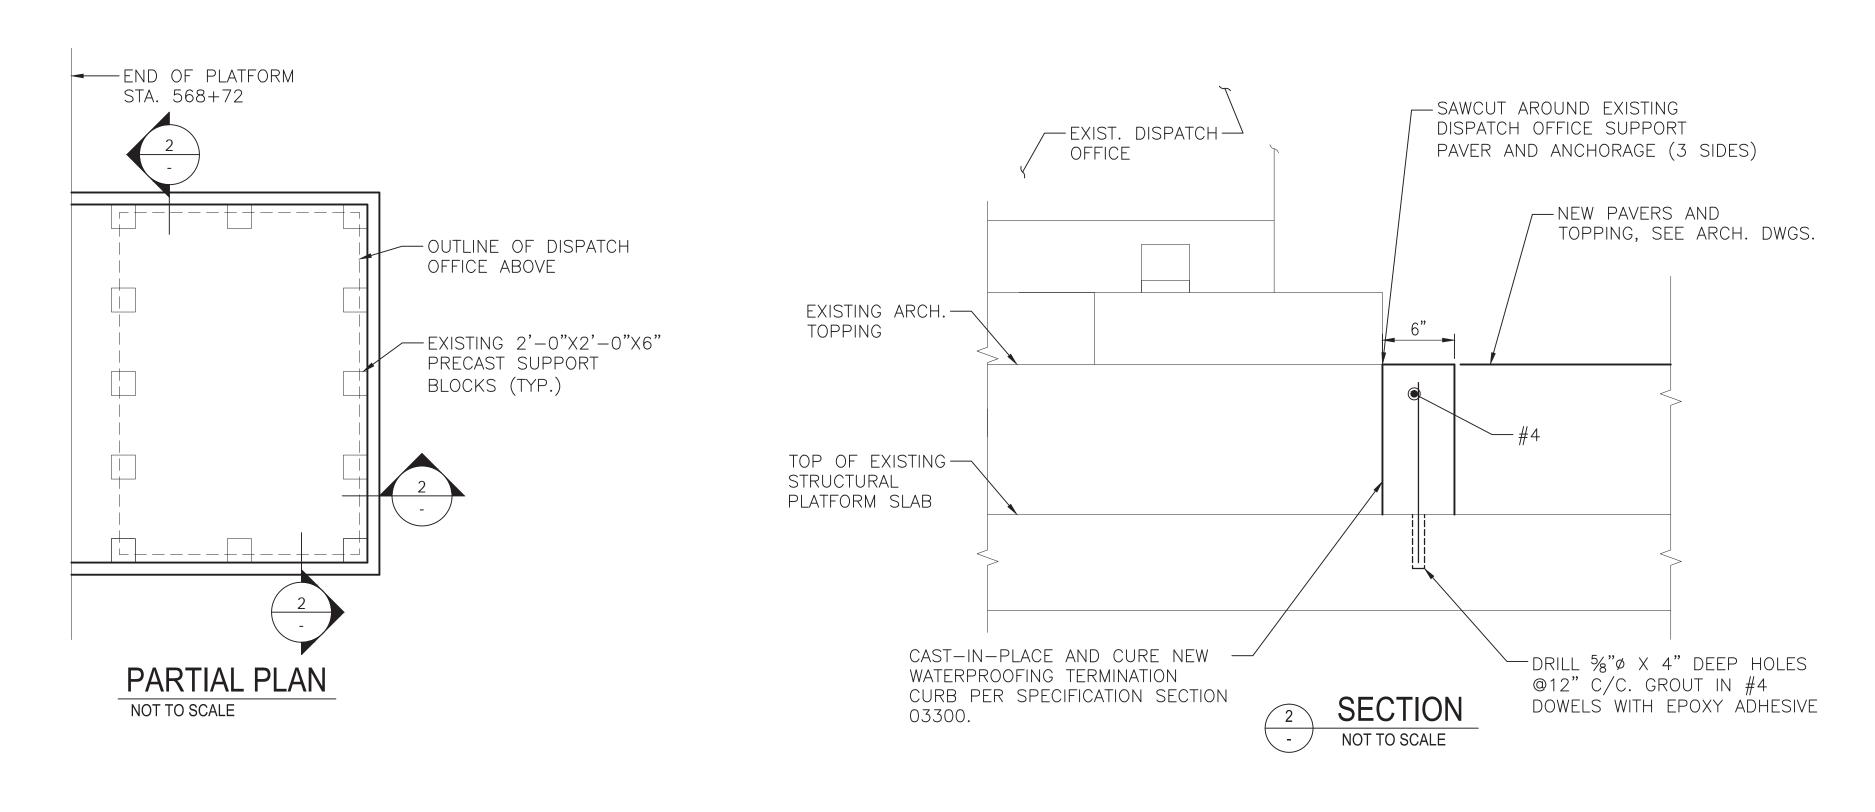

#### NOTES:

- 1. THE CONTRACTOR SHALL IDENTIFY THE LOCATIONS OF EXISTING REINFORCING STEEL AND OTHER EMBEDDED ITEMS IN THE PLATFORM PRIOR TO DRILLING HOLES TO INSTALL NEW CURB.
- 2. REFER TO ARCHITECTURAL DRAWINGS FOR WATERPROOFING AND NEW ARCHITECTURAL TOPPING DETAILS.
- 3. DISPATCH OFFICE TO REMAIN IN PLACE DURING WORK.
- 4. TOP OF CURB TO MATCH ELEVATION OF TOP OF NEW PAVERS, SEE ARCHITECTURAL DRAWINGS.

AS SHOWN

## WATERPROOFING TERMINATION CURB-DISPATCH OFFICE

NOT TO SCALE

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FINAL

A11-S-502

RED LINE REHAB.-FRIENDSHIP HEIGHTS TO

GROSVENOR - PART 4

FQ15093

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OFFICE OF INFRASTRUCTURE RENEWAL PROGRAM

APPROVED



GROSVENOR STATION — STRUCTURAL
TYPICAL CONCRETE REPAIR DETAILS 2 OF 2 AND

SUBMITTED Brad Mason, P.E.

PROJECT MANAGER

TYPICAL CONCRETE REPAIR DETAILS 2 OF 2 AND CURB

#### **GENERAL NOTES**

- 1. THE MODIFICATION TO THE EXISTING DRY STANDPIPE SYSTEM SHALL INCLUDE BUT NOT BE LIMITED TO DESIGN, CALCULATION, INSTALLATION, AND TESTING IN ACCORDANCE WITH THE LATEST EDITION OF NFPA 14, NFPA 130, WMATA AND LOCAL FIRE MARSHAL REQUIREMENTS.
- 2. THE CONTRACTOR SHALL COORDINATE HIS WORK WITH ALL EXISTING & NEW STRUCTURAL MEMBERS AND SERVICES TO ELIMINATE ANY INTERFERENCE IN THE FIELD.
- 3. THE CONTRACTOR SHALL VERIFY ALL DIMENSIONS IN THE FIELD AND SHALL REPORT ANY DISCREPANCIES TO THE AUTHORITY'S REPRESENTATIVE (AR) FOR CLARIFICATION PRIOR TO STARTING ANY WORK.
- 4. ALL WORK SHALL BE CARRIED OUT WITHOUT CAUSING ANY DISRUPTION OF TRAIN OPERATIONS, HVAC, ELECTRICAL OR PLUMBING SERVICES AND WITH THE APPROVAL OF WMATA.
- 5. PROVIDE APPROPRIATE BARRIERS APPROVED BY THE AUTHORITY'S REPRESENTATIVE (AR) TO ISOLATE WORK AREAS FROM THE PUBLIC.

#### LEGEND AND ABBREVIATIONS

- POINT OF DEMOLITION
- POINT OF CONNECTION
- ----- DRY STANDPIPE, EXISTING TO REMAIN
- DRY STANDPIPE, EXISTING TO BE DEMOLISHED
- DRY STANDPIPE, NEW WORK

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APPROVED -

**REVISIONS** REFERENCE DRAWINGS DESIGNED DPR 07/14 DATE DESCRIPTION NUMBER DATE BY DESCRIPTION 07/14 DATE DRAWN DPR CHECKED CMR

APPROVED JP



## WASHINGTON METROPOLITAN AREA TRANSIT AUTHORITY

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DEPARTMENT OF TRANSIT INFRASTRUCTURE AND ENGINEERING SERVICES OFFICE OF INFRASTRUCTURE RENEWAL PROGRAM



RED LINE REHAB.-FRIENDSHIP HEIGHTS TO GROSVENOR - PART 4

GROSVENOR STATION - MECHANICAL GENERAL NOTES AND ABBREVIATIONS


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SCALE

PROJECT MANAGER

NONE A11-M-001M1272-160




PARTIAL PLATFORM PLAN

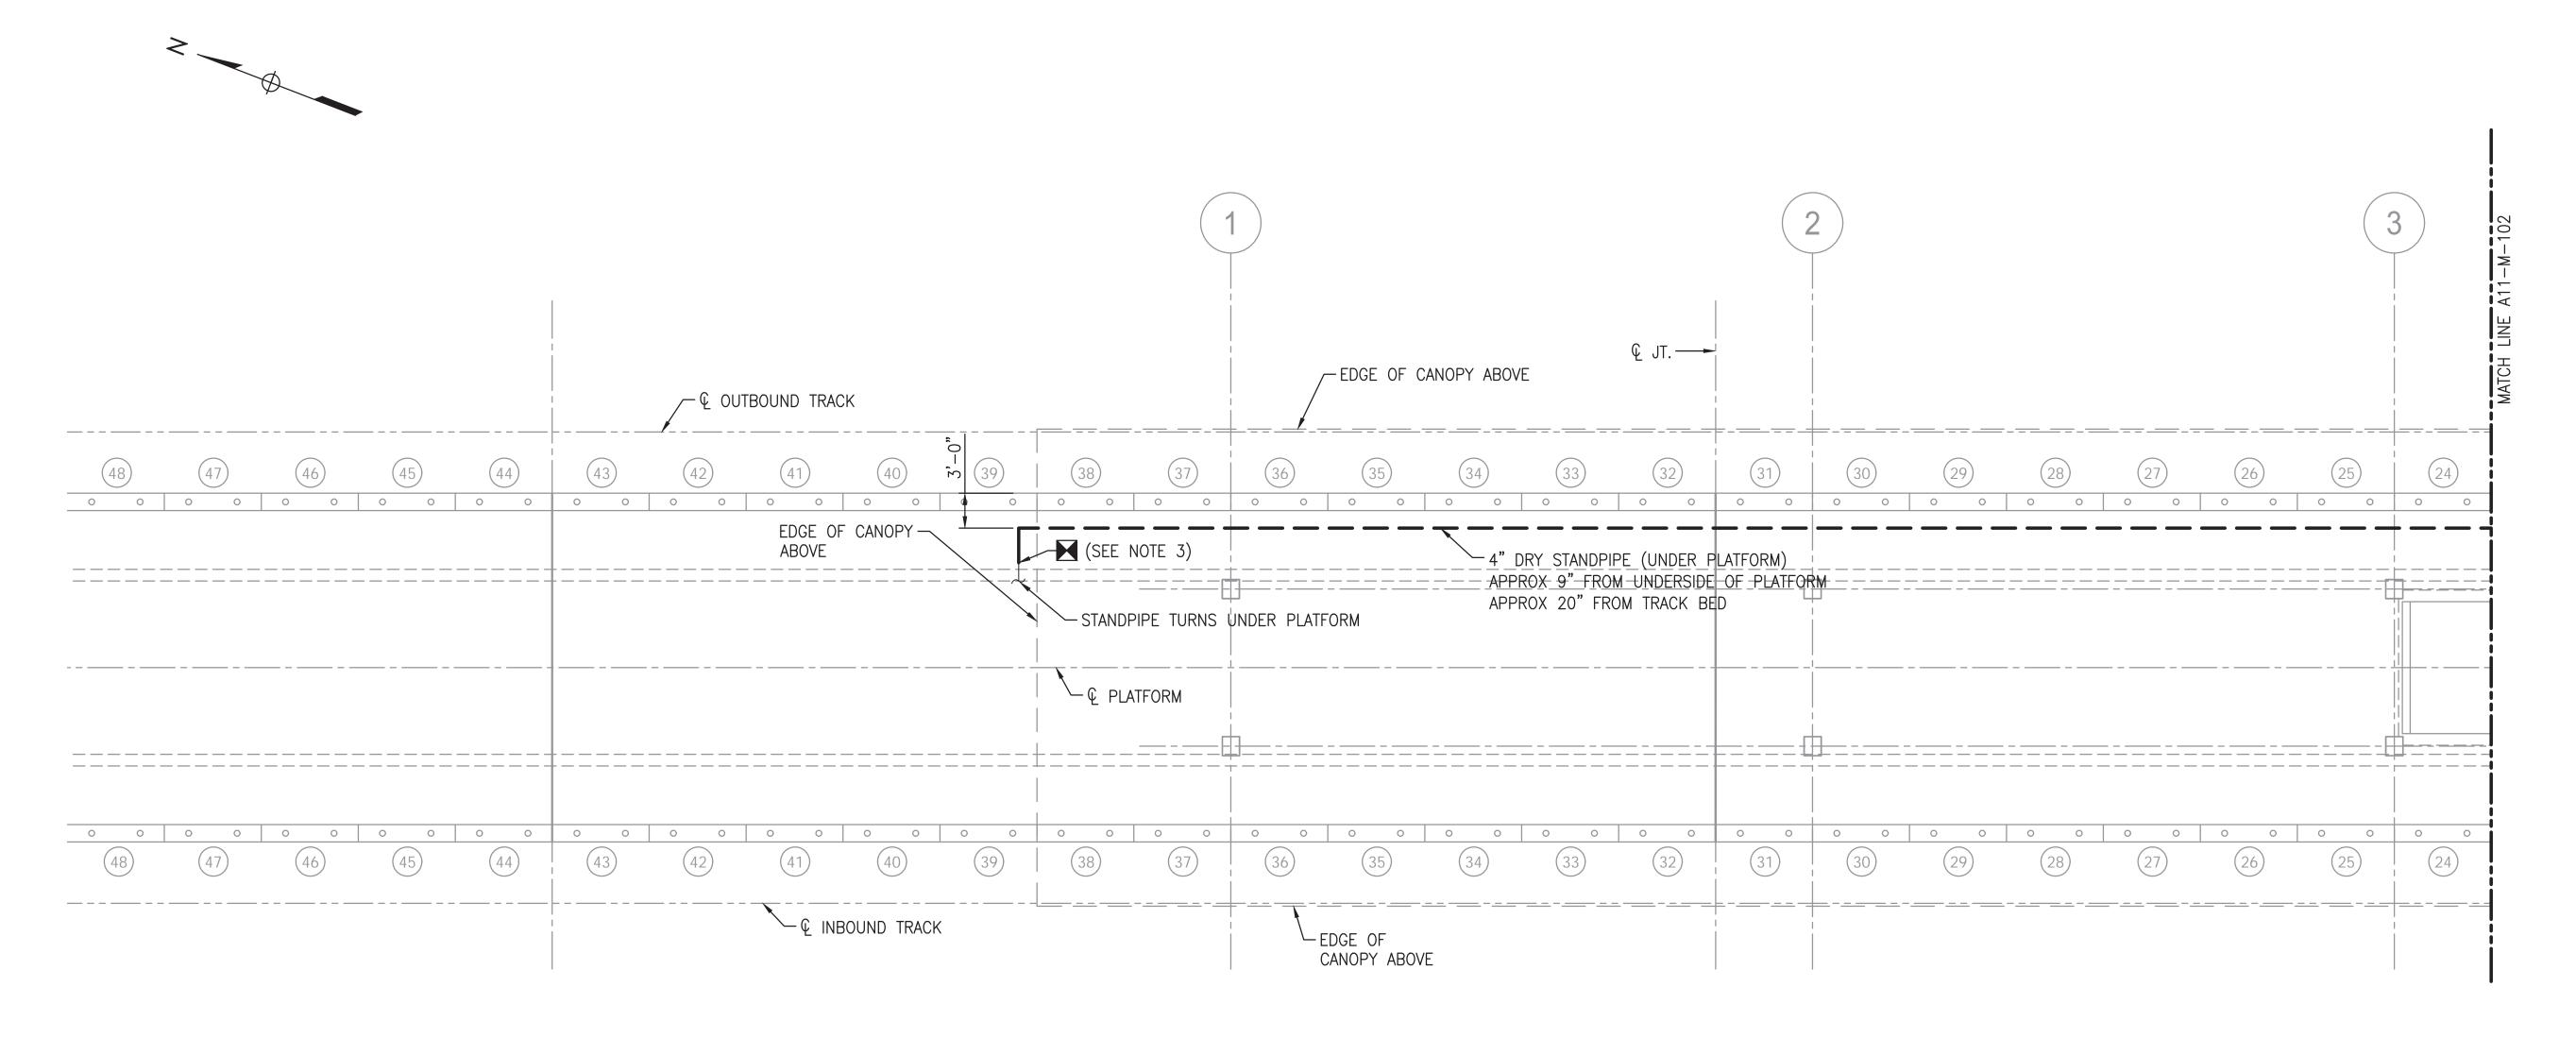SCALE: 1/8" = 1'-0"

#### NOTES:

- 1. FOR GENERAL NOTES, REFER TO DRAWING M-001.
- 2. FOR DETAILS, REFER TO M-500 SERIES DRAWINGS.
- 3. LEAVE 1' OF PIPE REMAINING PRIOR TO PENETRATION TO ALLOW FOR POINT OF RECONNECTION.

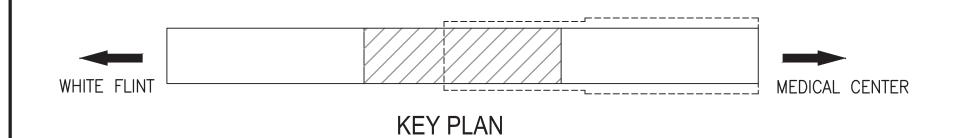

NOT TO SCALE

PROFESSIONAL CERTIFICATION. I HEREBY CERTIFY THAT THESE DOCUMENTS WERE PREPARED OR APPROVED BY ME, AND THAT I AM A DULY LICENSED PROFESSIONAL ENGINEER UNDER THE LAWS OF THE STATE OF MARYLAND, LICENSE NO. 23210, EXPIRATION DATE 06-30-2016.

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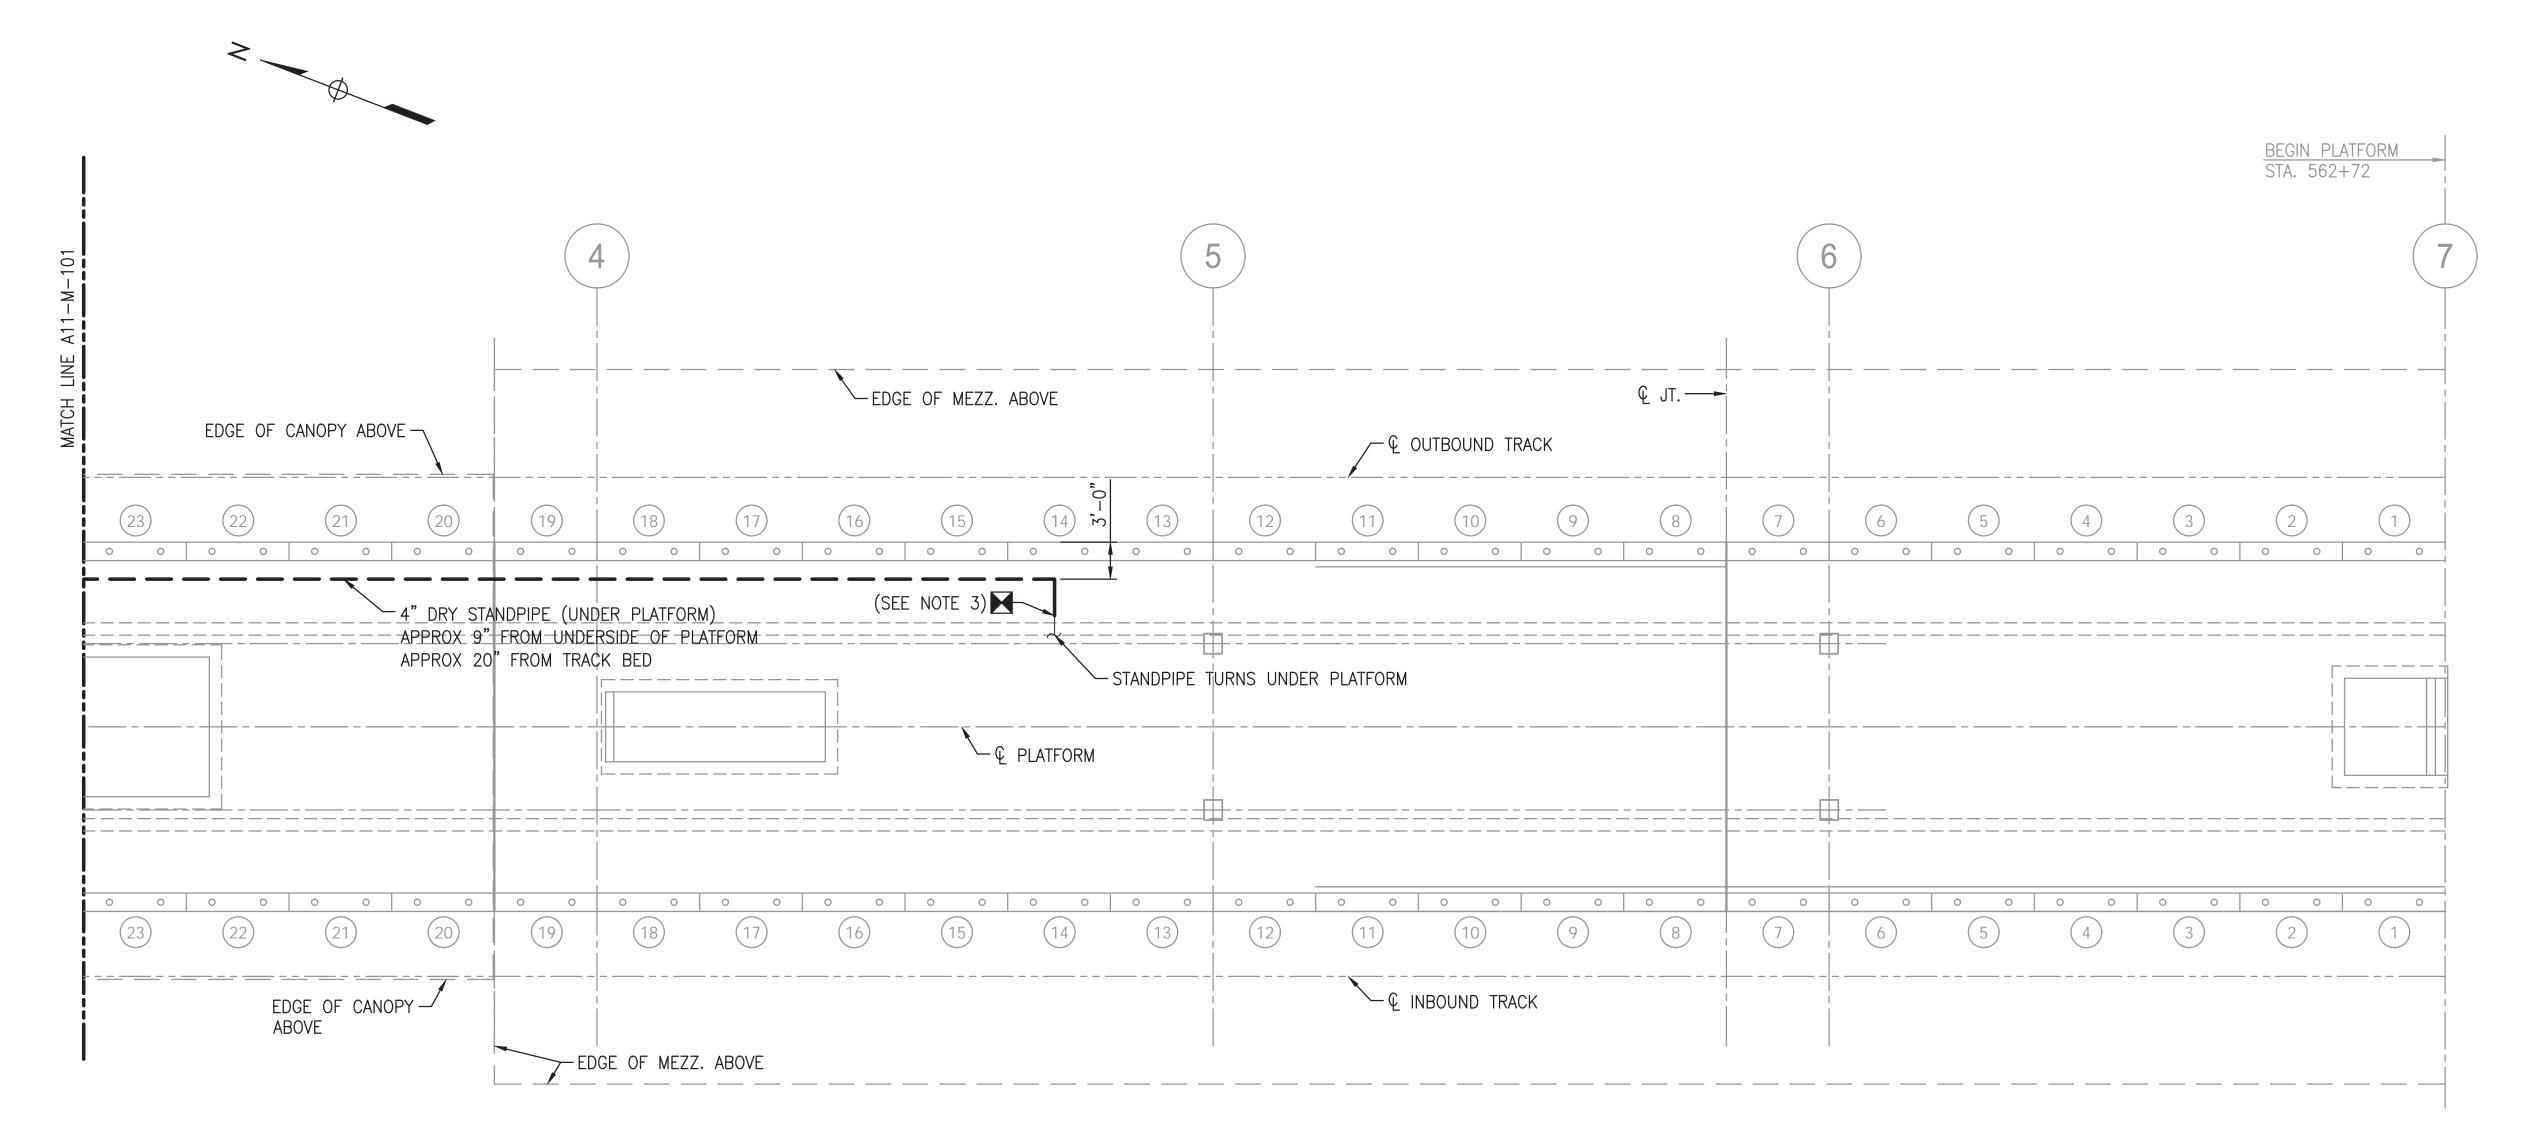
A Gannett Fleming/Parsons
JOINT VENTURE
Brad Mason, P.E.

PROJECT MANAGER

RED LINE REHAB.-FRIENDSHIP HEIGHTS TO GROSVENOR - PART 4 GROSVENOR STATION - MECHANICAL

STANDPIPE DEMOLITION PLAN 1 OF 2


AS SHOWN DRAWING NO. SHEET NO. M1272-161





#### NOTES:

- 1. FOR GENERAL NOTES, REFER TO DRAWING M-001.
- 2. FOR DETAILS, REFER TO M-500 SERIES DRAWINGS.
- 3. LEAVE 1' OF PIPE REMAINING PRIOR TO PENETRATION TO ALLOW FOR A POINT OF RECONNECTION.

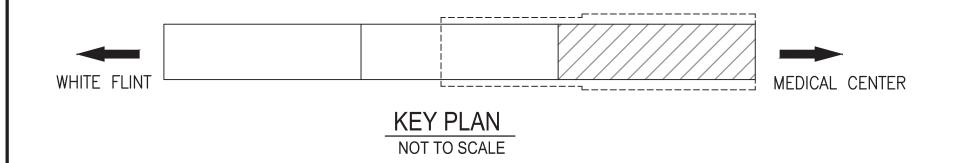

PROFESSIONAL CERTIFICATION. I HEREBY CERTIFY THAT THESE DOCUMENTS WERE PREPARED OR APPROVED BY ME, AND THAT I AM A DULY LICENSED PROFESSIONAL ENGINEER UNDER THE LAWS OF THE STATE OF MARYLAND, LICENSE NO. 23210, EXPIRATION DATE 06-30-2016.

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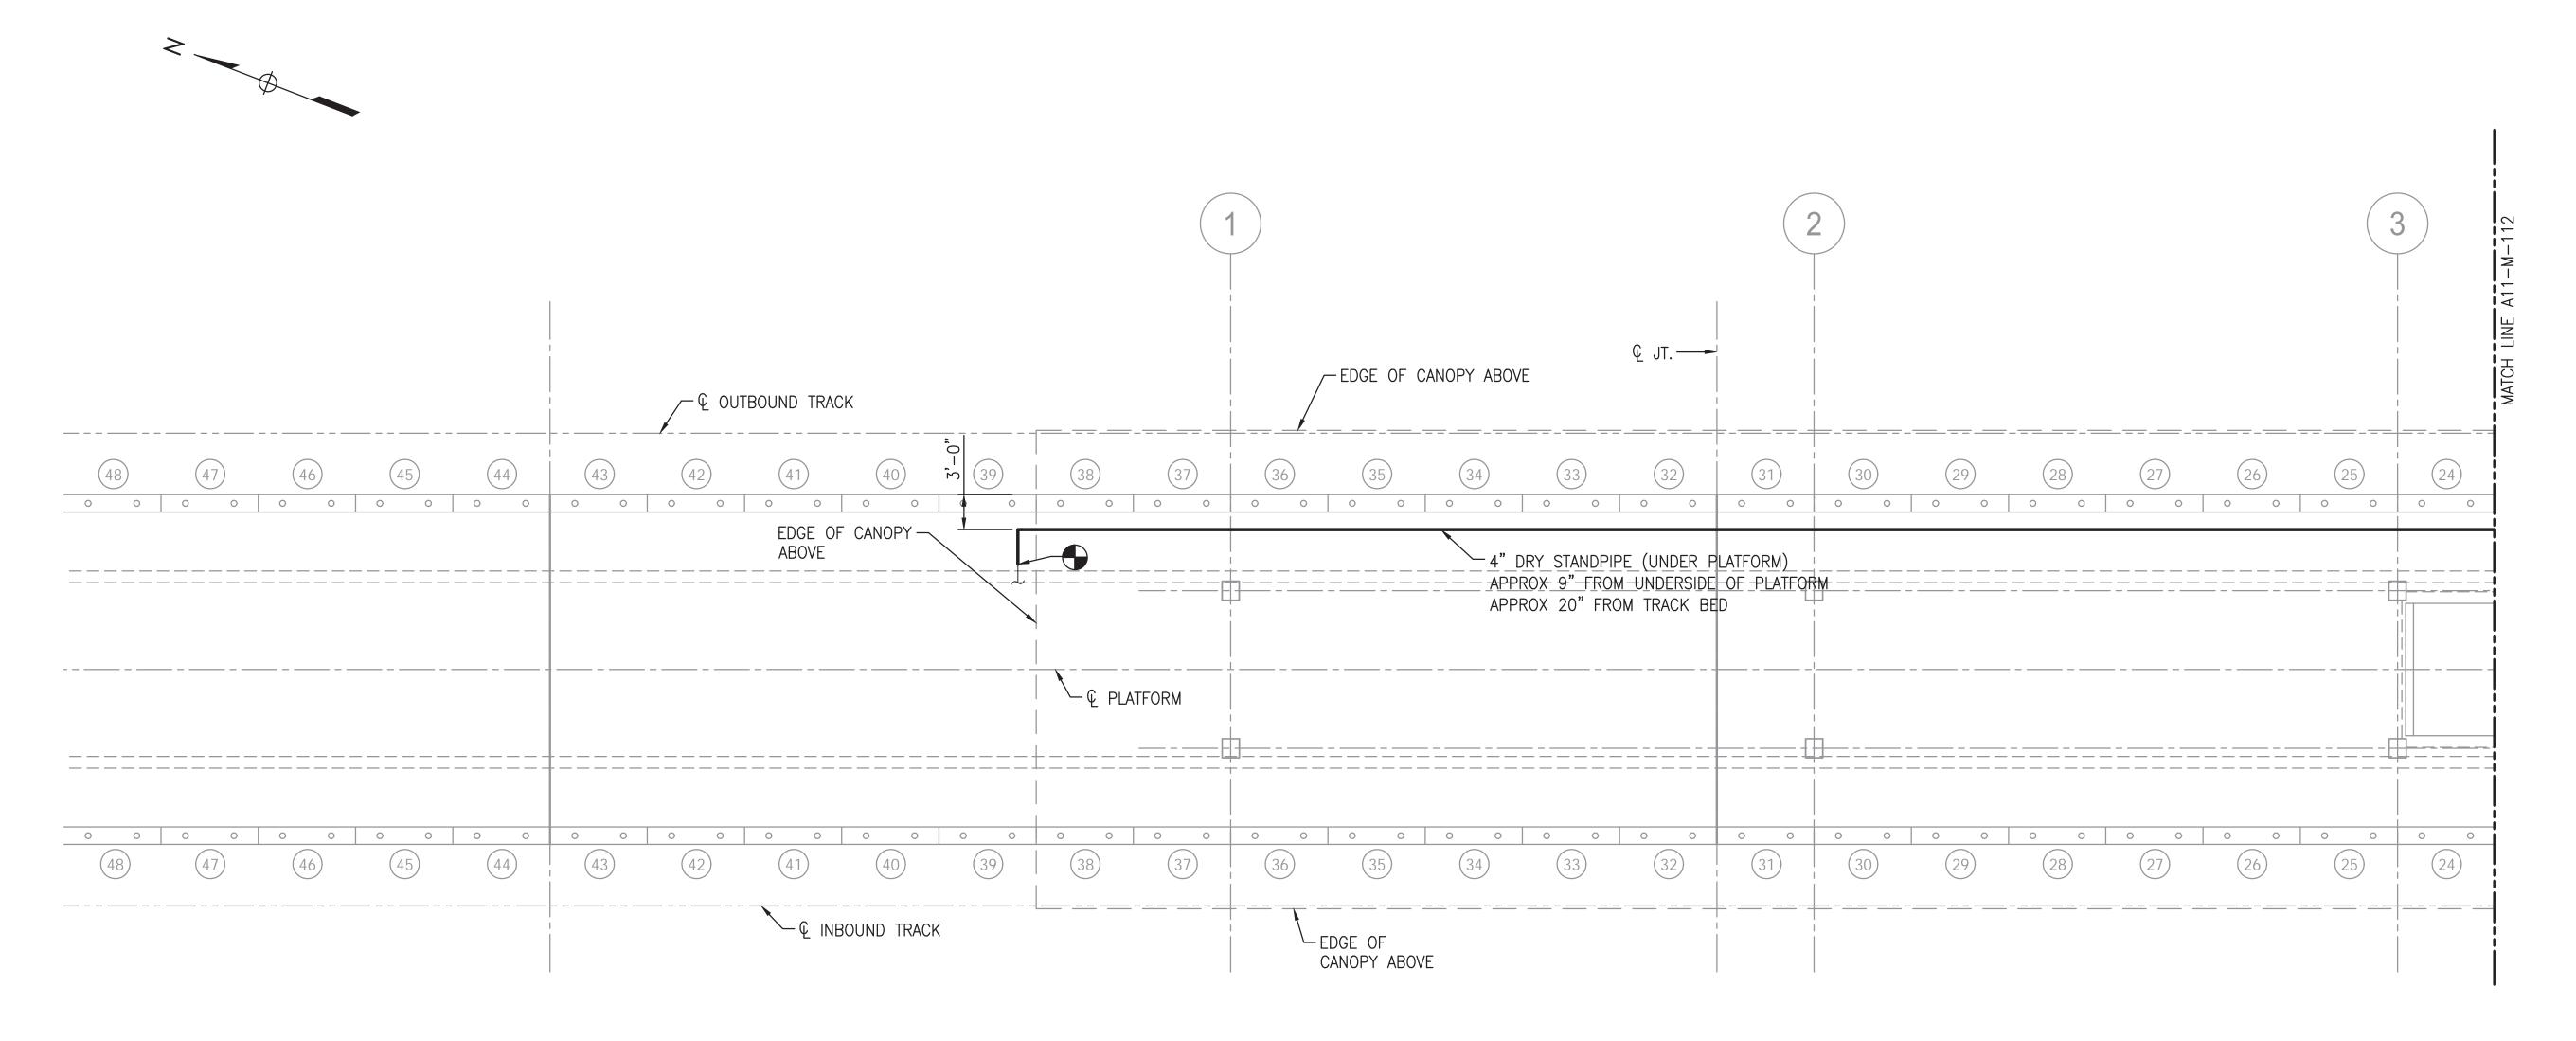
A Gannett Fleming/Parsons
JOINT VENTURE Brad Mason, P.E.

RED LINE REHAB.-FRIENDSHIP HEIGHTS TO GROSVENOR - PART 4

GROSVENOR STATION - MECHANICAL STANDPIPE DEMOLITION PLAN 2 OF 2

SCALE SHEET NO. AS SHOWN M1272-162


SUBMITTED PROJECT MANAGER A11-M-102



## PARTIAL PLATFORM PLAN SCALE: 1/8" = 1'-0"

#### NOTES:

- 1. FOR GENERAL NOTES, REFER TO DRAWING M-001.
- 2. FOR DETAILS, REFER TO M-500 SERIES DRAWINGS.

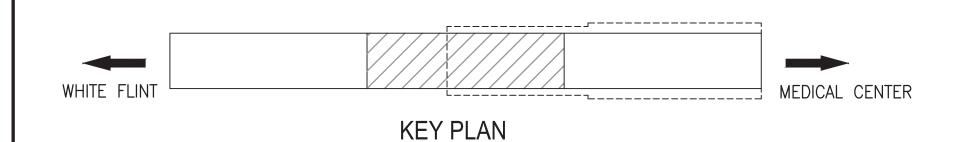

NOT TO SCALE

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OFFICE OF INFRASTRUCTURE RENEWAL PROGRAM


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| AM    | Brad Mason, P.E.         |
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PROJECT MANAGER

RED LINE REHAB.-FRIENDSHIP HEIGHTS TO GROSVENOR - PART 4

GROSVENOR STATION - MECHANICAL STANDPIPE NEW WORK PLAN 1 OF 2


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#### NOTES:

- 1. FOR GENERAL NOTES, REFER TO DRAWING M-001.
- 2. FOR DETAILS, REFER TO M-500 SERIES DRAWINGS.

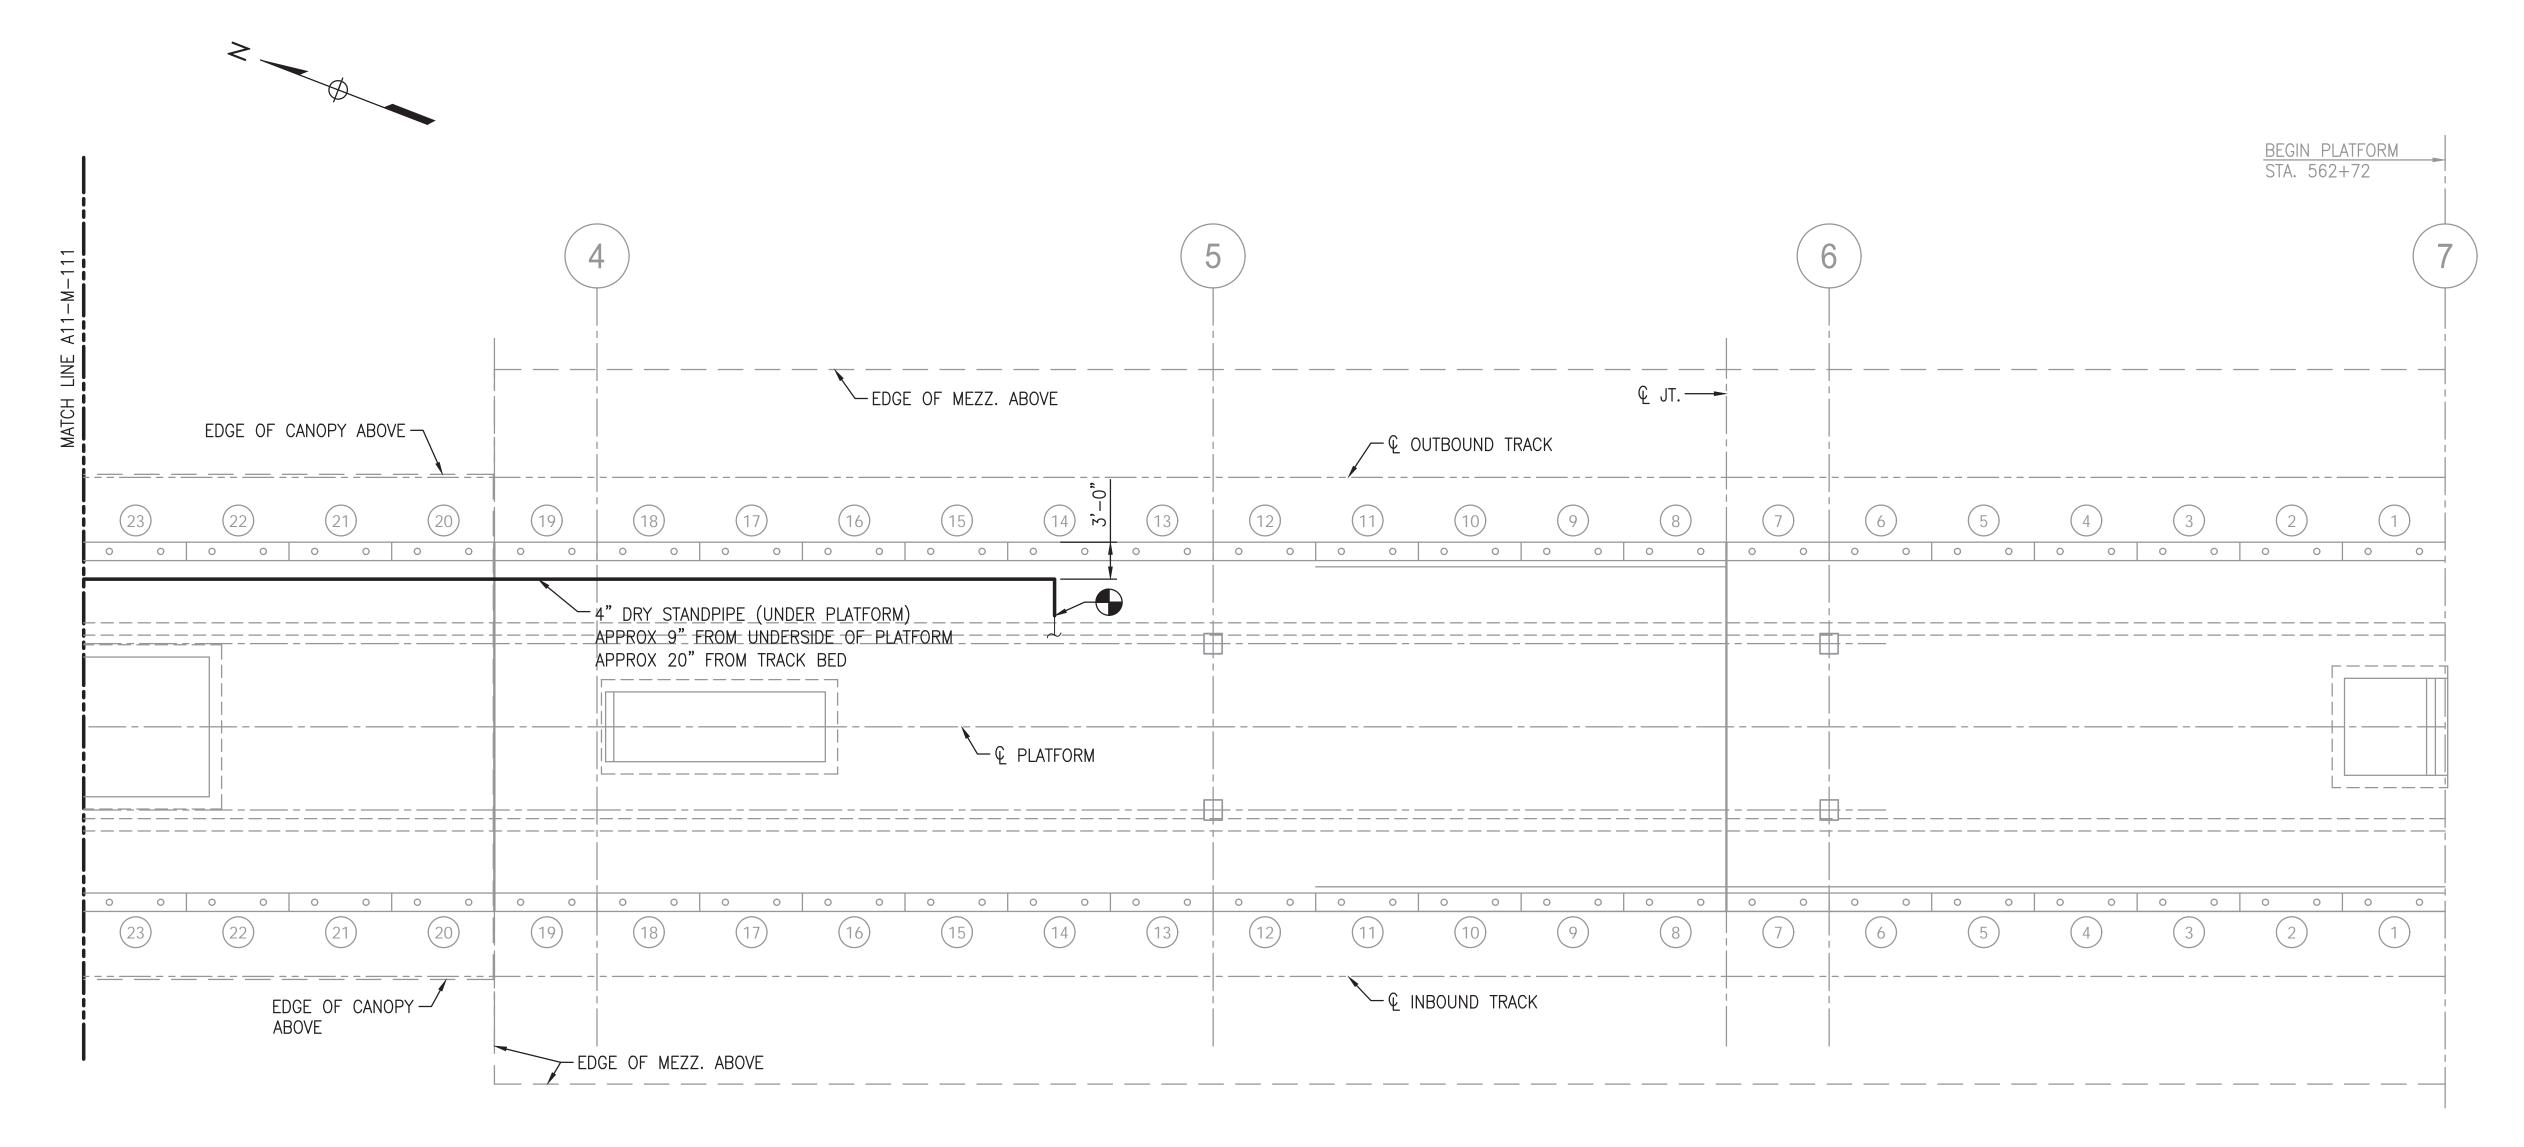

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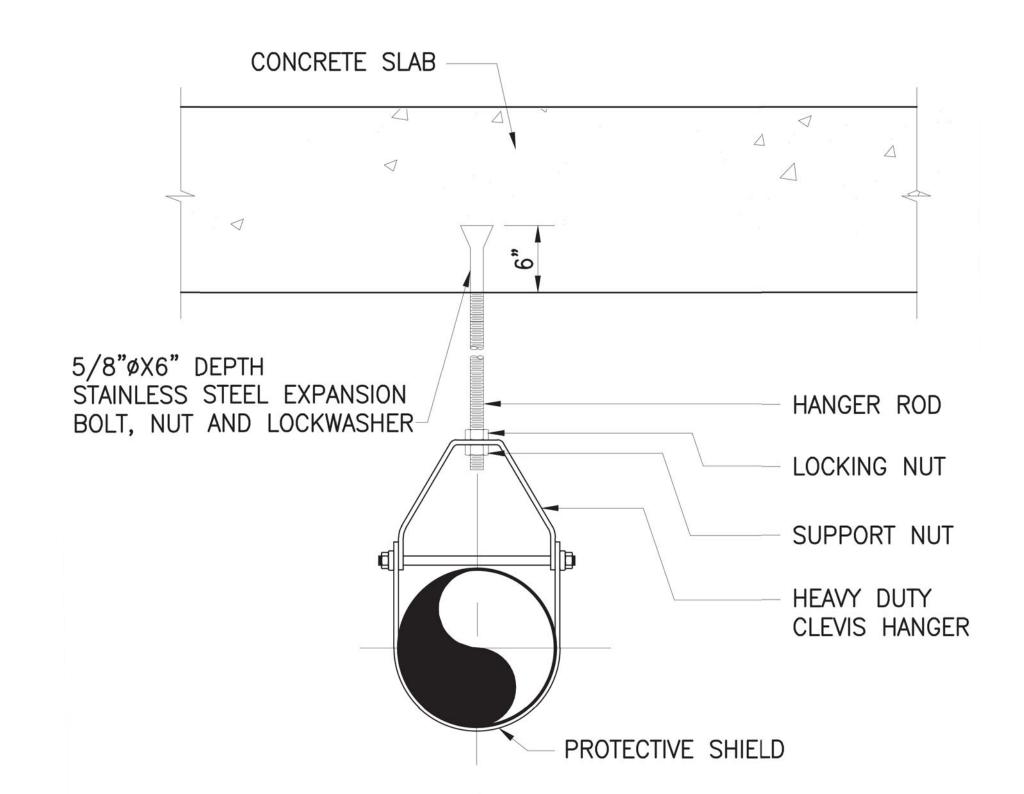
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|   | JOINT VENTURE             |
| M | Brad Mason, P.E.          |
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RED LINE REHAB.-FRIENDSHIP HEIGHTS TO GROSVENOR - PART 4


GROSVENOR STATION - MECHANICAL STANDPIPE NEW WORK PLAN 2 OF 2

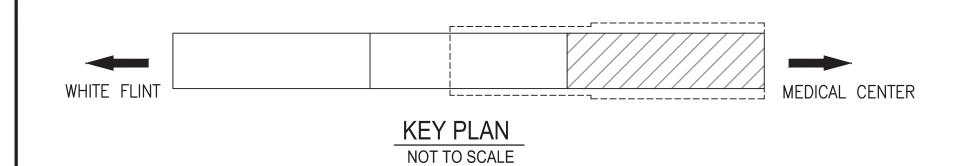SCALE SHEET NO. AS SHOWN A11-M-112 M1272 - 164

SUBMITTED PROJECT MANAGER



# HANGER DETAIL NOT TO SCALE

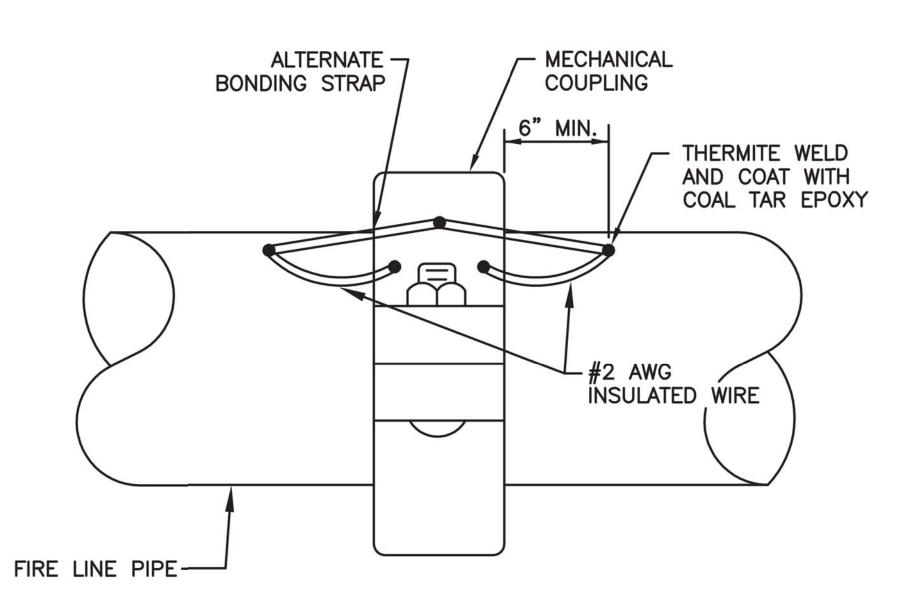

## PIPE JOINT BOND

REQUIRED FOR ALL PIPE JOINTS WITH COUPLINGS SCALE: NONE

NOTE: SIMILAR BONDING REQUIRED FOR ALL IN-LINE VALVES AND THREADED CONNECTIONS.

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PROJECT MANAGER

RED LINE REHAB.-FRIENDSHIP HEIGHTS TO GROSVENOR - PART 4

GROSVENOR STATION - MECHANICAL DETAILS

FINAL

FQ15093

SCALE DRAWING NO. AS SHOWN A11-M-500 SHEET NO. M1272-165

#### LEGEND

APPROVED J. PURDY

01/30/

EXISTING TO REMAIN EXPOSED CONDUIT

EXISTING TO REMAIN CONCEALED CONDUIT

#### PLAN KEY NOTES

- ① DISCONNECT REMOVED PYLONS AND CONNECT THEM BACK AFTER THEY ARE RE-INSTALLED. TEST EXISTING WIRING, REPLACE IT AS REQUIRED.
- DISCONNECT REMOVED DIORAMAS AND RECONNECT THEM AFTER THEY ARE RE-INSTALLED. TEST EXISTING WIRING, REPLACE IT AS REQUIRED. WHEN RECONNECTING DIORAMAS, RELOCATE CONDUIT STUB-UP TO A POINT DIRECTLY BELOW DIORAMA.
- REMOVE EXISTING FLASHING LIGHTS. REPLACE EXISTING FLASHER/DIMMER CABINETS IN BOTH AC SWITCHGEAR ROOMS. INSTALL NEW FLASHING LIGHTS. PROVIDE NEW CONDUIT AND WIRING. ADJACENT LIGHTS ARE ALTERNATELY CONNECTED TO DIFFERENT PHASES. VERIFY CIRCUITS SHOWN WITH FIELD CONDITIONS.
- DISCONNECT AND REMOVE FLOOR MOUNTED RECEPTACLES.
  REMOVE EXISTING POWER SUPPLY WIRING AND CONDUIT BACK
  TO NEAREST JUNCTION BOX. EXISTING CONDUIT EMBEDDED IN
  CONTRETE MAY BE ABANDONED.
- GROUNDING: RESTORE GROUNDING CONNECTION TO ALL METALLIC EQUIPMENT ON PLATFORM AFTER EQUIPMENT IS RE-INSTALLED. PROVIDE ADDITIONAL NEW GROUNDING CONNECTIONS AS REQUIRED. PROVIDE GROUNDING AND BONDING CONNECTION FOR ALL PLATFORM MANHOLES. COMPLY WITH WMATA STANDARDS AND GROUNDING DETAIL SHOWN IN THESE DOCUMENTS.
- REPLACE EXISTING GLOBES WITH NEW GLOBES, DECRA-LITE 14"
  ROUND POLY CARBONATE GLOBE PART #DL14SPCC-H-14.
  REPLACE LAMPS WITH ENERGY SAVER SPIRAL FLUORESCENT
  SELF-BALLASTED LAMP, 120V. SEE DETAIL ON DRAWING
  A11-E-202.
- 7) NOT USED
- 8 DISCONNECT COMMUNICATION WIRING TO EMERGENCY COMMUNICATION PYLONS REMOVED DURING FLOOR REPAIRS AND CONNECT BACK AFTER INSTALLATION.
- 9 REMOVE AND REPLACE PORTION OF CONDUIT AND WIRING SERVICING PLATFORM LIGHTS AND RECEPTACLES THAT CROSSES PLATFORM OVERHANG REPAIR AREA.
- 10 NOT USED.
- PROVIDE NEW RECEPTACLES SUPPORTED FROM WIND SHELTERS. REFER TO DETAIL ON DWG. A11-E-500 FOR ADDITIONAL INFORMATION.
- (2) EXISTING RELOCATED FIRE WATER STANDPIPE. REFER TO MECHANICAL DWGS. FOR EXACT LOCATION. RESTORE BONDING JUMPERS ACROSS FLANGES.
- (3) PROVIDE A GREEN INSULATED #6 AWG BONDING WIRE FROM FIRE WATER STANDPIPE TO EXISTING GROUNDING CONDUCTOR UNDER PLATFORM (REQUIRED TWO PLACES).
- CORRODED SECTIONS OF CONDUIT UNDER EXPANSION JOINTS SHALL BE REPLACED. AFTER REPLACEMENT PROTECT FROM RAIN WATER PORTION OF CONDUIT THAT RUNS THROUGH EXPANSION JOINT. TYPICAL FOR ALL EXPANSION JOINTS IN OPEN AREA EXPOSED TO WEATHER (NOT UNDER CANOPY).
- (5) NOT USED
- (6) PROVIDE GROUNDING CONNECTION TO FIRE WATER MANHOLES USING # 6 AWG GROUNDING CONDUCTOR.

#### GENERAL NOTES

- . CONTRACTOR SHALL CONTACT WMATA AR (AUTHORITY REPRESENTATIVE) TO DEFINE ACCEPTABLE WORKING HOURS, SPACE FOR STORAGE OF MATERIALS, PARKING, ETC.
- 2. ALL MATERIALS PROVIDED SHALL BE UL LISTED, NEW AND CONFORM TO CONTRACT SPECIFICATIONS, DRAWINGS AND THE LATEST EDITION OF THE NATIONAL ELECTRICAL CODE.
- 3. ALL WORK SHALL COMPLY WITH REQUIREMENTS OF ALL LOCAL CODES AND REGULATIONS OF AUTHORITIES HAVING JURISDICTION OVER THE WORK.
- 4. THE CONTRACTOR SHALL CAREFULLY EXAMINE ALL CONTRACT DRAWINGS/SPECIFICATIONS AND BE RESPONSIBLE FOR THE PROPER FITTING OF MATERIALS AND EQUIPMENT AT EACH LOCATION AS INDICATED. THE DRAWINGS ARE GENERALLY DIAGRAMMATIC AND DO NOT INDICATE ALL PULL BOXES, OFFSETS, FITTINGS AND ACCESSORIES AS MAY BE REQUIRED. FURNISHING SUCH MATERIALS AS REQUIRED TO MEET FIELD CONDITIONS AND NEC REQUIREMENTS SHALL BE AT NO ADDITIONAL COST TO THE AUTHORITY.
- THE CONTRACTOR SHALL EXAMINE THE SITE AND OBSERVE THE CONDITIONS UNDER WHICH THE WORK SHALL BE DONE OR OTHER CIRCUMSTANCES WHICH WILL AFFECT THE CONTEMPLATED WORK PRIOR TO SUBMITTING A BID. ANY REQUESTED VARIANCE TO THESE CONTRACT DOCUMENTS SHOULD BE SUBMITTED AS PART OF THE BID. ANY VARIANCE REQUIRED FOR FIELD CONDITIONS IDENTIFIED AFTER THE BID PERIOD WILL BE RESPONSIBILITY OF CONTRACTOR.
- 6. ALL RECEPTACLES ON PLATFORM SHALL BE GROUND FAULT PROTECTED WITH WEATHERPROOF COVER.
- 7. INDICATED DIMENSIONS OF EQUIPMENT ARE APPROXIMATE ONLY. IT IS THE RESPONSIBILITY OF THE CONTRACTOR TO MAKE FINAL VERIFICATION OF ALL MEASUREMENTS SO THAT THE NEW EQUIPMENT CAN BE MANUFACTURED TO RETROFIT EXISTING CONDITIONS.
- 8. THE CONTRACTOR SHALL ONLY WORK ON DE-ENERGIZED EQUIPMENT. ALL OUTAGES SHALL BE COORDINATED TROUGH WITH WMATA AR.
- 9. CONTRACTOR SHALL TAKE PROPER ACTION TO SECURE AND PROTECT THE OPERATIONAL EQUIPMENT IN THE STATION OR FACILITY DURING CONTRACTOR'S WORK, TO PREVENT DAMAGE OR SHUT DOWN OF EQUIPMENT.
- 10. CONTRACTOR SHALL PROTECT EXISTING ELECTRICAL EQUIPMENT TO REMAIN FROM DUST AND WATER DURING CONTRACTOR'S WORK.
- 11. ALL NEW EQUIPMENT TO BE INSTALLED SHALL BE STORED PROPERLY. EQUIPMENT DAMAGED DURING SHIPPING, HANDLING, STORAGE, WATER OR OTHER CAUSES SHOULD BE REPLACED AT CONTRACTOR'S EXPENSE.
- 12. CONTRACTOR SHALL TEMPORARILY STORE THE EXISTING REMOVED EQUIPMENT UNTIL ITS DISPOSAL. A STAGING AREA INSIDE THE FACILITY SHALL BE ESTABLISHED TO AVOID OBSTRUCTION TO EXISTING ELECTRICAL EQUIPMENT WITH LOCATION APPROVED BY WMATA AR. COORDINATE WITH THE AR TO DETERMINE WHETHER EQUIPMENT SHOULD BE RETURNED TO WMATA OR DISPOSED OF BY CONTRACTOR.
- 13. INTERRUPTION OF SERVICE TO EQUIPMENT SHALL BE KEPT TO A MINIMUM, SHALL OCCUR ONLY IN METRO NON-REVENUE HOURS AND SHALL BE COORDINATED WITH WMATA AR AT LEAST TWO WEEKS PRIOR TO THE REQUIRED OUTAGE.
- 14. CONTRACTOR SHALL OBTAIN & BECOME FAMILIAR WITH WMATA'S SAFETY AND OPERATING PROCEDURES & RULES. SAFETY TRAINING & CERTIFICATION FOR ALL CONTRACTOR EMPLOYEES ON THE WORK SITE IS MANDATORY.

- 15. A CLEAR AND UNOBSTRUCTED PATHWAY FROM TRACK TO STREET SHALL BE MAINTAINED AT ALL TIMES FOR PERSONNEL ACCESS. THIS INCLUDES PROHIBITING SUCH ACTIVITIES AS BLOCKING DOORWAYS, PATHWAYS OR STAIRS WITH EQUIPMENT AND MATERIALS, DISMANTLING STAIRS AND OBSTRUCTING STREET HATCHWAYS.
- 16. CONTRACTOR MUST INCLUDE UNIT PRICE FOR LABOR DURING WMATA NON-REVENUE HOURS.
- 17. ALL NEW POWER WIRES SHALL BE WITH RHW-2 INSULATION, LOW SMOKE, ZERO HALOGEN. ALL NEW CONDUITS GRS TYPE. ALL MATERIALS AND INSTALLATION SHALL COMPLY WITH NFPA-130.
- 18. TEST ALL EXISTING GLOBE TYPE LIGHTING FIXTURES FOR PROPER OPERATION. FIXTURES FOUND DEFECTIVE SHALL BE REPAIRED OR REPLACED. PROVIDE UNIT COST FOR REPLACEMENT FIXTURES.
- 19. UNIT COST FOR COMMUNICATION WIRING: CONTRACTOR'S BID SHALL INCLUDE REPLACING ALL WIRING UNDER PLATFORM OVERHANG. PROVIDE UNIT COST FOR EACH TYPE OF CABLE FOUND UNDER PLATFORM OVERHANG. THE WMATA AR MAY DIRECT THE CONTRACTOR TO RE-ROUTE SOME CABLES IN LIEU OF REPLACEMENT. UNIT COST WILL BE USED TO DETERMINE AMOUNT OF DEDUCT FROM CONTRACTOR'S BID PRICE.
- 20. UNIT COST FOR BRANCH CIRCUIT WIRING: PROVIDE UNIT COST FOR REPLACING LIGHTING AND RECEPTACLE BRANCH CIRCUIT WIRING FOUND DEFECTIVE.
- 21. WHERE PLATFORM MOUNTED EQUIPMENT IS SUPPLIED FROM BELOW, EXTEND OR REPLACE PORTION OF CONDUIT THAT STUBS-UP THROUGH PLATFORM TO ACCOMMODATE NEW PLATFORM THICKNESS. COORDINATE WITH STRUCTURAL WORK.
- 22. TEMPORARY LIGHTING
  - A. PROVIDE A TEMPORARY LIGHTING SYSTEM IN PUBLIC AREAS AFFECTED BY

SCOPE OF WORK INCLUDING BUT NOT LIMITED TO PLATFORMS AND

PASSAGEWAYS. THE LIGHTING SYSTEM TO BE PROVIDED SHALL INCLUDE LIGHTING

FIXTURES, WIRING, RACEWAY, AND SUPPORTS; AND SHALL COMPLY WITH WMATA

- DESIGN CRITERIA INCLUDING THE FOLLOWING:
- B. ILLUMINATION LEVELS SHALL BE 10FC (FOOT-CANDLES) AVERAGE AND 3FC MINIMUM.
- C. LIGHT SOURCE TYPE AND VOLTAGE SHALL BE IN ACCORDANCE WITH WMATA DESIGN CRITERIA.
- D. A MINIMUM OF 20% OF FIXTURES SHALL BE DESIGNATED AS EMERGENCY

AND SHALL BE SUPPLIED FROM AN EMERGENCY SOURCE. EMERGENCY ILLUMINATION LEVELS SHALL COMPLY WITH WMATA DESIGN CRITERIA, INCLUDING THE REQUIREMENT OF 2 FC IN PLATFORMS AND ACCESS PASSAGEWAYS AND 2.5 FC IN EMERGENCY EGRESS PATHS.

- E. COORDINATE WITH THE WMATA AR FOR USE OF EXISTING NORMAL AND EMERGENCY POWER SOURCE FOR NORMAL AND EMERGENCY TEMPORARY LIGHTING.
- F. PROVIDE A TEMPORARY LIGHTING SUBMITTAL SHOWING THE FOLLOWING:
  I PHOTOMETRIC PLANS TO DEMONSTRATE THAT THE PROPOSED
  LIGHTING PLAN

WILL PROVIDE THE REQUIRED ILLUMINATION LEVELS.

- II PLANS SHOWING PROPOSED LOCATIONS OF LIGHT FIXTURES, MOUNTING HEIGHTS,
- MOUNTING DETAILS, POWER SOURCE(S), ROUTING AND SUPPORT MEANS OF ALL
- TEMPORARY SUPPLY WIRING. INCLUDE LOCATION OF PROPOSED POWER SOURCES

AND ANY ANCILLARY EQUIPMENT.

- III CATALOG CUTS OF PROPOSED TEMPORARY LIGHTING FIXTURE TYPES, WATTAGES,
  VOLTAGES AND LUMEN OUTPUT, AND ALL WIRING, RACEWAY, AND
- SUPPORT MEANS.

  IV IF EXISTING PANELS ARE TO BE USED AS THE POWER SOURCE, SHOW
- ROUTING PANELS ARE TO BE USED AS THE POWER SOURCE, SHOW
  ROUTING
  FROM POWER SOURCE. SHOW NUMBER OF CIRCUITS REQUIRED AND
- TOTAL LOAD IN

  KVA. VERIFY EXISTING PANEL HAS SUFFICIENT SPARE CAPACITY TO

ACCOMMODATE
LIGHTING LOAD BEING ADDED.

NOT TO SCALE

23. RESTORE ALL STRAY CURRENT CONDUCTORS AFFECTED BY CONSTRUCTION TO ORIGINAL CONDITION

PROFESSIONAL CERTIFICATION. I HEREBY CERTIFY THAT THESE DOCUMENTS WERE PREPARED OR APPROVED BY ME, AND THAT I AM A DULY LICENSED PROFESSIONAL ENGINEER UNDER THE LAWS OF THE STATE OF MARYLAND, LICENSE NO. 43224, EXPIRATION DATE 04-14-2015.

APPROVED —

FINAL

RED LINE REHAB.-FRIENDSHIP HEIGHTS TO

GROSVENOR - PART 4

FQ15093



WASHINGTON METROPOLITAN AREA TRANSIT AUTHORITY

SUBMITTED

DEPARTMENT OF TRANSIT INFRASTRUCTURE
AND ENGINEERING SERVICES
OFFICE OF INFRASTRUCTURE RENEWAL PROGRAM




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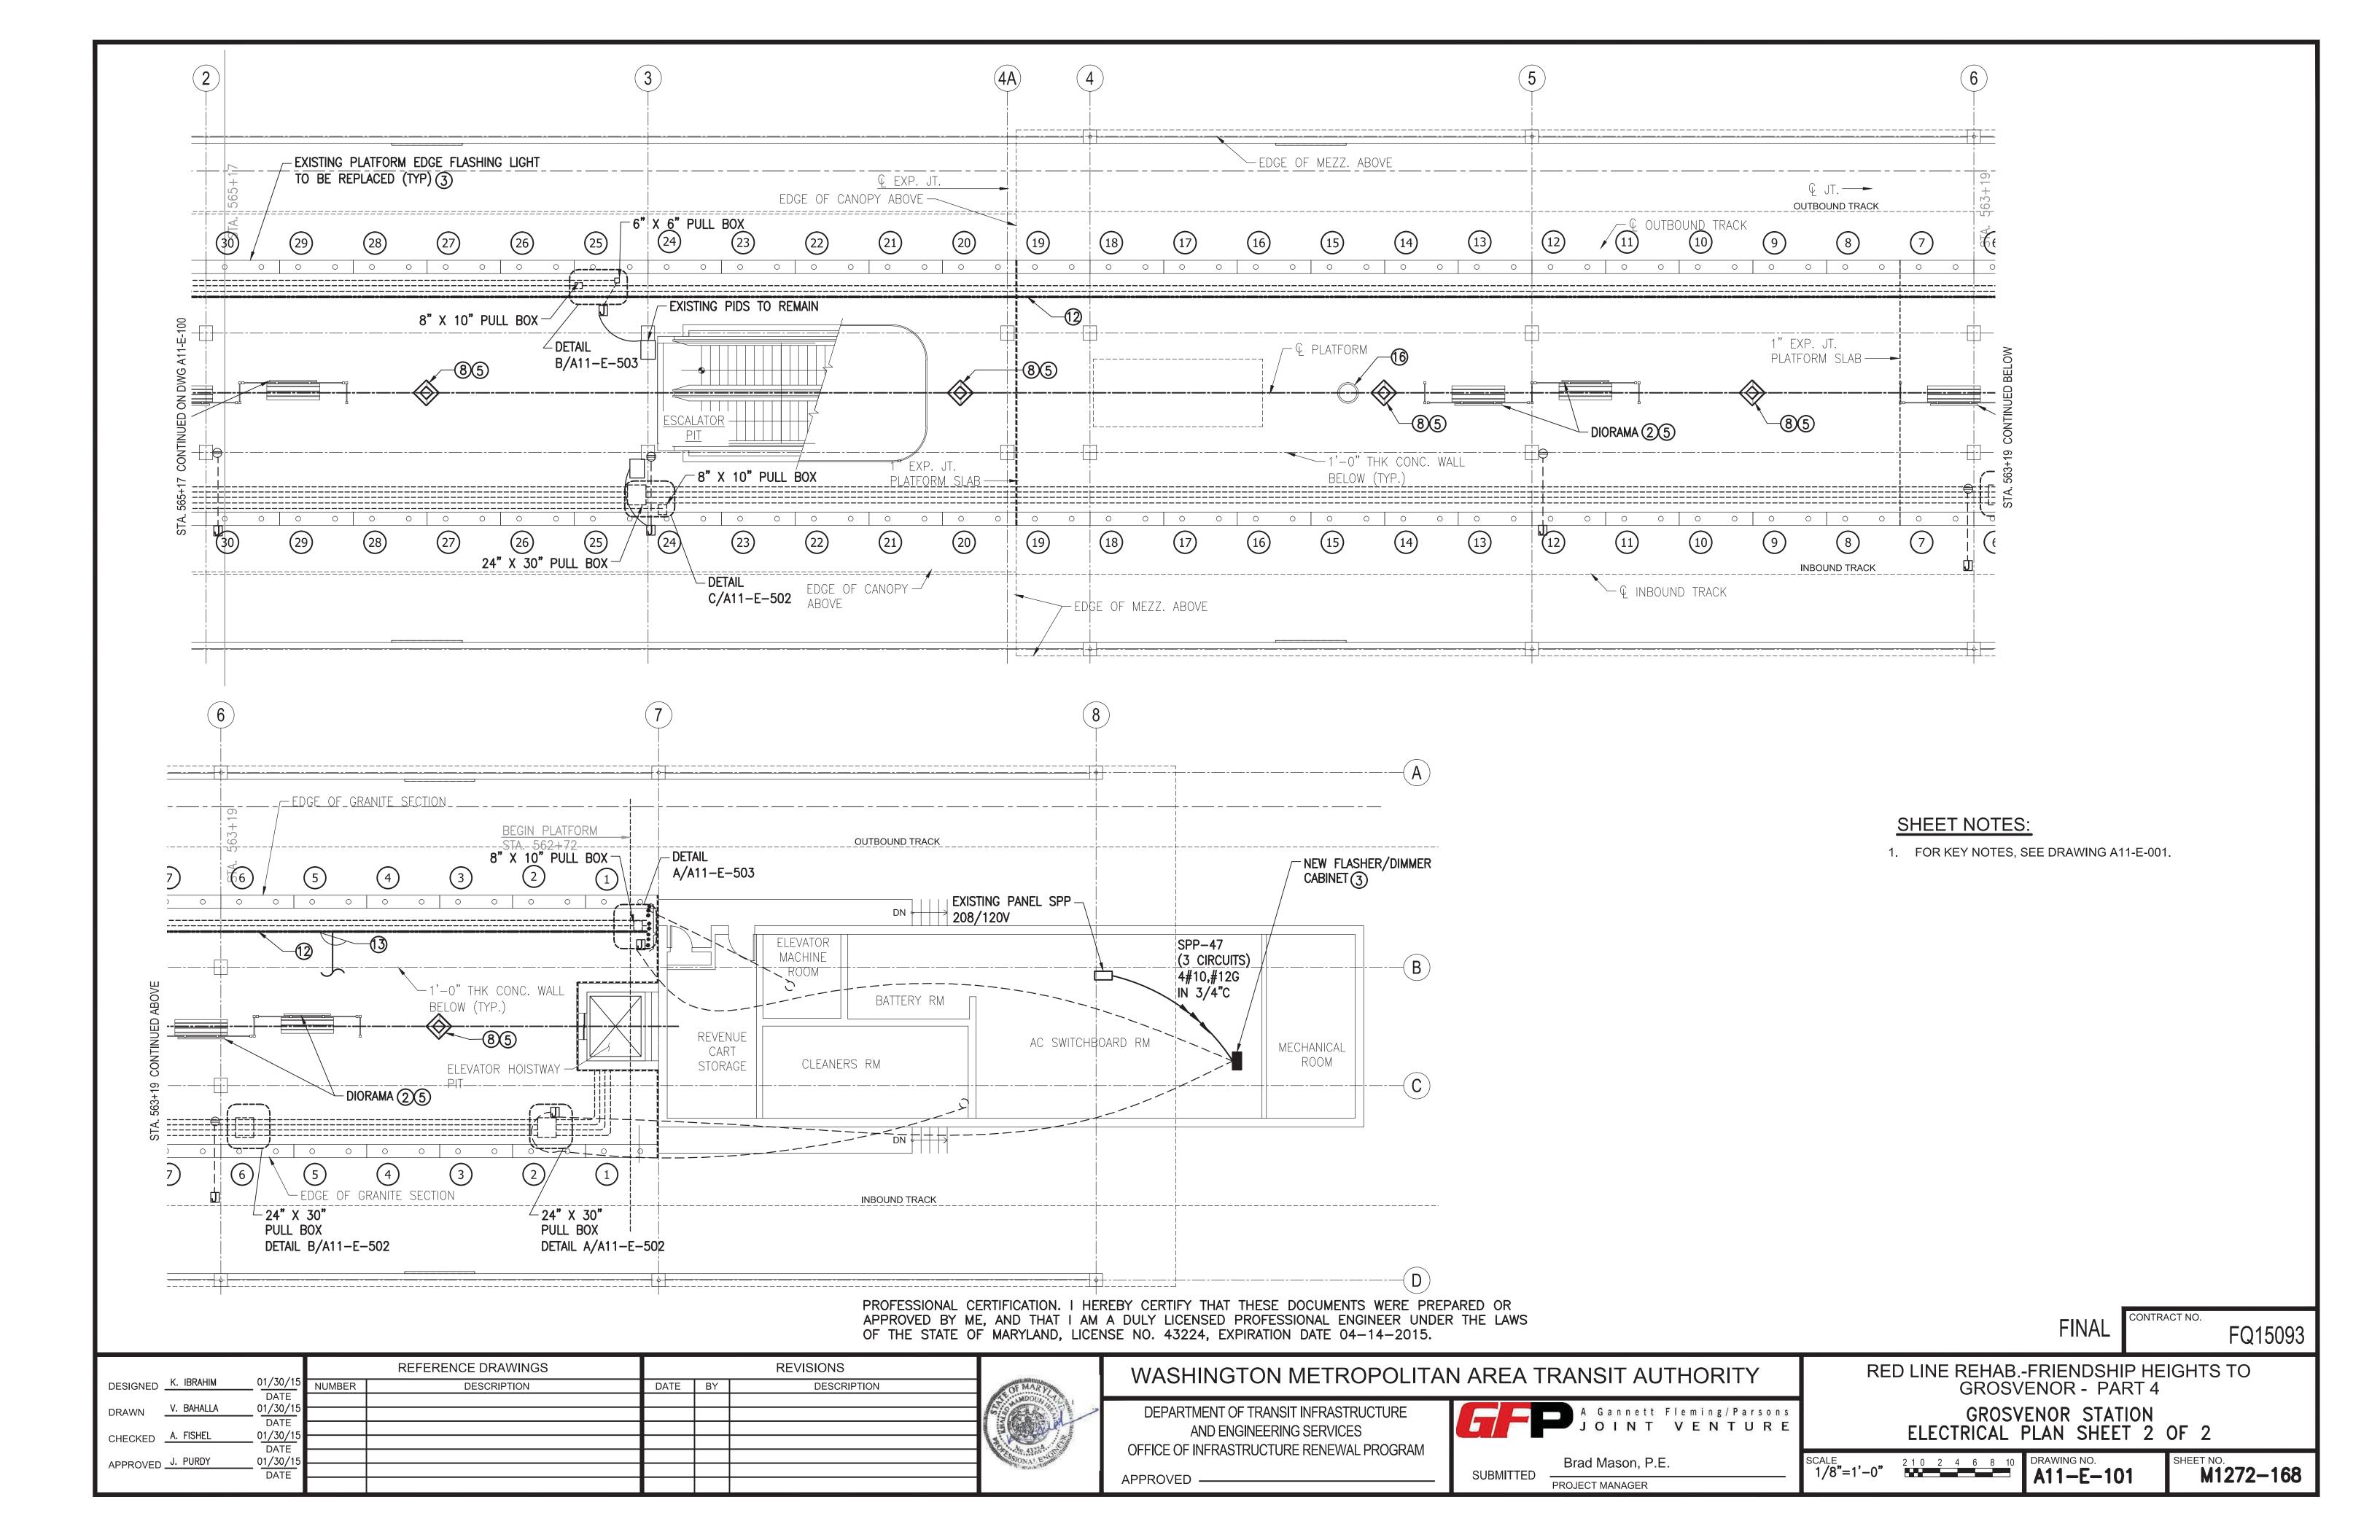
GROSVENOR STATION
SCOPE OF ELECTRICAL WORK AND GENERAL NOTES


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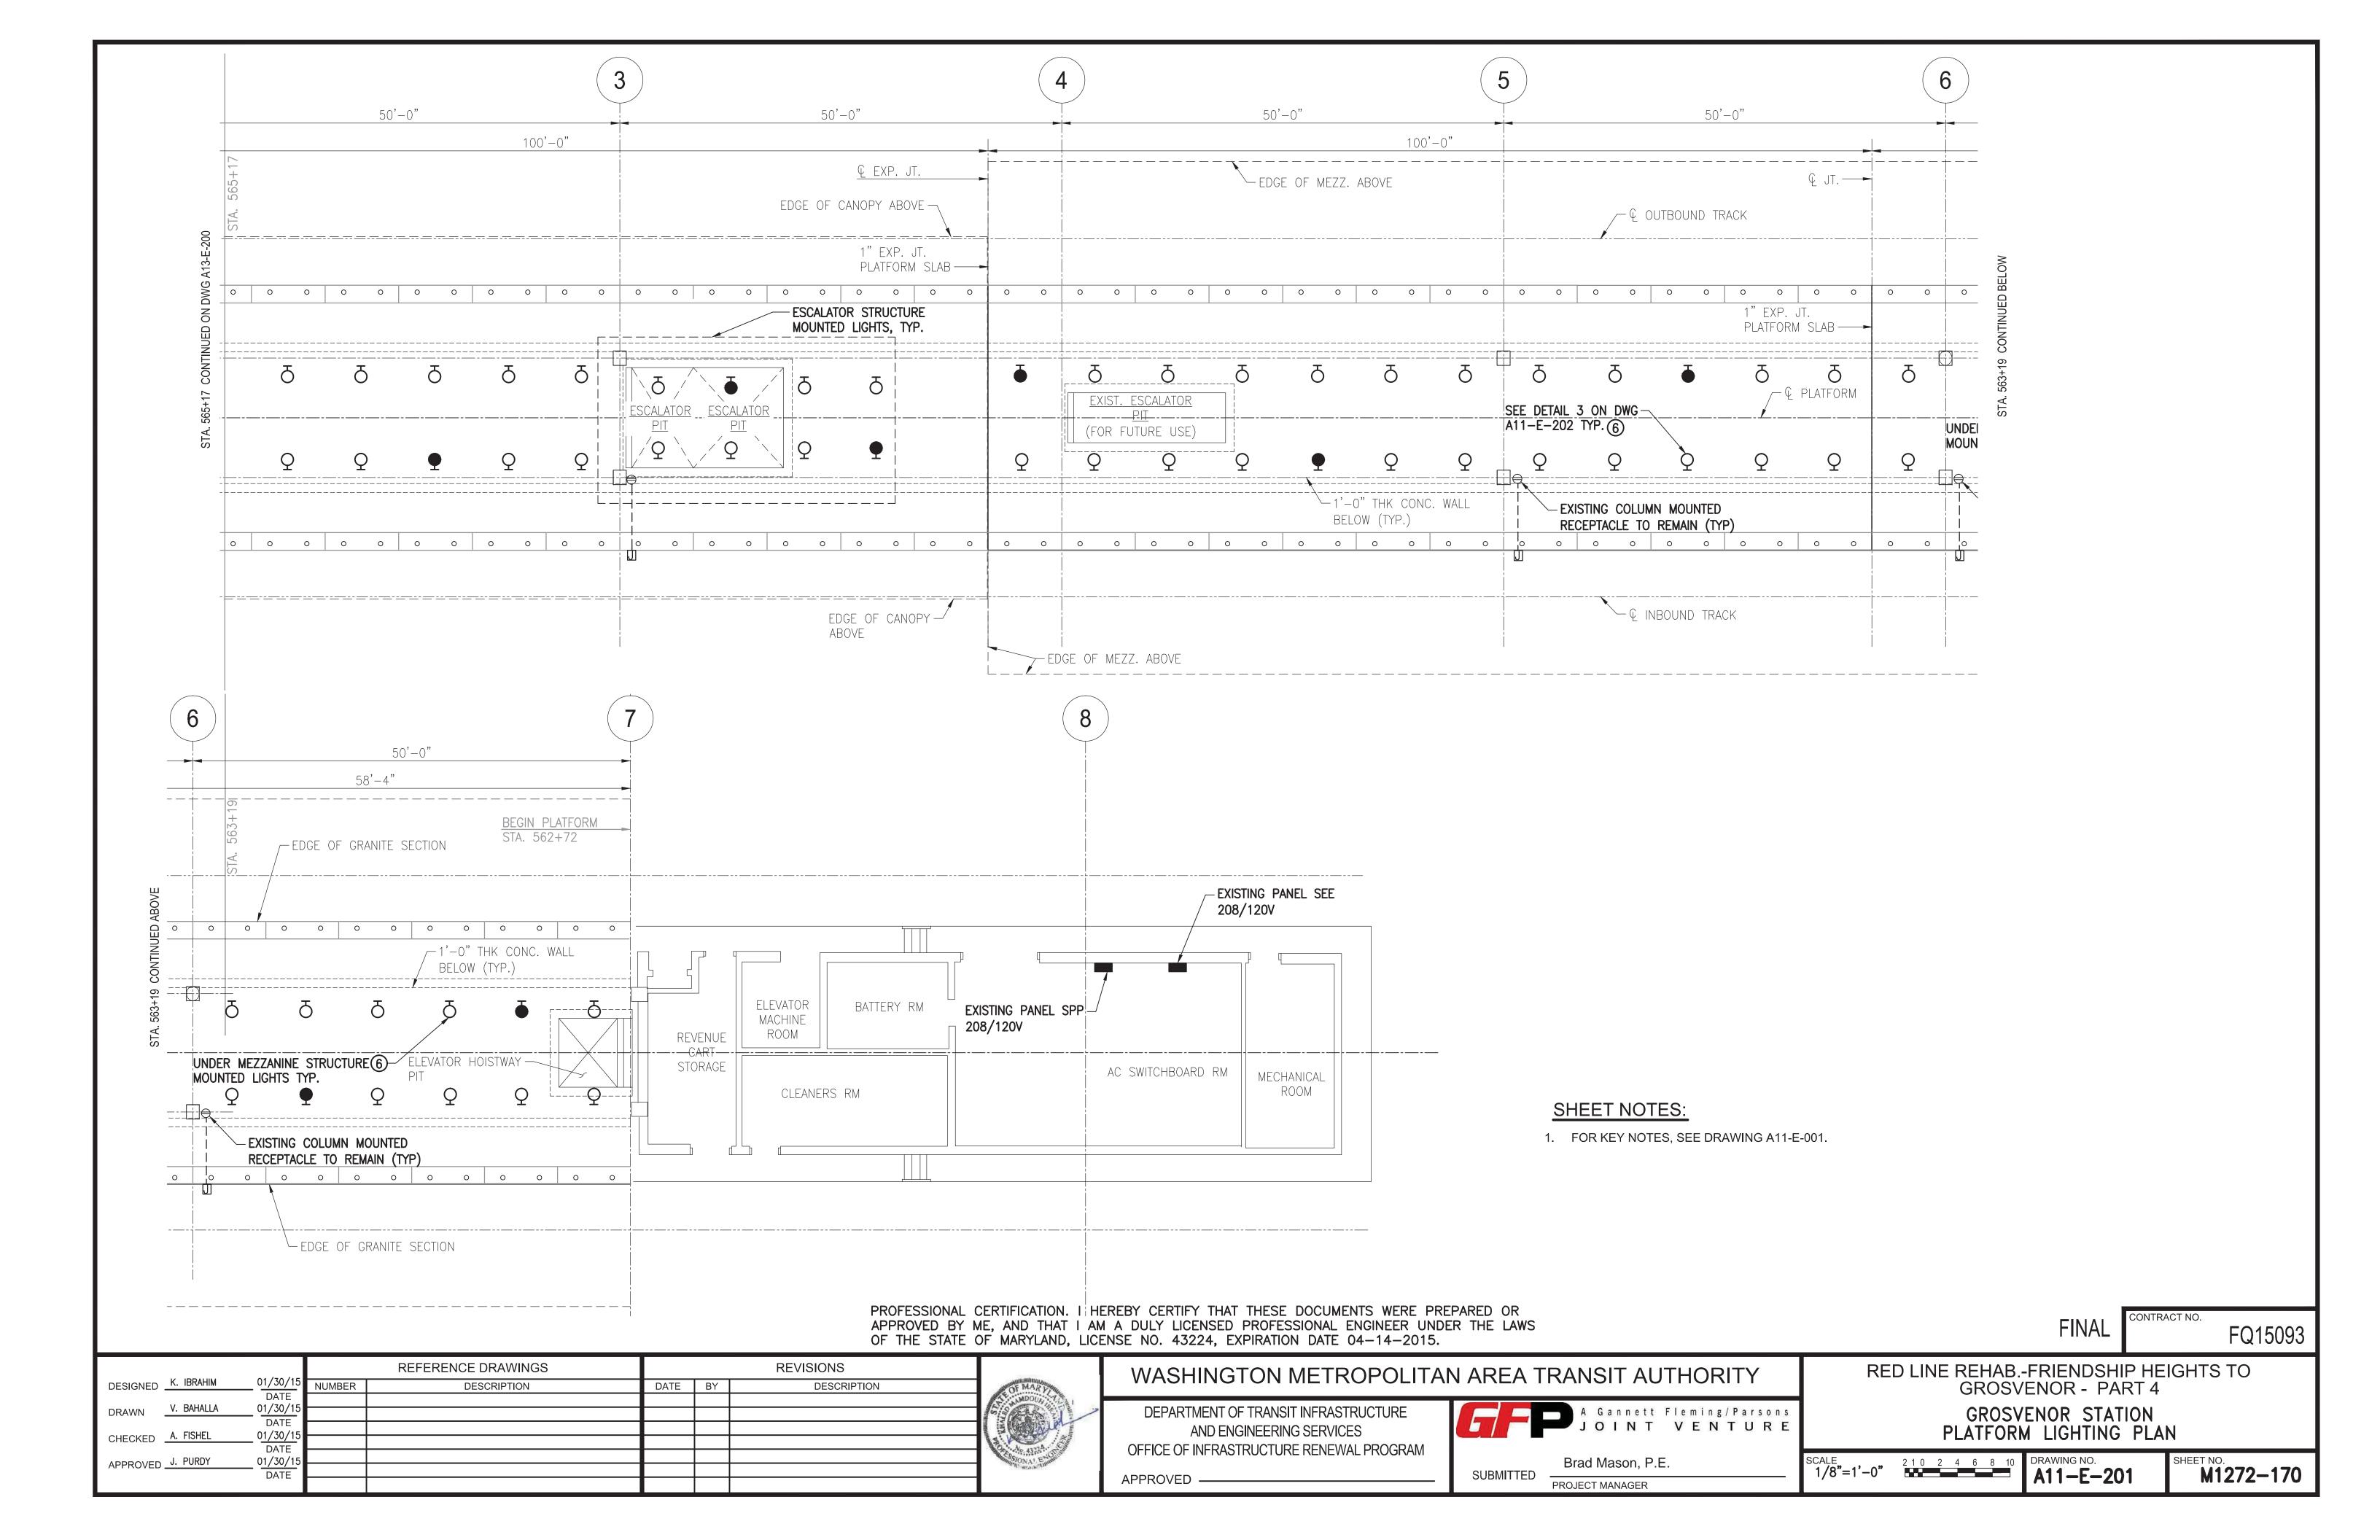
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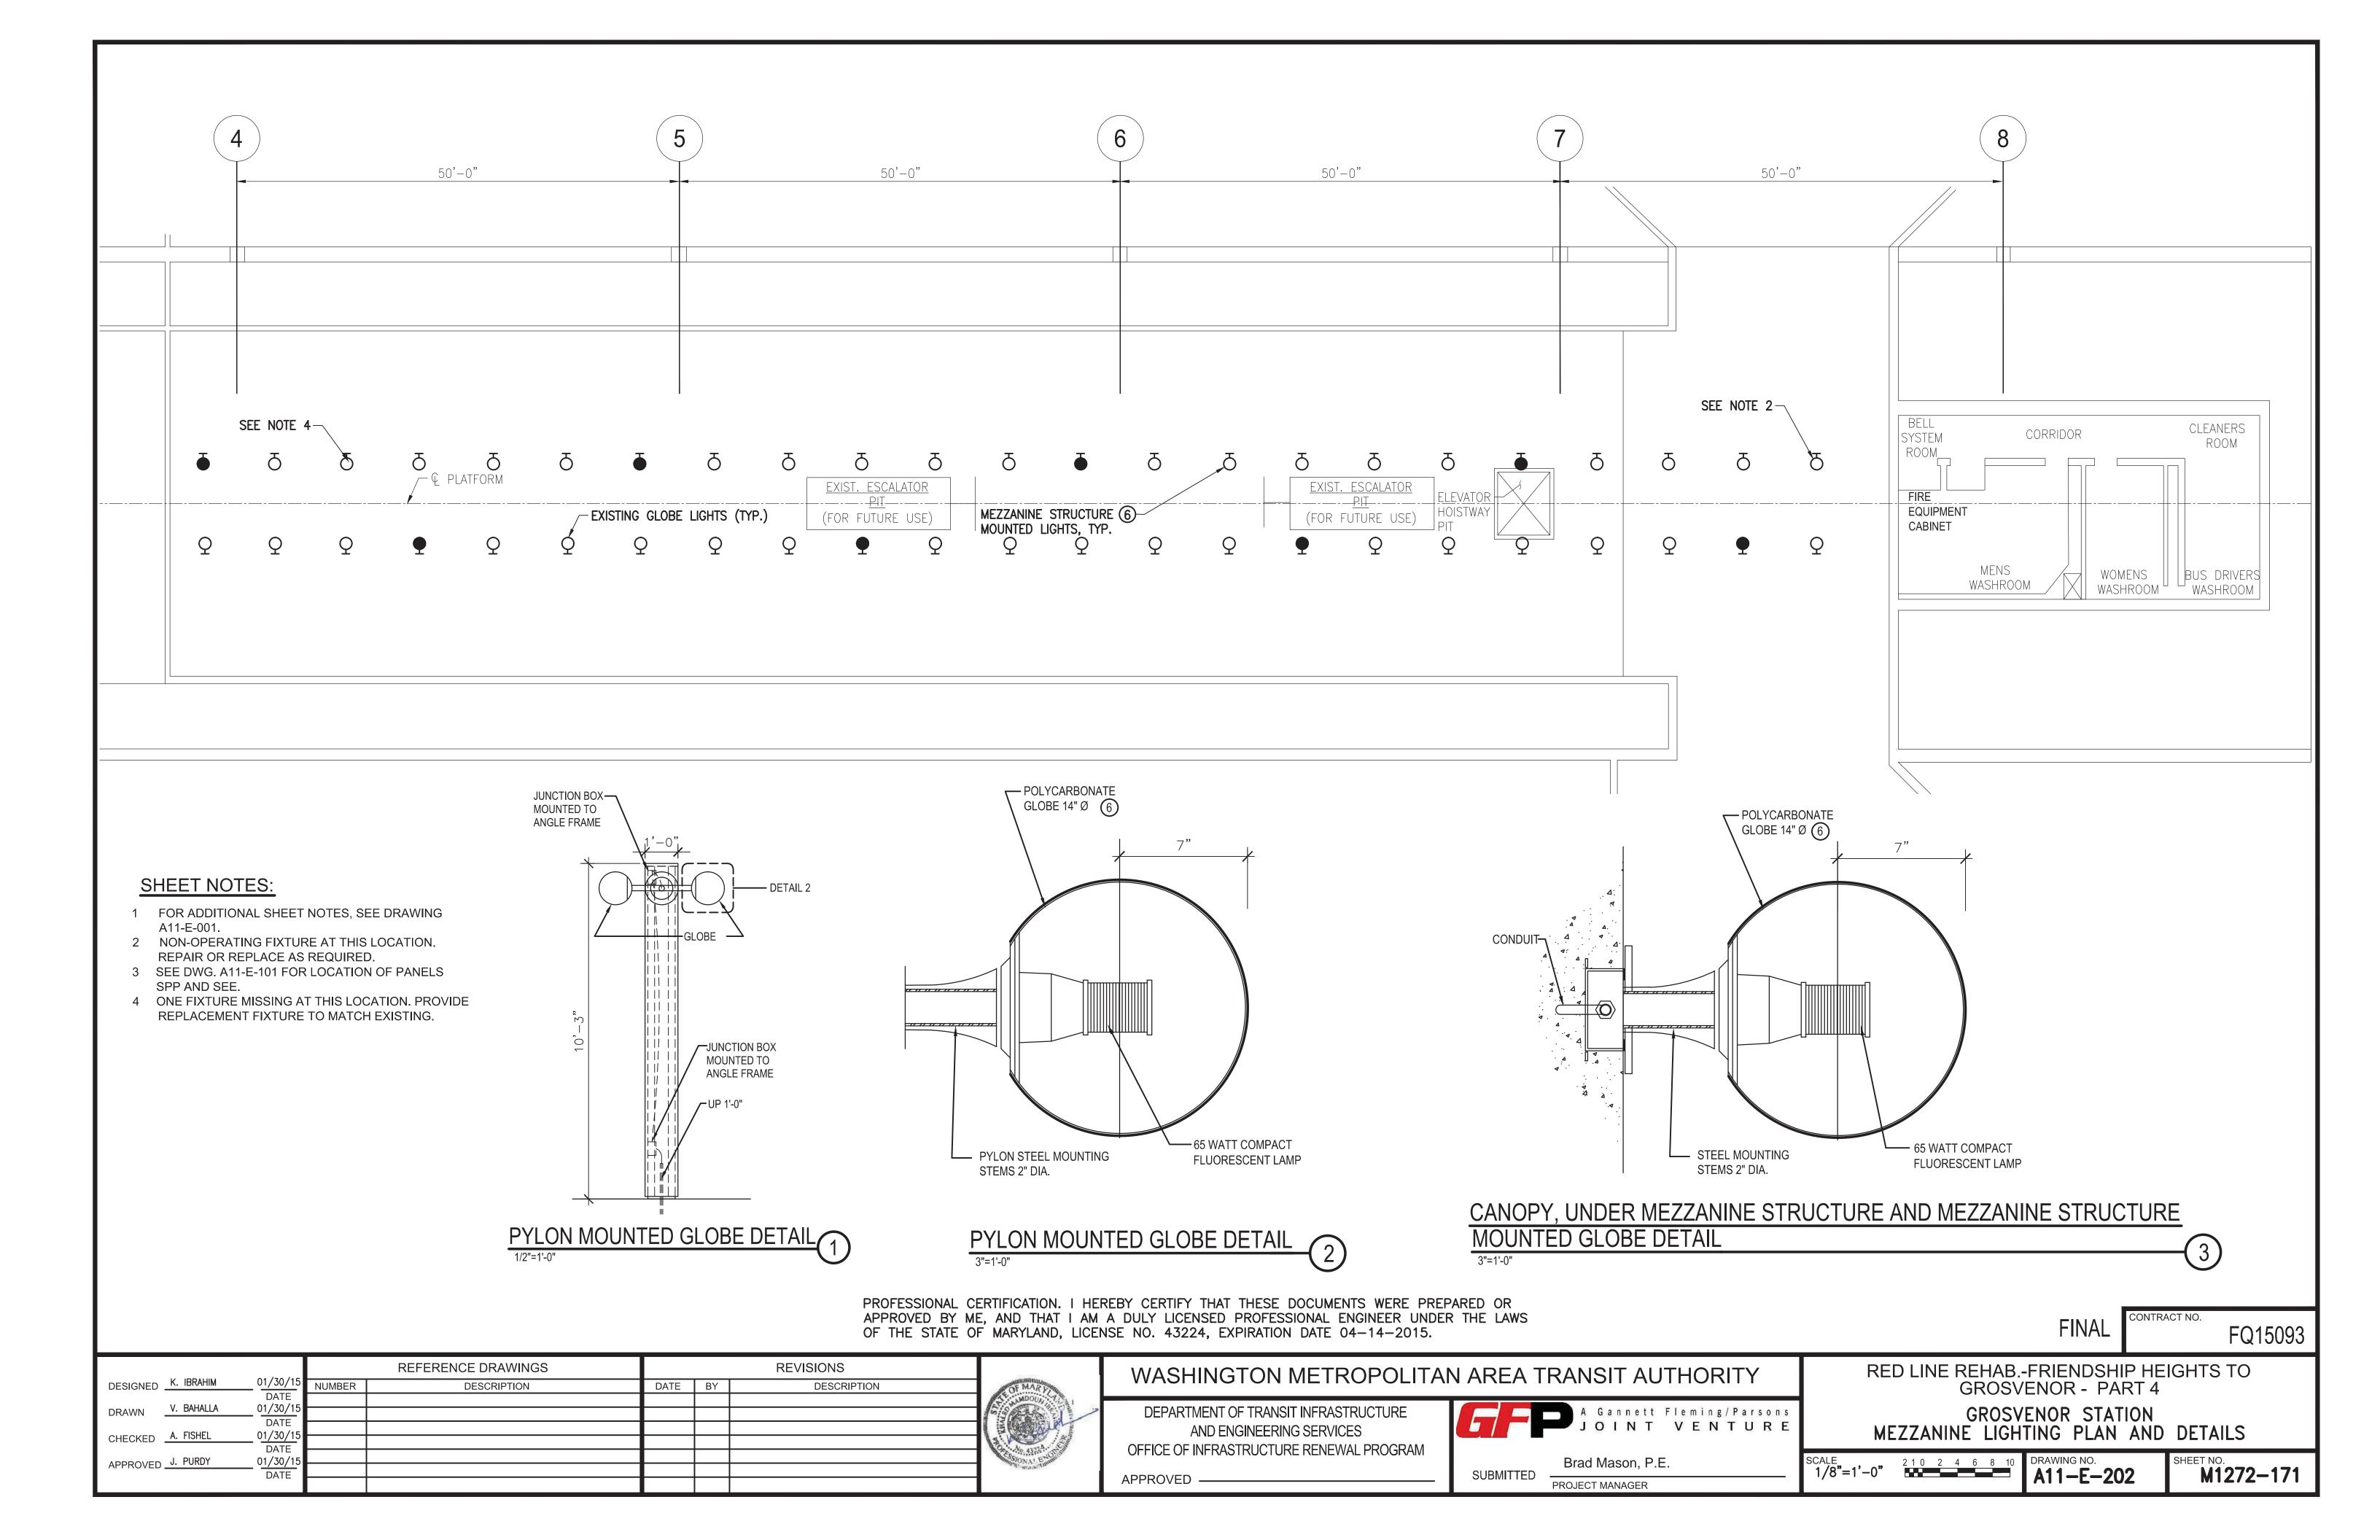
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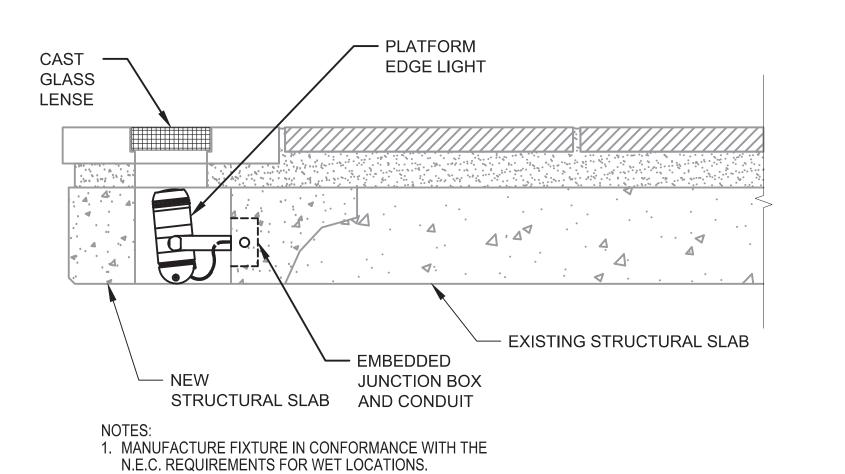








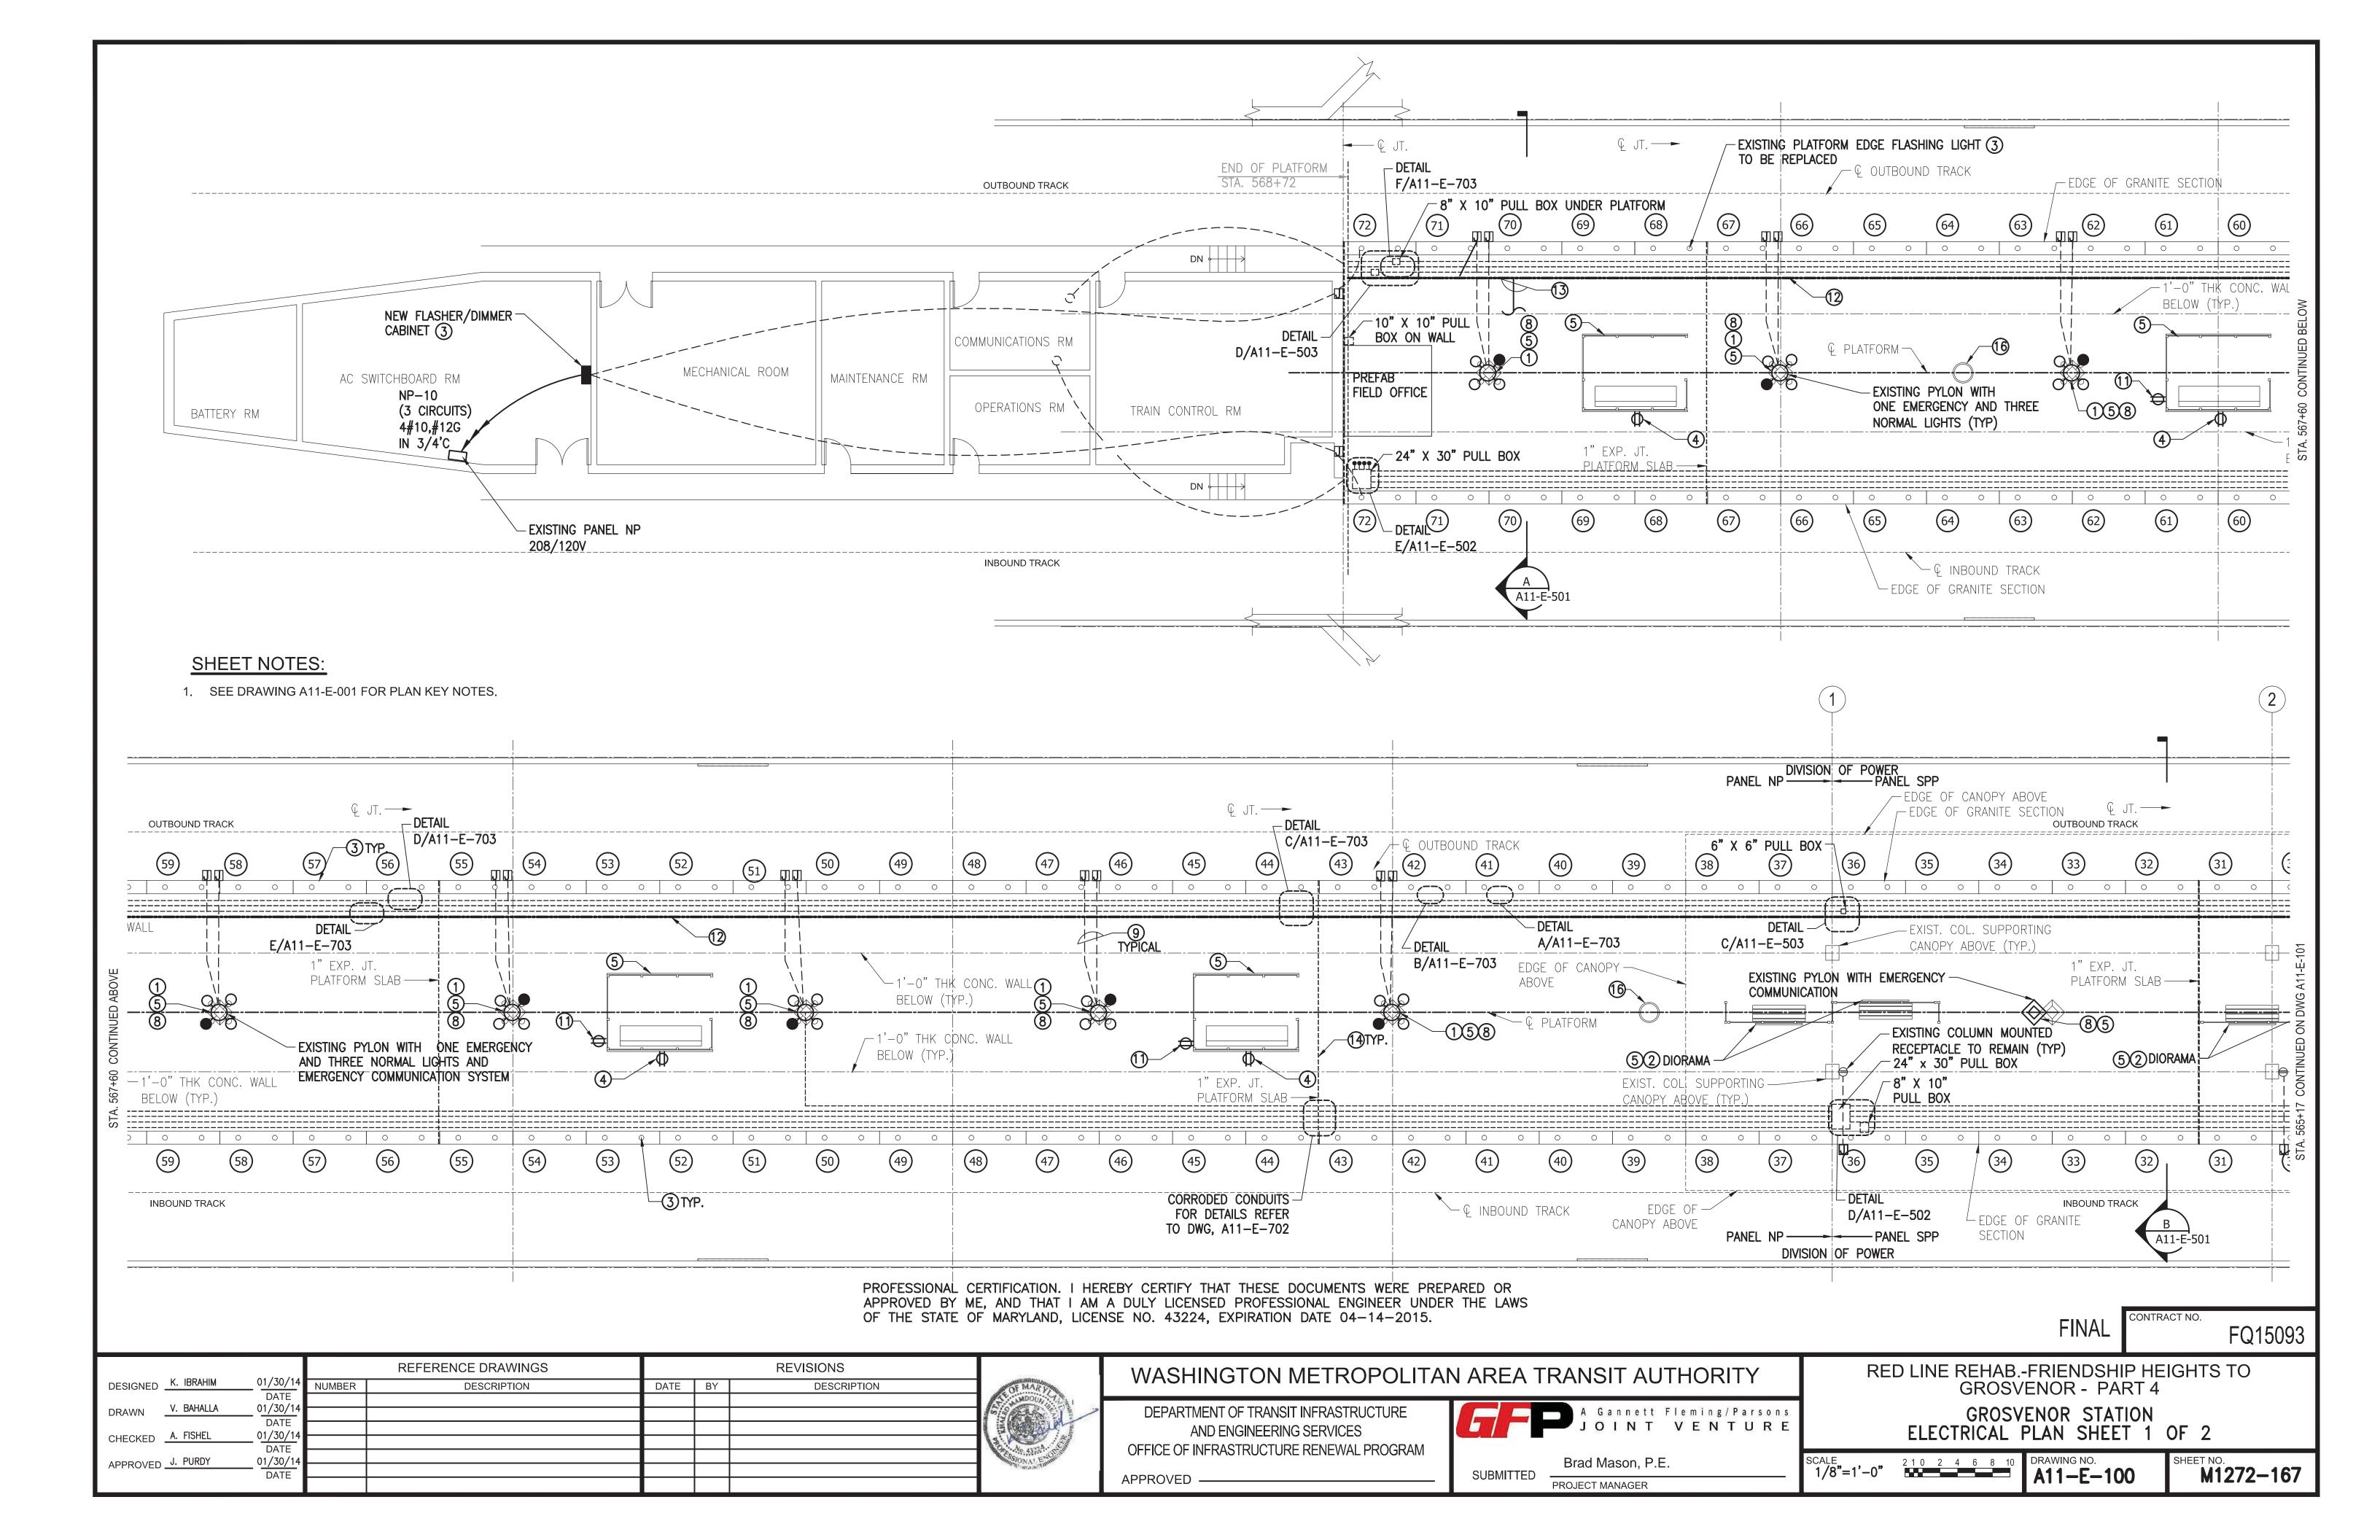

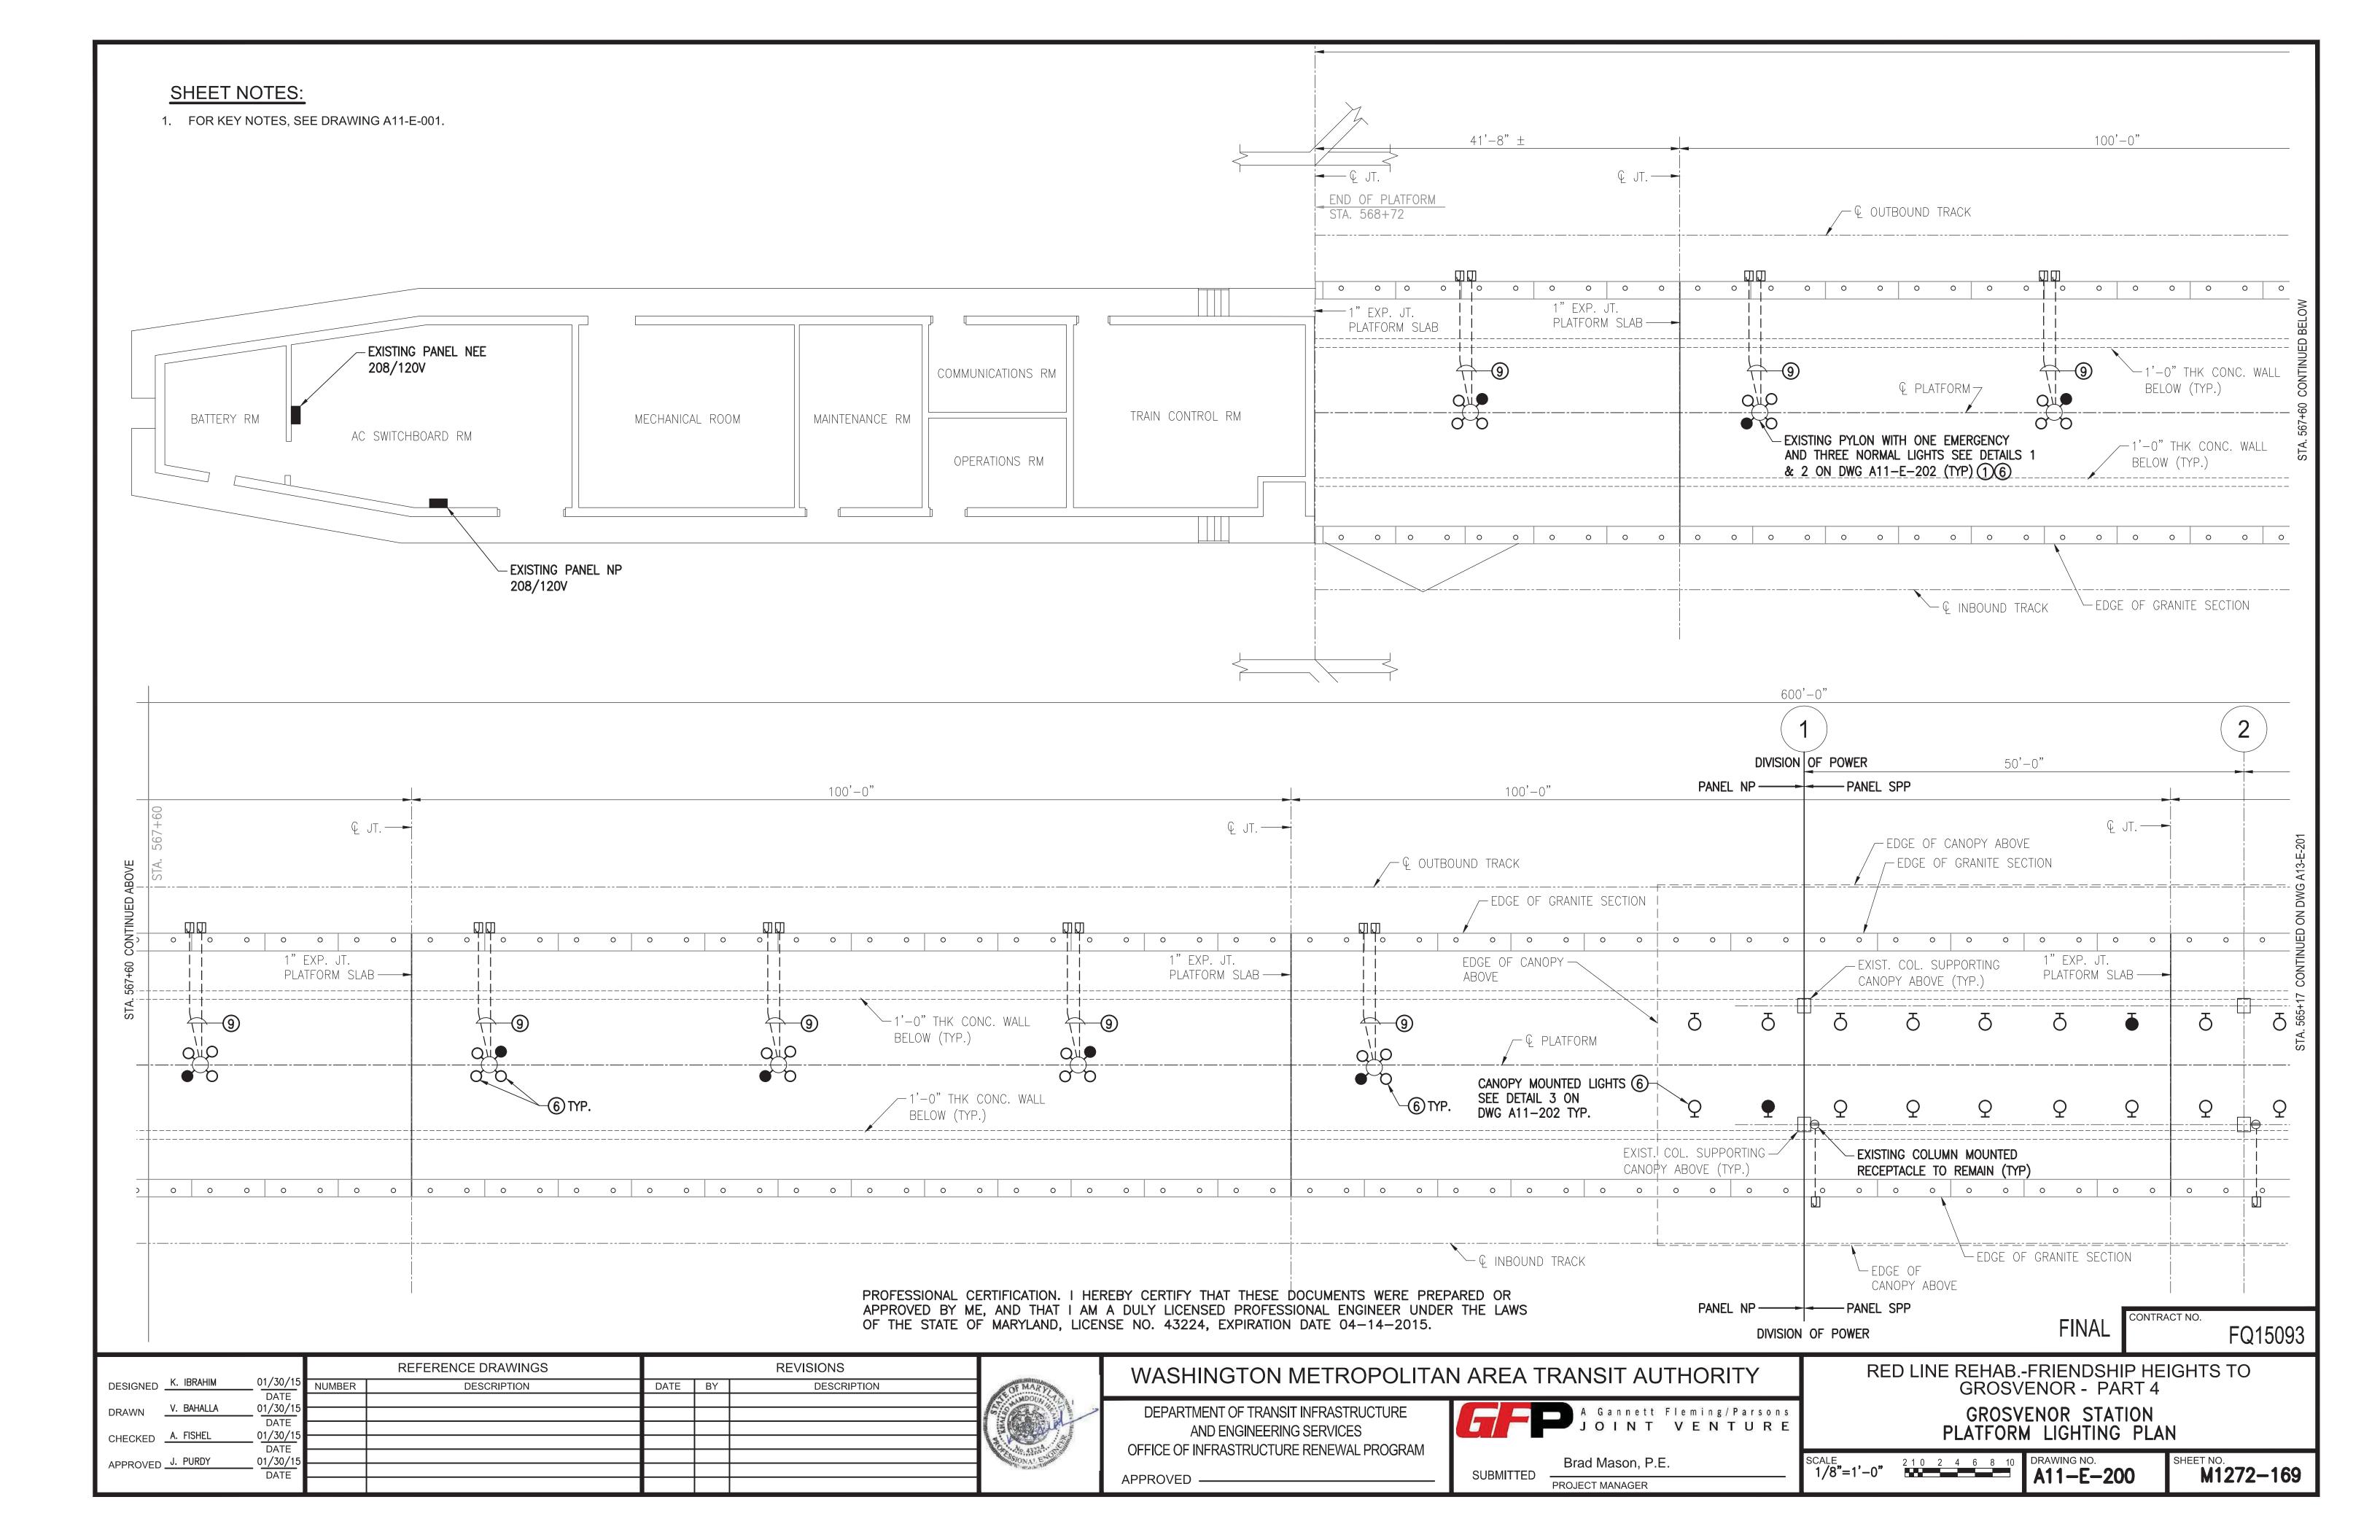


|                        | LIGHTING FIXTURE SCHEDULE  |                               |       |          |  |              |  |  |  |  |  |  |
|------------------------|--|-------------------------------|-------|----------|--|--------------|--|--|--|--|--|--|
| TYPE                   | DESCRIPTION  | LAMPS                         | VOLTS | MOUNTING | MANUFACTURER MODEL NO.                     | NOTES        |  |  |  |  |  |  |
| PLATFORM<br>EDGE LIGHT | 9W WHITE LED ACCENT LIGHT WITH INTEGRAL TRANSFORMER AND LED DRIVER, WE LOCATION LISTED (IP66), SEALED, DIE-CAST ALUMINUM CONSTRUCTION, MEDIUM FLOOD DISTRIBUTION | 9W LED<br>ARRAY<br>(INTEGRAL) | 120V  | YOKE     | HYDREL<br>4620-LED-WHT30K-120-MFL-YM-LP-BL | BLACK FINISH |  |  |  |  |  |  |


SEE NOTE 1

#### NOTES:

LED EDGE LIGHTING SHALL BE YOKE MOUNTED AND FASTENED TO THE PLATFORM SLAB OR JUNCTION BOX WITHIN THE DETAILED LIGHT OPENING MOUNTING YOKE SHALL BE CONSTRUCTED OF ALUMINUM ALLOY 6063 AND AFFIXED USING STAINLESS STEEL FASTENERS. LED LIGHT SHALL BE MOUNTED IN THE EDGE LIGHT OPENING SUCH THAT THE LENS IS CENTERED UNDER THE GLASS LENS IN THE GRANITE EDGE PIECE ABOVE. MANUFACTURER TO SUBMIT DETAILED CUT SHEET INCLUDING YOKE MOUNT FASTENING, AND CONFIGURATION OF THE LED LIGHT IN THE PROVIDED EDGE LIGHT OPENING TO THE AUTHORITY'S REPRESENTATIVE FOR REVIEW AND APPROVAL PRIOR TO THE MANUFACTURE OR INSTALLATION OF MATERIALS. DISSIMILAR SURFACE ISOLATION - PAINT ALUMINUM SURFACES AT POINT OF CONTACT WITH CONCRETE CONSTRUCTION WITH ONE COAT (MINIMUM DRY MIL THICKNESS - 5.0 MILS) OF BITUMINOUS PAINT, MYLAR ISOLATORS, OR OTHER APPROVED MATERIAL.


## SECTION @ PLATFORM EDGE

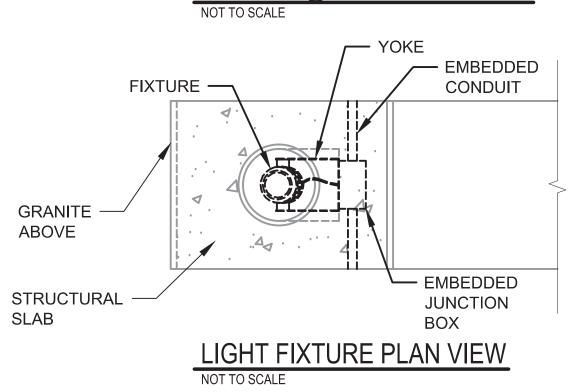

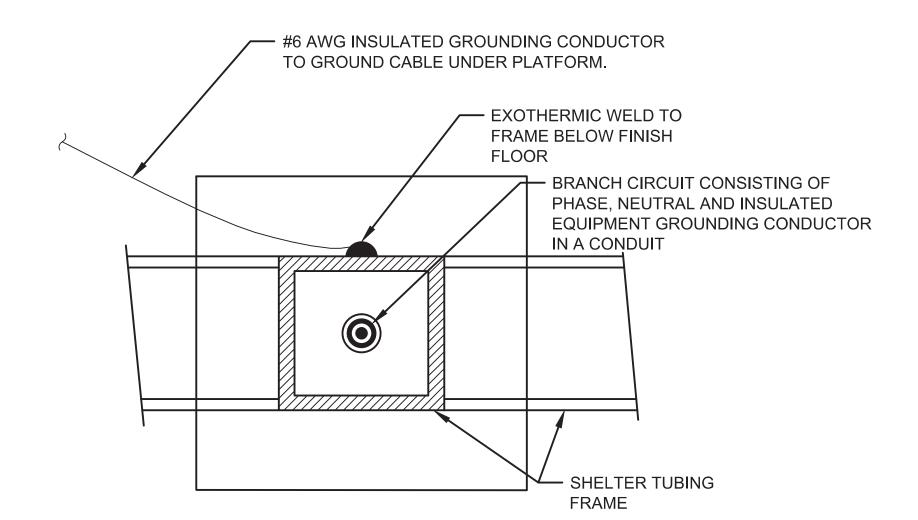


## FRAME GROUNDING FOR PLATFORM PASSENGER SHELTER AT ELECTRICAL POWER ENTRY COLUMN

NOT TO SCALE

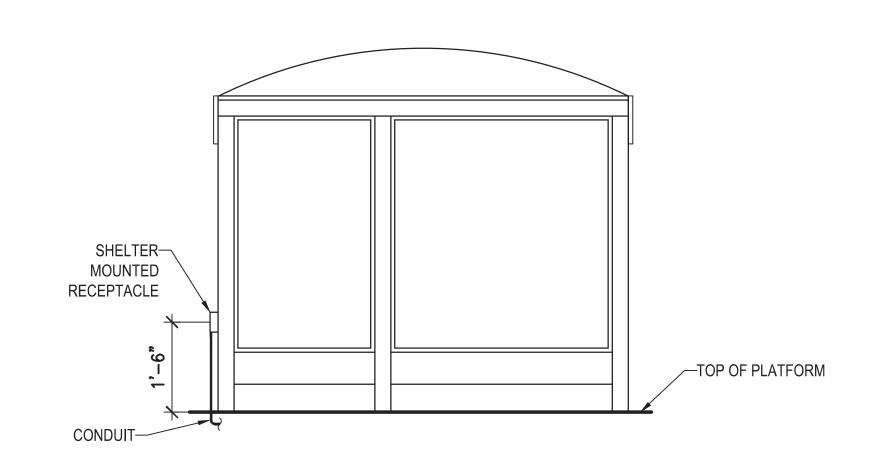



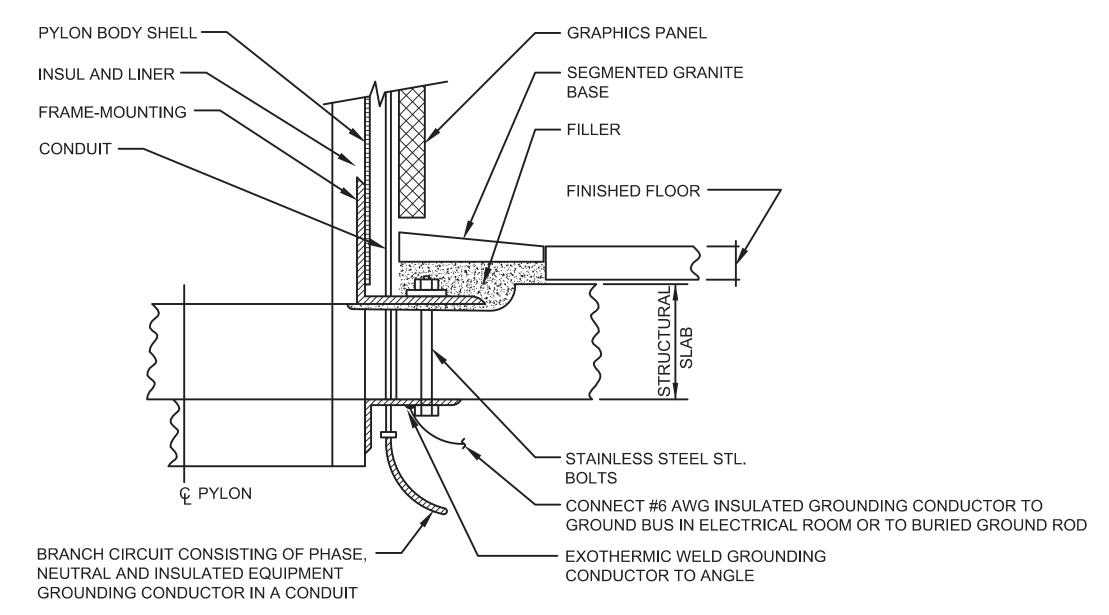

#### PLATFORM PYLON GROUNDING NOT TO SCALE

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APPROVED -

REFERENCE DRAWINGS REVISIONS DESIGNED K. IBRAHIM 01/30/15 DATE NUMBER DESCRIPTION DATE BY DESCRIPTION 01/30/15 DATE 01/30/15 DATE CHECKED A. FISHEL 01/30/15 DATE APPROVED J. PURDY



## WASHINGTON METROPOLITAN AREA TRANSIT AUTHORITY

SUBMITTED

DEPARTMENT OF TRANSIT INFRASTRUCTURE AND ENGINEERING SERVICES OFFICE OF INFRASTRUCTURE RENEWAL PROGRAM



Brad Mason, P.E.

PROJECT MANAGER


RED LINE REHAB.-FRIENDSHIP HEIGHTS TO **GROSVENOR - PART 4** 


GROSVENOR STATION - PLATFORM REMOVAL ELECTRICAL SECTIONS AND DETAILS

**FINAL** 

FQ15093


AS NOTED M1272-172 A11-E-500

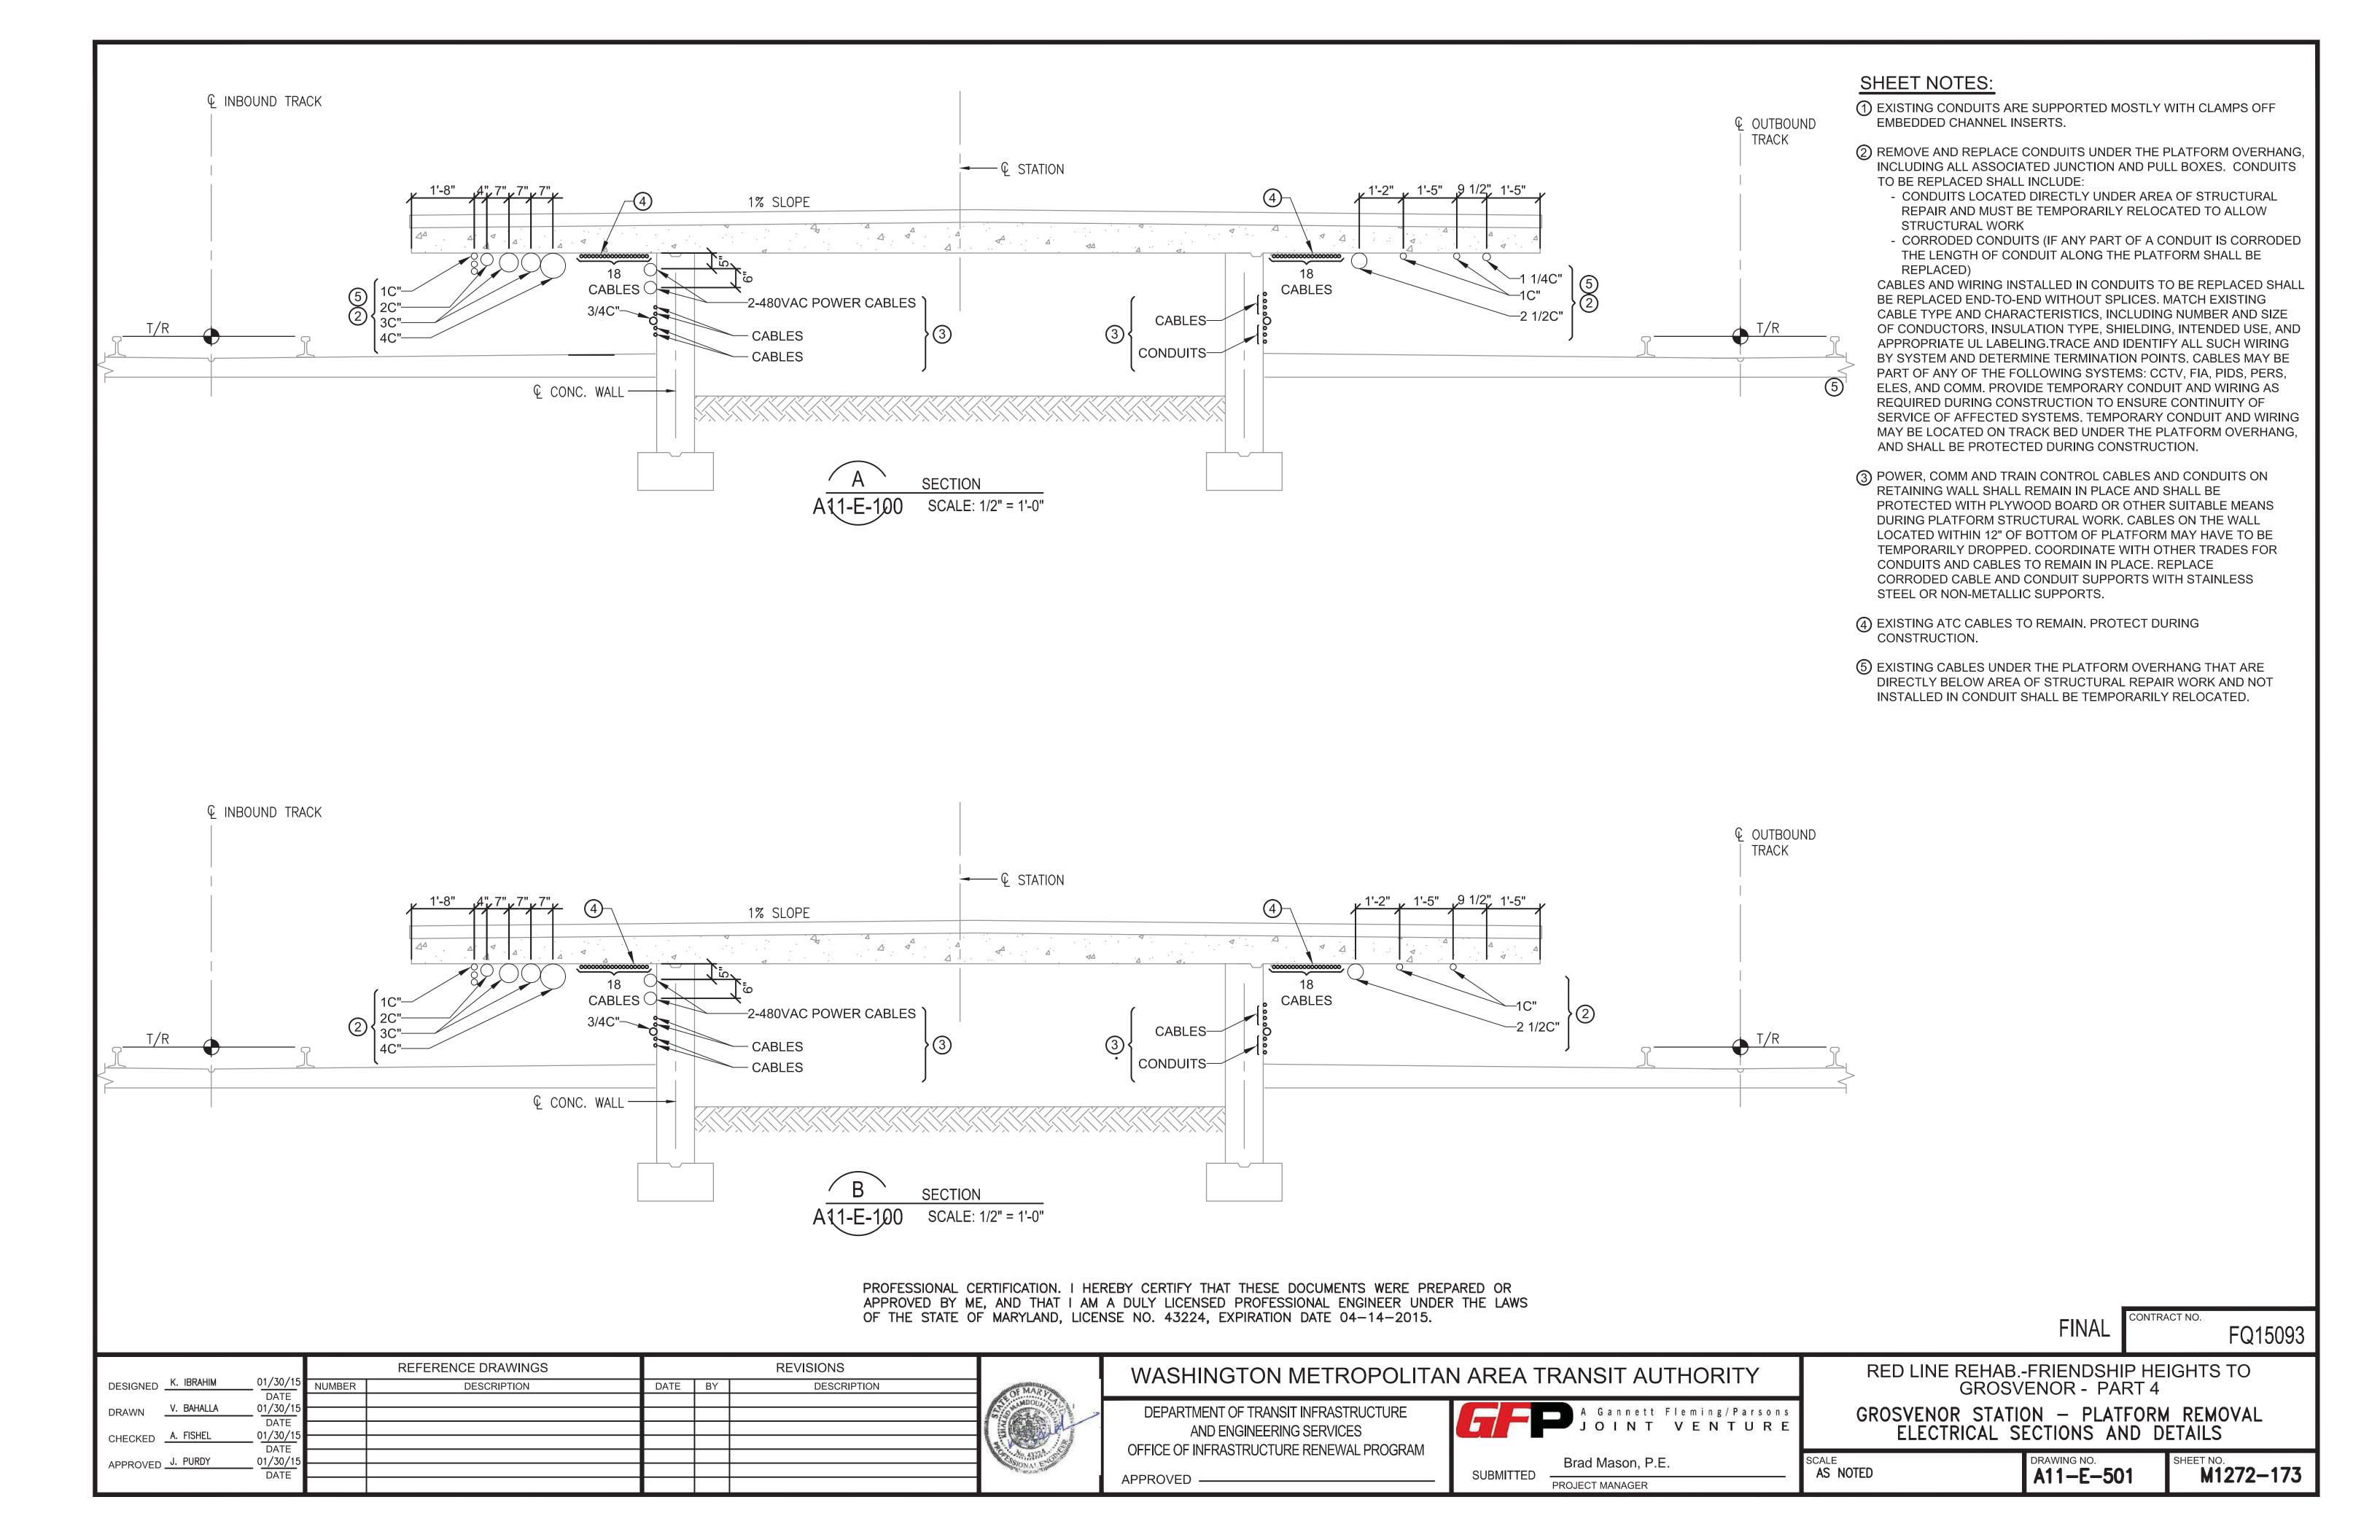

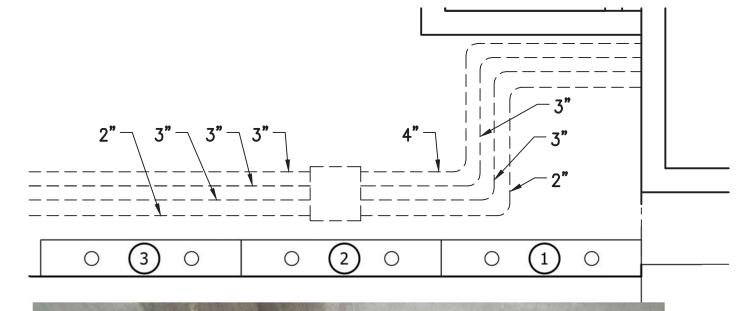




A DETAIL: PLAN & PHOTO
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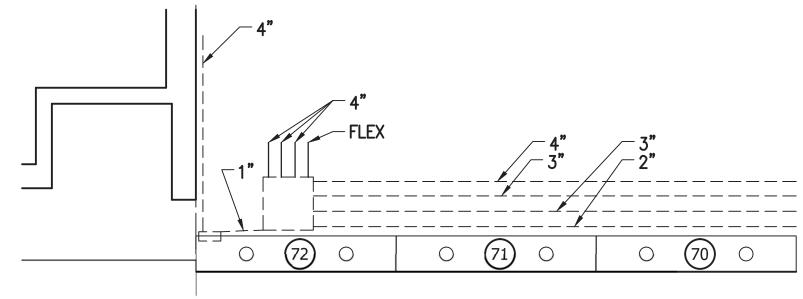

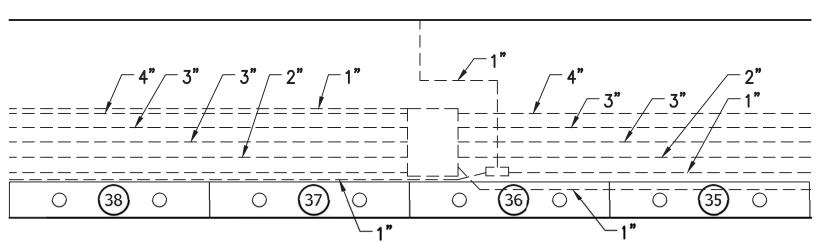
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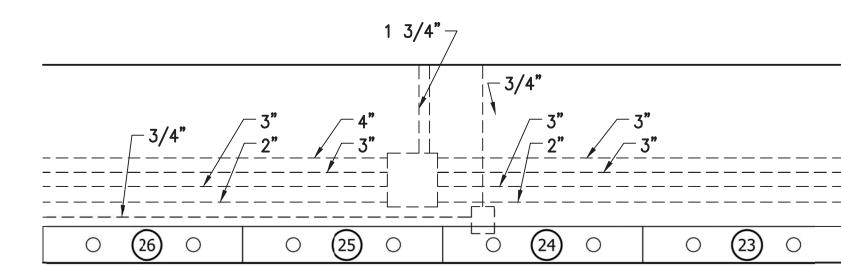
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DETAIL: PLAN & PHOTO SCALE: NOT TO SCALE

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#### SHEET NOTES

1. COORDINATE REPLACEMENT OF CORRODED OR BROKEN CONDUITS AND JUNCTION BOXES WITH WMATA AR.

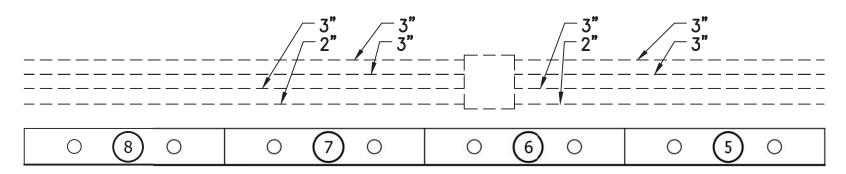REFERENCE DRAWINGS REVISIONS DESIGNED K. IBRAHIM 01/30/15 DATE NUMBER DATE BY DESCRIPTION DESCRIPTION 01/30/15 DATE CHECKED A. FISHEL 01/30/15 DATE 01/30/15 DATE APPROVED J. PURDY



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DEPARTMENT OF TRANSIT INFRASTRUCTURE AND ENGINEERING SERVICES OFFICE OF INFRASTRUCTURE RENEWAL PROGRAM APPROVED —




PROJECT MANAGER

RED LINE REHAB.-FRIENDSHIP HEIGHTS TO **GROSVENOR - PART 4** 

FQ15093


GROSVENOR STATION
EXISTING CONDITIONS — ELECTRICAL DETAILS

SCALE
AS NOTED A11-E-502 M1272-174

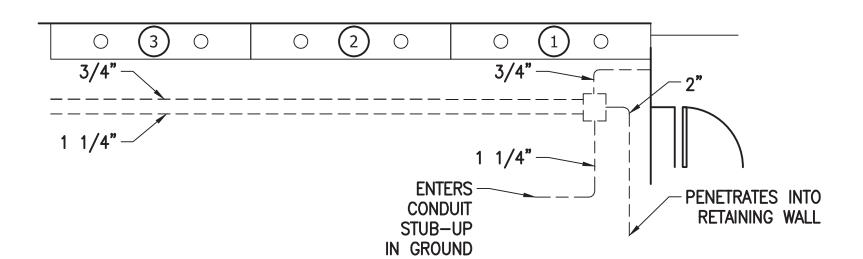






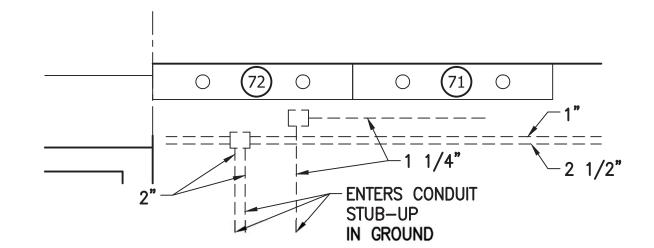




DETAIL: PLAN & PHOTO

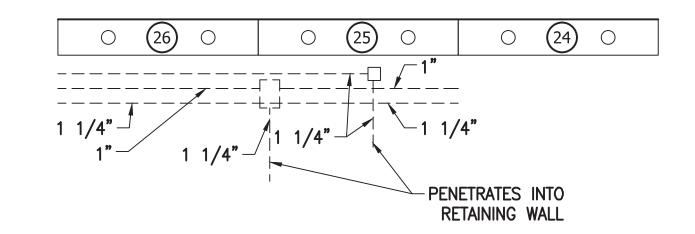





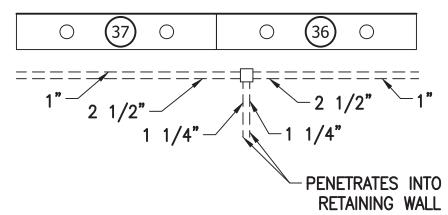







#### SHEET NOTES

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APPROVED —

REFERENCE DRAWINGS REVISIONS 01/30/15 DATE NUMBER DATE BY DESCRIPTION DESCRIPTION 01/30/15 DATE CHECKED A. FISHEL 01/30/15 DATE 01/30/15 DATE APPROVED J. PURDY



## WASHINGTON METROPOLITAN AREA TRANSIT AUTHORITY

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DEPARTMENT OF TRANSIT INFRASTRUCTURE AND ENGINEERING SERVICES OFFICE OF INFRASTRUCTURE RENEWAL PROGRAM



PROJECT MANAGER

RED LINE REHAB.-FRIENDSHIP HEIGHTS TO GROSVENOR - PART 4

FQ15093


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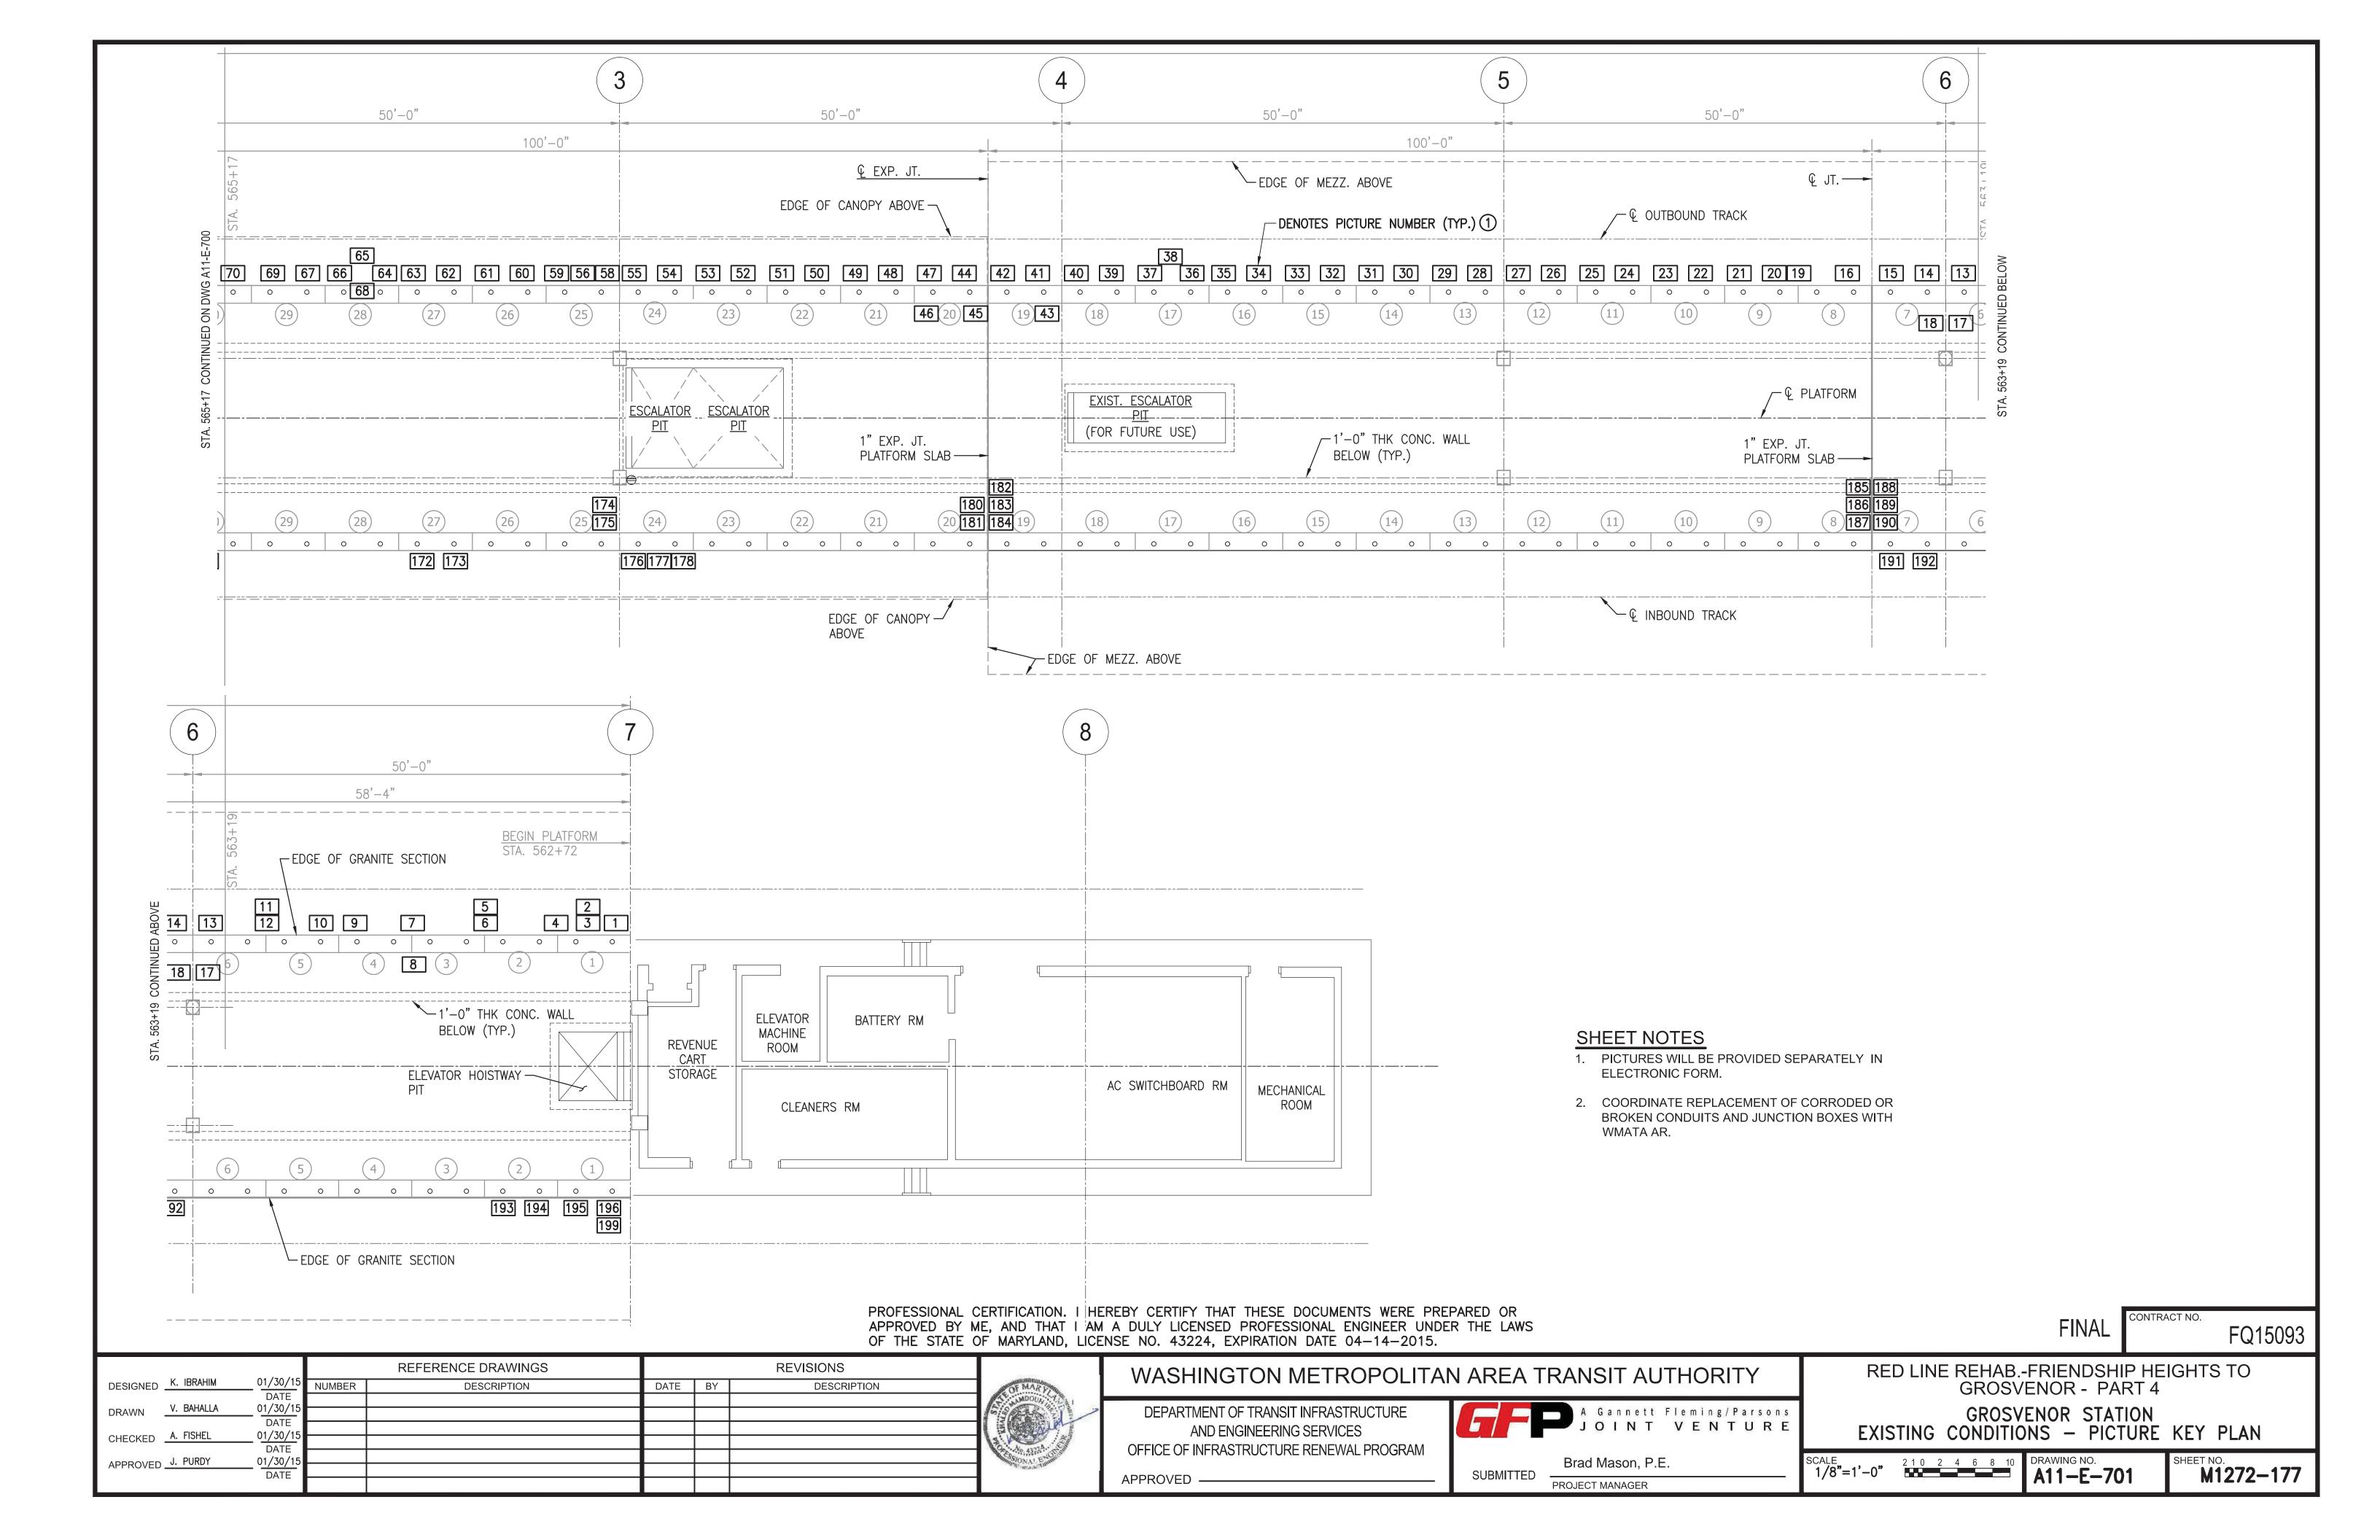
GROSVENOR STATION
EXISTING CONDITIONS — ELECTRICAL DETAILS

M1272-175

SCALE AS NOTED

A11-E-503



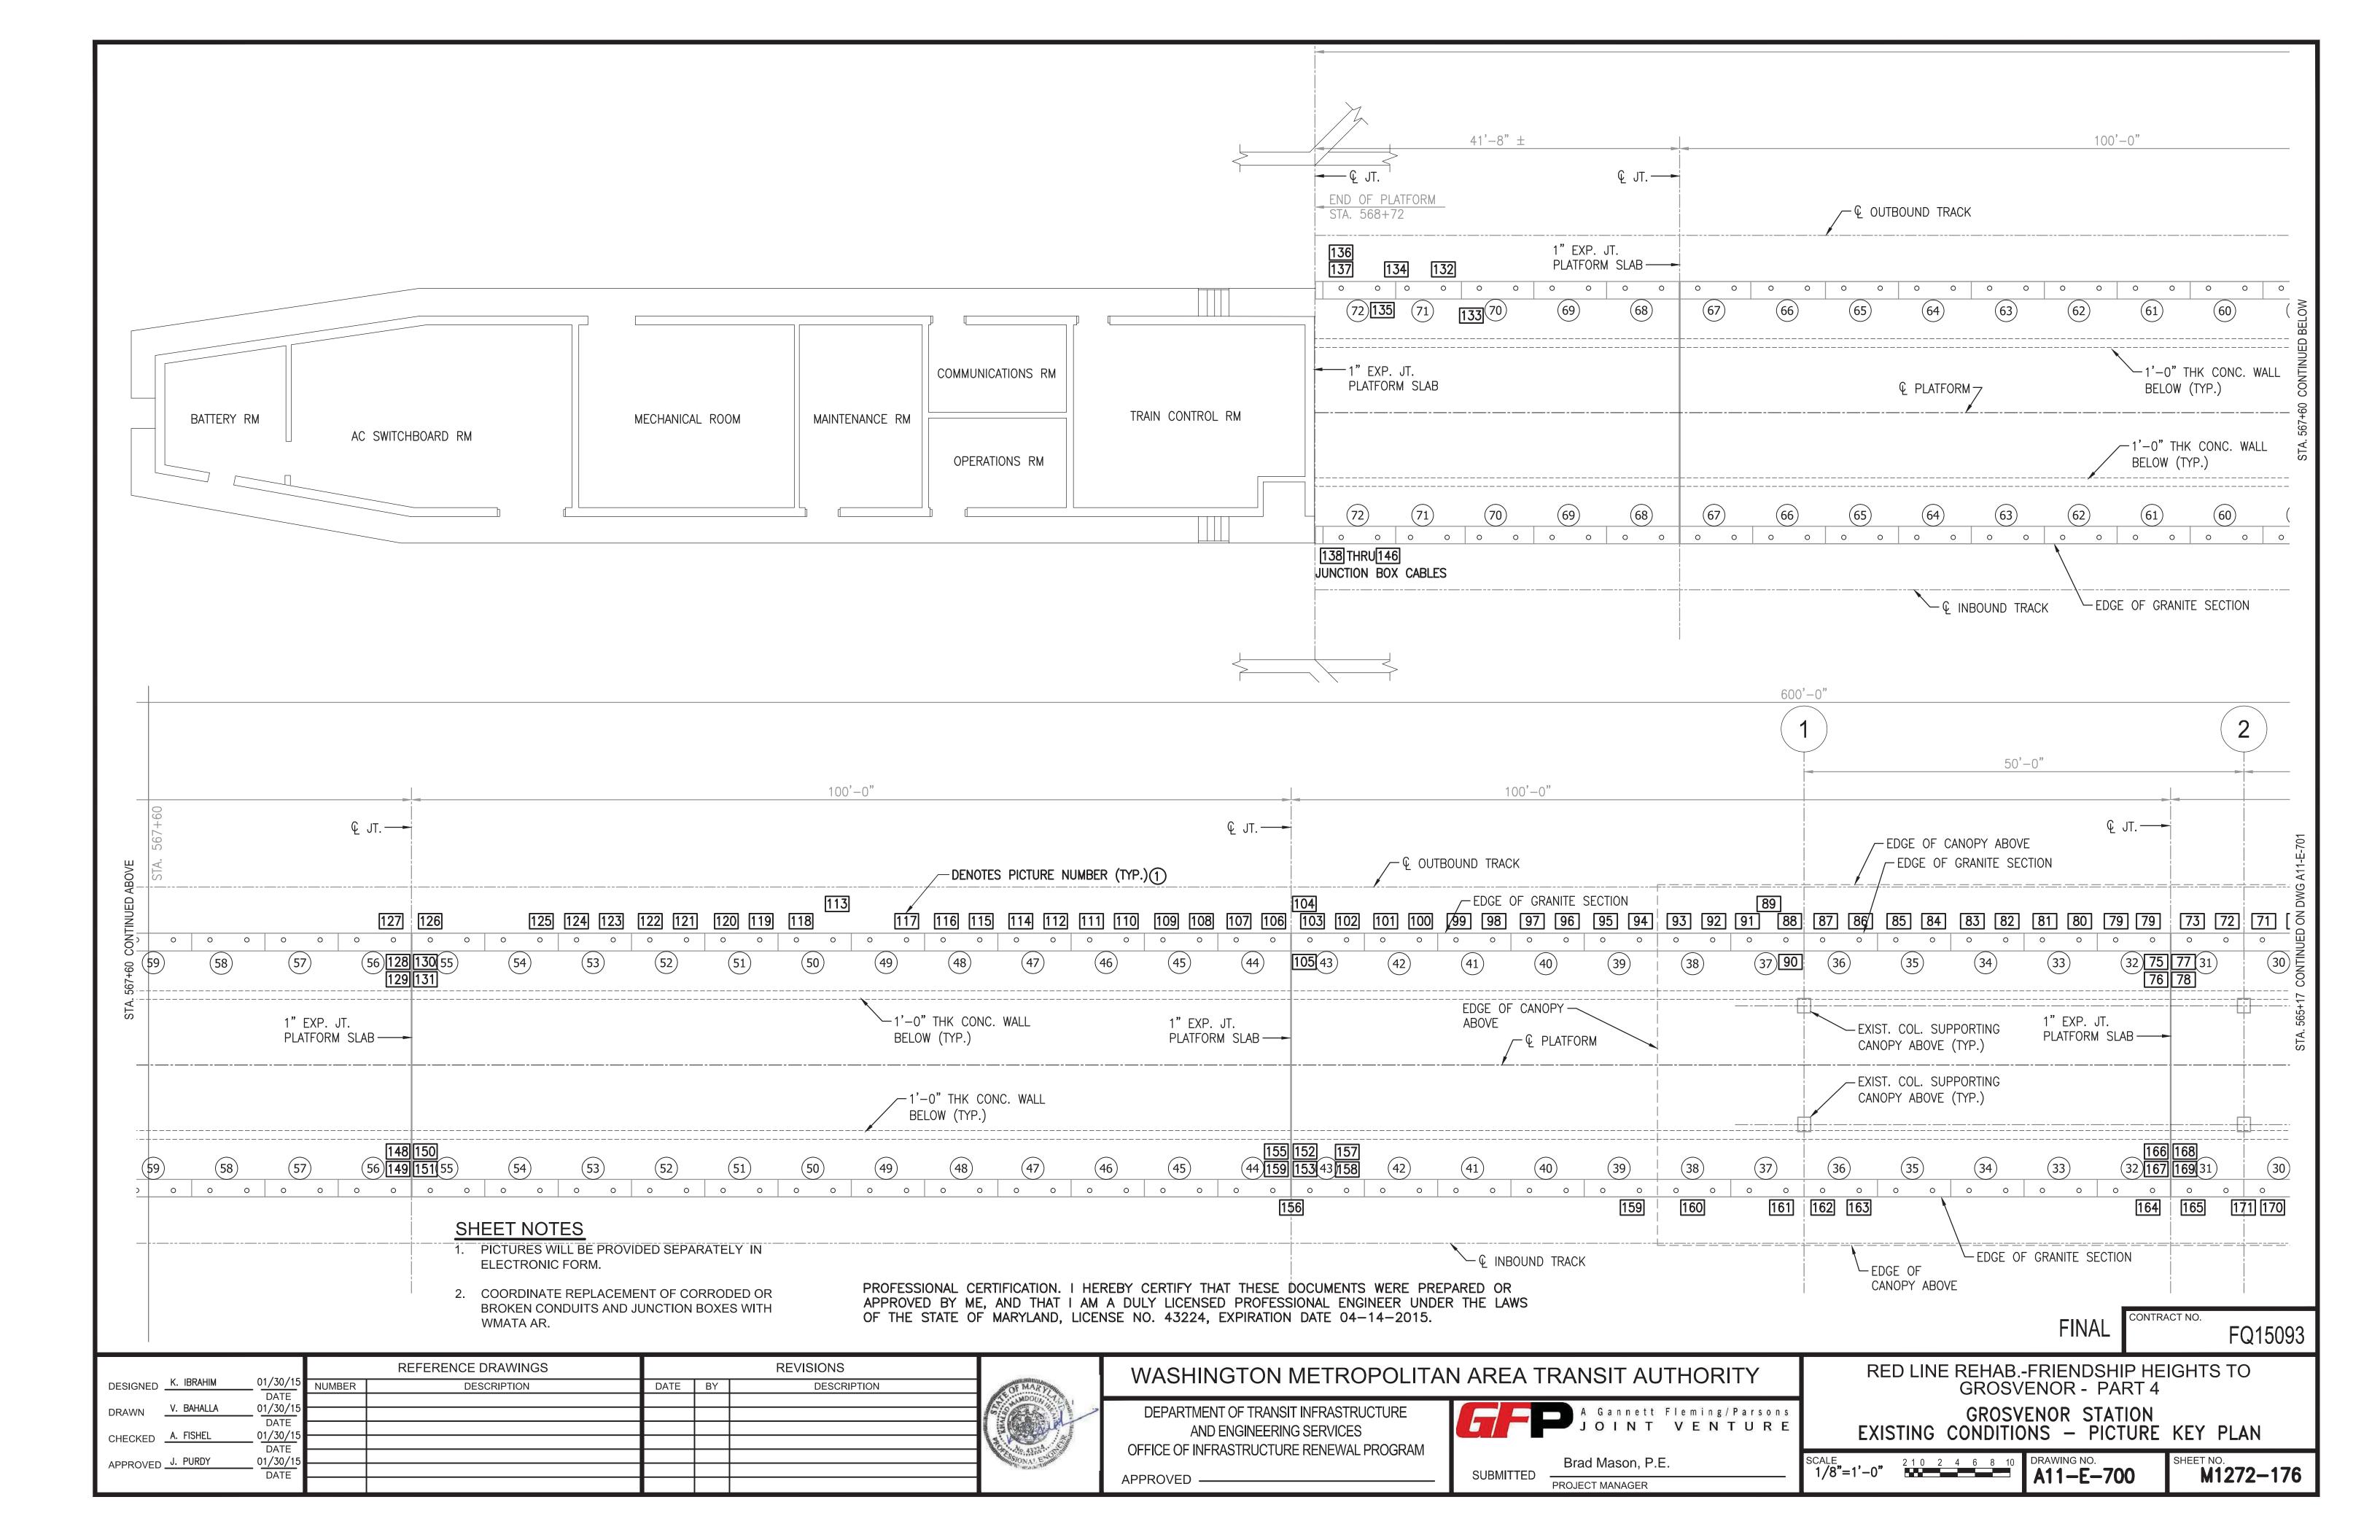



CONDUIT STUB UPS AND CABLE ROUTING AT END OF PLATFORM



TYPICAL CONDUIT CONDITION UNDER/NEAR PLATFORM EXPANSION JOINT



CONDUITS/CABLES UNDER PLATFORM OVERHANG



CONDUITS/CABLES UNDER PLATFORM OVERHANG



CONDUITS/CABLES UNDER PLATFORM OVERHANG AND OFF CONCRETE WALL

#### SHEET NOTES

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|  |        | REFERENCE DRAWINGS | REVISIONS |    |             |         |
|--|--------|--------------------|-----------|----|-------------|---------|
| DESIGNED K. IBRAHIM 01/30/15             | NUMBER | DESCRIPTION        | DATE      | BY | DESCRIPTION | - Marie |
| DATE<br>DRAWN <u>V. BAHALLA</u> 01/30/15 |        |                    |           |    |             | 6/9     |
| DATE CHECKED A. FISHEL 01/30/15          |        |                    |           |    |             | KHALES  |
| DATE APPROVED J. PURDY 01/30/15          |        |                    |           |    |             | AGE!    |
| DATE                                     |        |                    |           |    |             |         |



#### WASHINGTON METROPOLITAN AREA TRANSIT AUTHORITY

DEPARTMENT OF TRANSIT INFRASTRUCTURE AND ENGINEERING SERVICES OFFICE OF INFRASTRUCTURE RENEWAL PROGRAM APPROVED -



Brad Mason, P.E. PROJECT MANAGER

RED LINE REHAB.-FRIENDSHIP HEIGHTS TO GROSVENOR - PART 4

FINAL

GROSVENOR STATION — PLATFORM REMOVAL ELECTRICAL REPRESENTATIVE PICTURES

SCALE 1/8"=1'-0" 2 1 0 2 4 6 8 10 DRAWING NO. A11-E-702

M1272-178

FQ15093